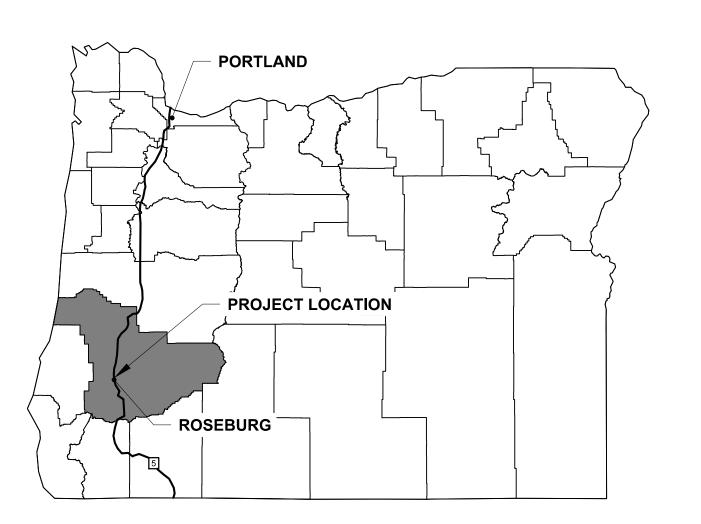
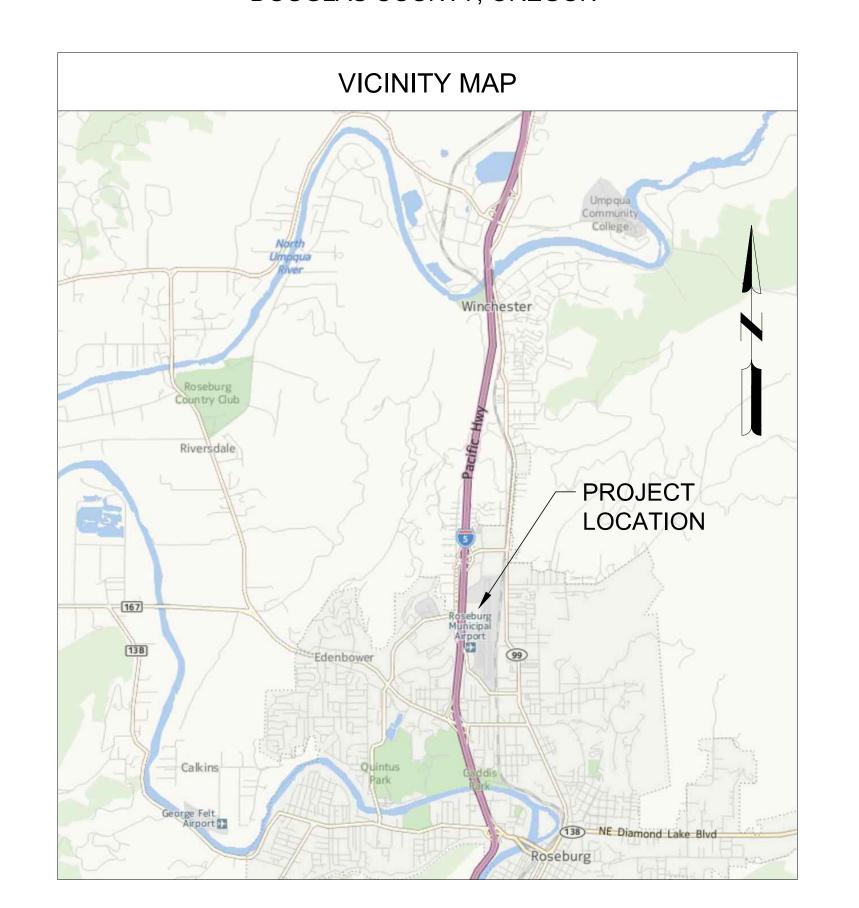
# ROSEBURG REGIONAL AIRPORT

TAXIWAY A EXTENSION
3896 NW STEWART PARKWAY
ROSEBURG, OR 97470
AIP NO. 3-41-0054-030-2024


PROJECT #22GR18
APRIL 18, 2024



DOUGLAS COUNTY, OREGON




## **UTILITY CONTACTS**

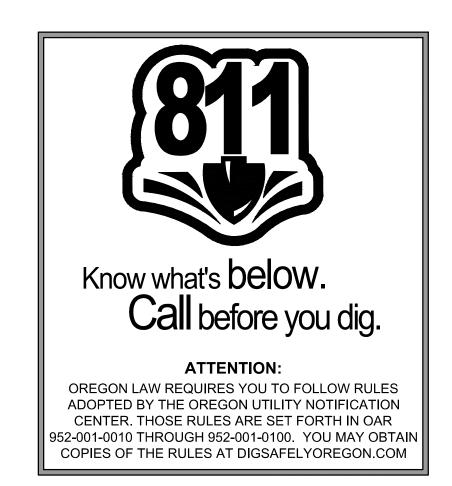

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TAXIWAY A EXTENSION

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DATE: APRIL 18, 202
DESIGNED BY: MJK
DRAWN BY: SDB
CHECKED BY: RJB
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SHEET CONTENTS

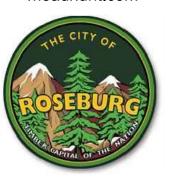COVER SHEET

SHEET NO. 1 of 40

G-001

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S

4

SH

(E) RUNWAY LIGHTING

(E) CURB INLET (DI)

(E) WATER VALVE

(E) STORM MANHOLE

(E) LIGHT/SIGNAL POLE

(E) ELECT. METER BASE

(E) UNDERGROUND VAULT

(E) RUNWAY/TAXIWAY LIGHT

(N) SHOULDER AB PAVEMENT

(N) STORM DRAINAGE INLET

(N) STORM MANHOLE

(N) PCC SIDEWALK

CONTROL POINT

BENCHMARK

(N) FULL STRENGTH HMA PAVEMENT

CONCRETE RETAINING WALL AND BLAST DEFLECTOR

(E) SAN. HOOKUP

(E) TRANSFORMER

(E) ELECT. BOX

(E) WATER SERVICE SHUTOFF

(E) POWER POLE

(E) PHONE PED

(E) MAIL BOX

(E) CATCH BASIN (CB)

(E) SANITARY CLEANOUTS

(E) SANITARY MANHOLE (MH)

GEOTECHNICAL TEST BORE HOLE

(E) CHAIN LINK FENCE (E) WATER LINE (E) STORM SEWER (E) SANITARY SEWER

(N) SEDIMENT FENCE

(N) EDGE OF PAVEMENT

(N) EDGE OF SHOULDER

(N) EDGE OF BLAST PAD

(E) FIBER OPTIC (DFN)

(E) GAS

LOW-PROFILE BARRICADES

(E) POWER (UNDERGROUND)

(E) EDGE OF PAVEMENT RUNWAY OBJECT FREE AREA TAXIWAY OBJECT FREE AREA

> **RUNWAY SAFETY AREA** TAXIWAY SAFETY AREA TAXIWAY OBJECT FREE AREA

LF LT **OBSTACLE FREE ZONE** MAX МН MANHOLE (N) GAS LINE MIN (N) STORM LINE (N)

(N) SUBDRAIN LINE NATIONAL GEODETIC VERTICAL DATUM NGVD (N) ELECTRICAL LINE NTS NOT TO SCALE

> O/S OFFSET

ODOT OREGON DEPARTMENT OF TRANSPORTATION

PORTLAND CEMENT CONCRETE POUNDS PER CUBIC FOOT

PNT POINT POC POINT OF CURVE PT POINT OF TANGENCY PVC POLYVINYL CHLORIDE

POINT OF VERTICAL INTERSECTION ELEVATION

POINT OF VERTICAL INTERSECTION STATION POINT OF VERTICAL TANGENT

RED RUNWAY EDGE LIGHT **RUNWAY END LIGHT** RUNWAY OBJECT FREE AREA RUNWAY SAFETY AREA RIGHT

RUNWAY SLOPE SANITARY SEWER STORM SEWER LINE STA STATION

TAXIWAY EDGE LIGHT TAXIWAY OBJECT FREE AREA TAXIWAY SAFETY AREA

TWY TAXIWAY UT UNDERGOUND TELEPHONE

WITH WV WATER VALVE

——— FOC ———— FOC ——— \_\_\_\_\_ R/W \_\_\_\_\_ R/W \_\_\_\_ (E) RIGHT-OF-WAY —— SS ——— SS ——— ------ ROFA ------\_\_\_\_\_ TOFA \_\_\_\_\_ ——— RSA ———— RSA ——— ——— TSA ———— TSA ——— TO BE REMOVED

#### **ABBREVIATIONS**

AΒ AGGREGATE BASE **APPROX** APPROXIMATE AWG AMERICAN WIRE GAUGE BB BASE BID SCHEDULE WORK **BMPS** BEST MANAGEMENT PRACTICES CENTERLINE

CONTROLLED LOW-STRENGTH MATERIAL CLSM

CLEANOUT CO CONCRETE CONC DRAIN INLET DI DIAMETER DIA **EXISTING** (E), EX ELECTRICAL LINE **ELEVATION ELEV EDGE OF PAVEMENT** EOP FEET FT

GAS LINE HOT-MIX ASPHALT INVERT INV LENGTH LB POUND LINEAL FEET LEFT MAXIMUM

MINIMUM NEW NATIONAL GEODETIC SURVEY **NDGS** 

OFZ OBSTACLE FREE ZONE

POC POINT OF CURVATURE PCC PCF

PERF PERFORATED

PVI POINT OF VERTICAL INTERSECTION PVIE PVIS

PVT

RADIUS RCP REINFORCED CONCRETE PIPE

REL ROFA RSA RT

RWA RESTRICTED WORK AREA RWY ST

STRM STORM TEL **TOFA** TSA

WATER LINE **WORK AREA** 

(N) ELEVATED RUNWAY EDGE LIGHT (RED)

(N) CLEANOUT

(N) ELEVATED RUNWAY END LIGHT (RED/YELLOW)

(N) ELEVATED TAXIWAY EDGE LIGHT (BLUE)

(N) AIRFIELD ELECTRICAL HANDHOLE

(N) AIRFIELD JUNCTION BOX

(E) GATE

(N) GATE

**(**(0)

◁

left

PL 3/13/2012 120 AN J. BERGS 120 EXPIRES: 12 / 31 / 25

Mead and Hunt, Inc.

9600 NE Cascades Parkway,

Suite 100

Portland, OR 97220

phone: 503-548-1494

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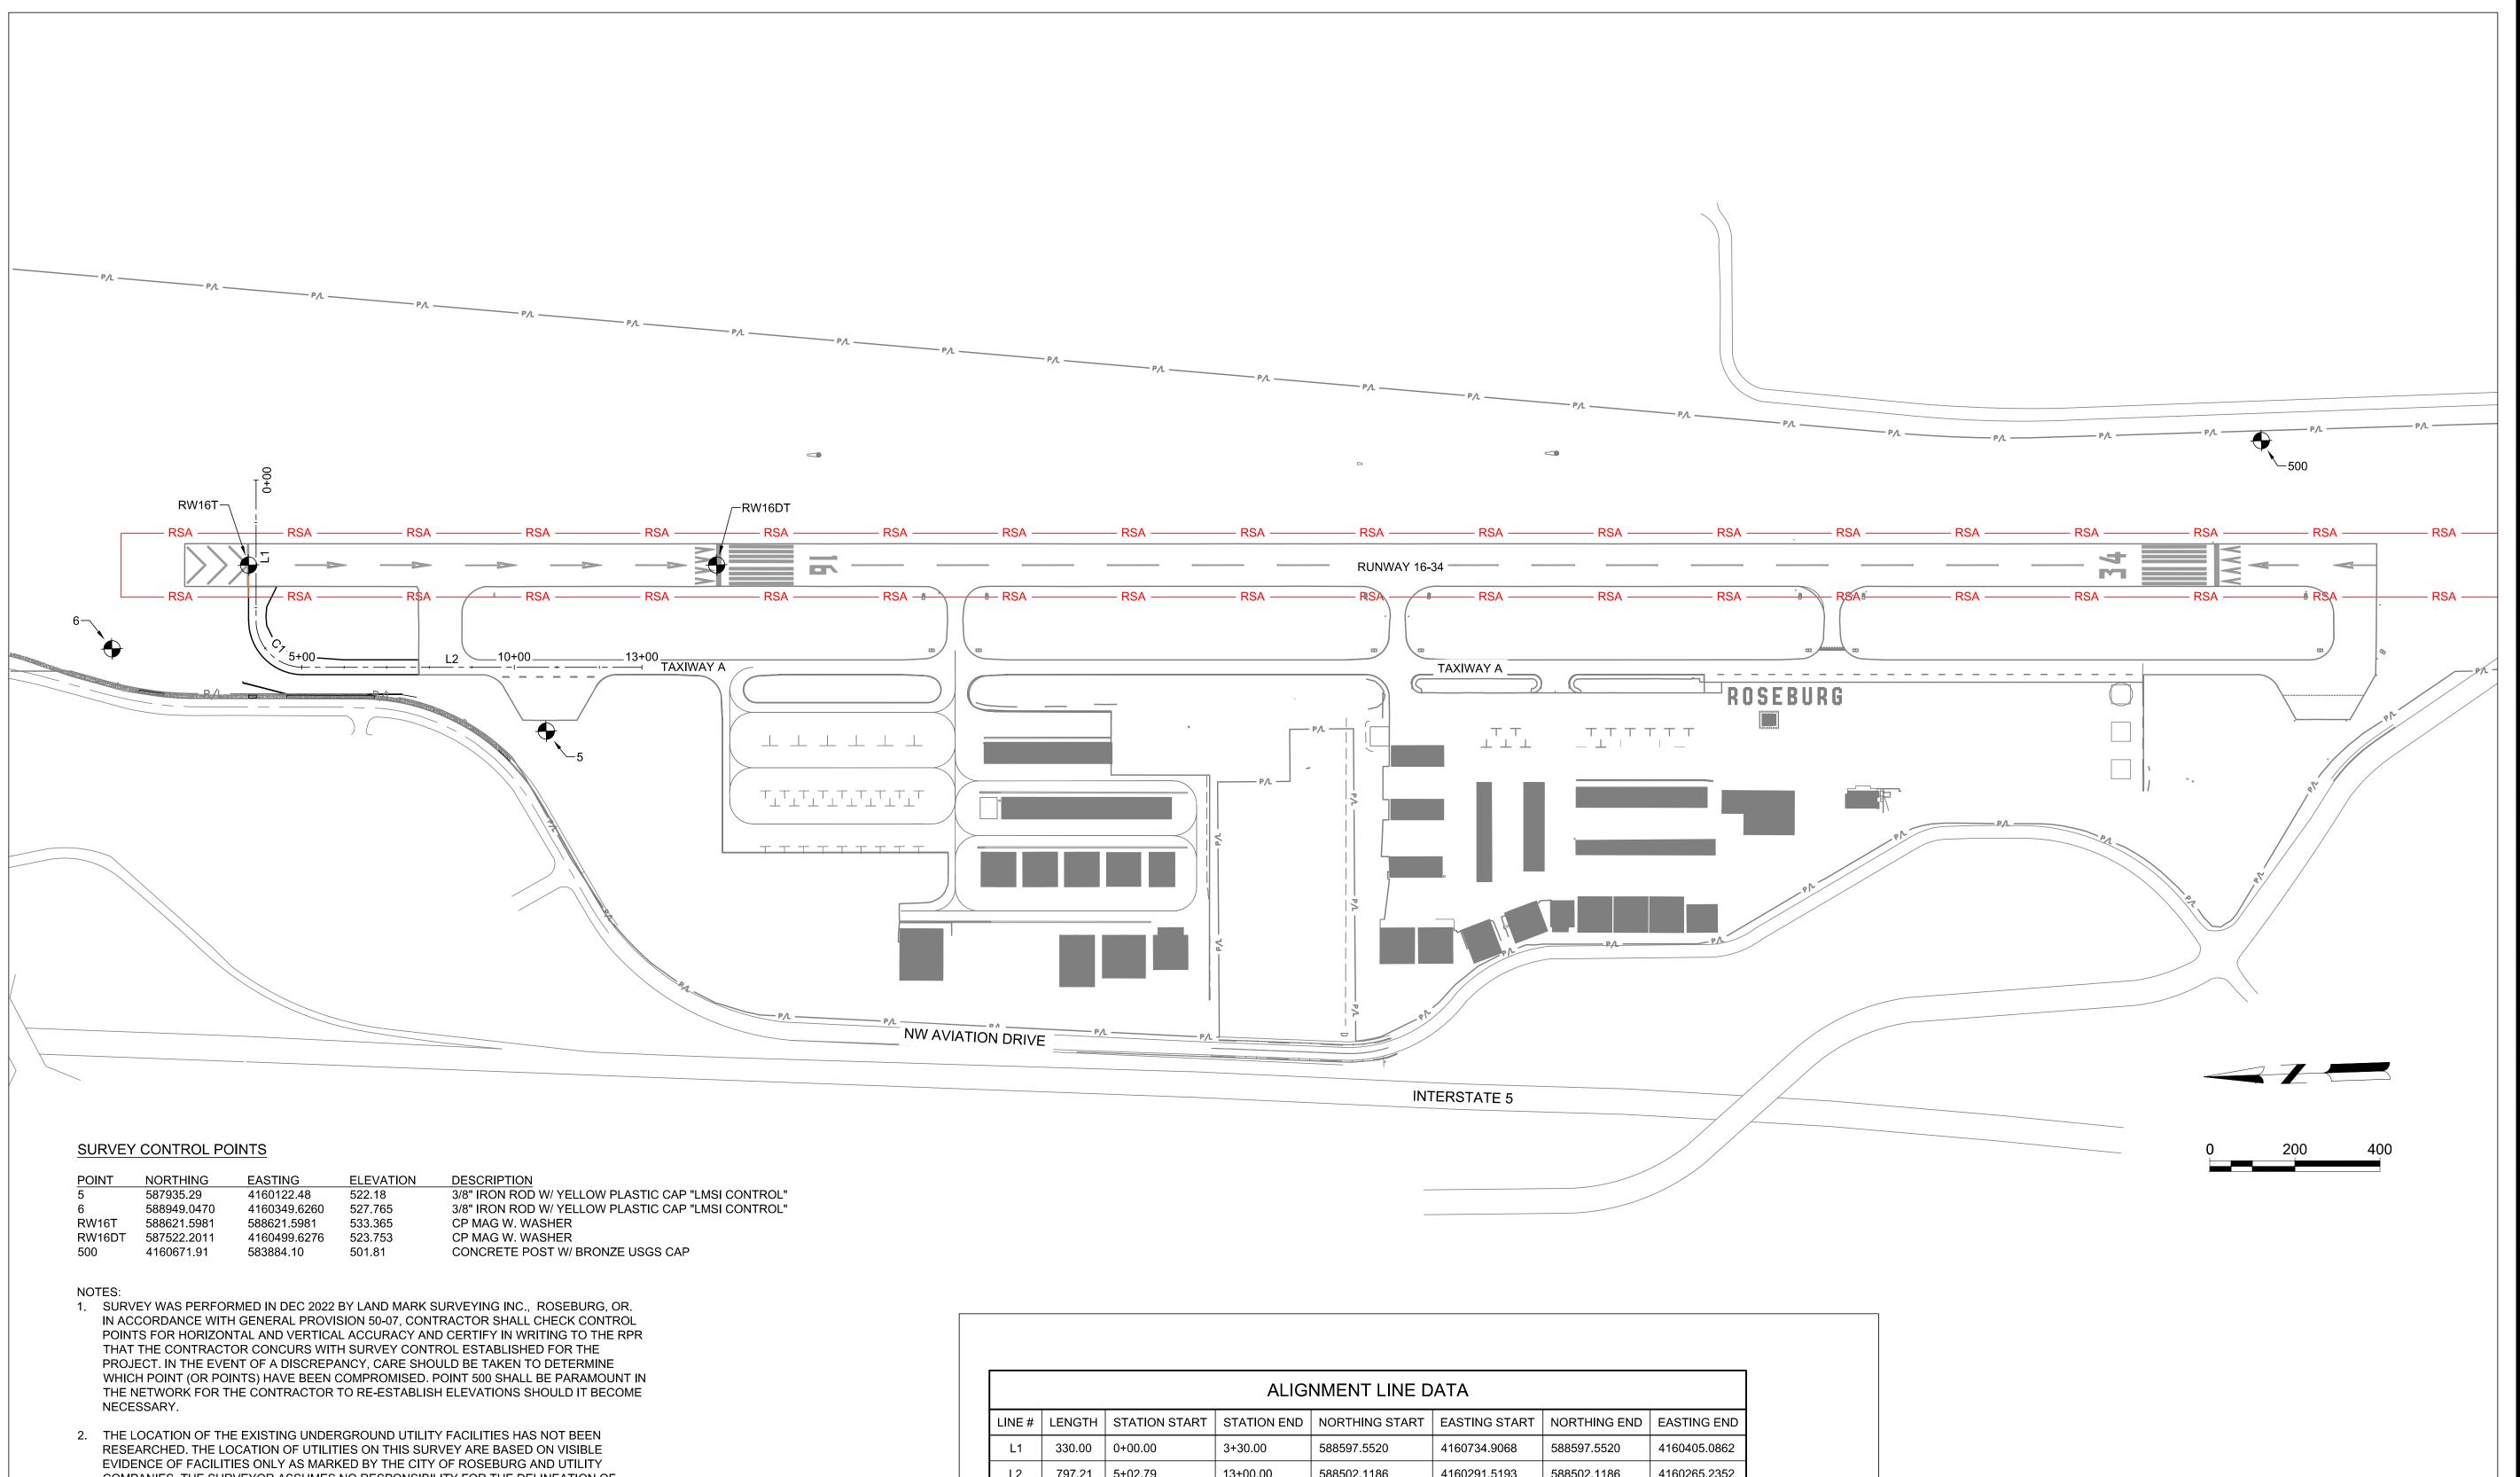
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SHEET CONTENTS GENERAL NOTES -SYMBOLS - LEGEND & **ABBREVIATIONS** 

SHEET NO. 2 of 40

G-002




- COMPANIES. THE SURVEYOR ASSUMES NO RESPONSIBILITY FOR THE DELINEATION OF SUCH UNDERGROUND UTILITIES, NOR FOR THE EXISTENCE OF BURIED OBJECTS WHICH ARE NOT SHOWN ON THIS PLAN.
- 3. HORIZONTAL DATUM OREGON STATE PLANE COORDINATE SYSTEM, SOUTH ZONE NAD 83(2007) - INTERNATIONAL FEET

VERTICAL DATUM - NAVD 88, UTILIZING NGS MONUMENT 500

	ALIGNMENT LINE DATA							
LINE#	LENGTH	STATION START	STATION END	NORTHING START	EASTING START	NORTHING END	EASTING END	
L1	330.00	0+00.00	3+30.00	588597.5520	4160734.9068	588597.5520	4160405.0862	
L2	797.21	5+02.79	13+00.00	588502.1186	4160291.5193	588502.1186	4160265.2352	

	ALIGNMENT CURVE DATA									
#	RADIUS	Δ	TANGENT	LENGTH	CENTER POINT NORTHING	CENTER POINT EASTING	PC NORTHING	PC EASTING	PT NORTHING	PT EASTING
C1	110.00'	90° 00' 00"	110.00	172.79'	588498.492	4160401.459	588608.432	4160405.086	588502.119	4160291.519
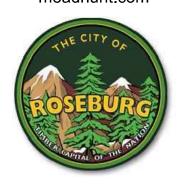
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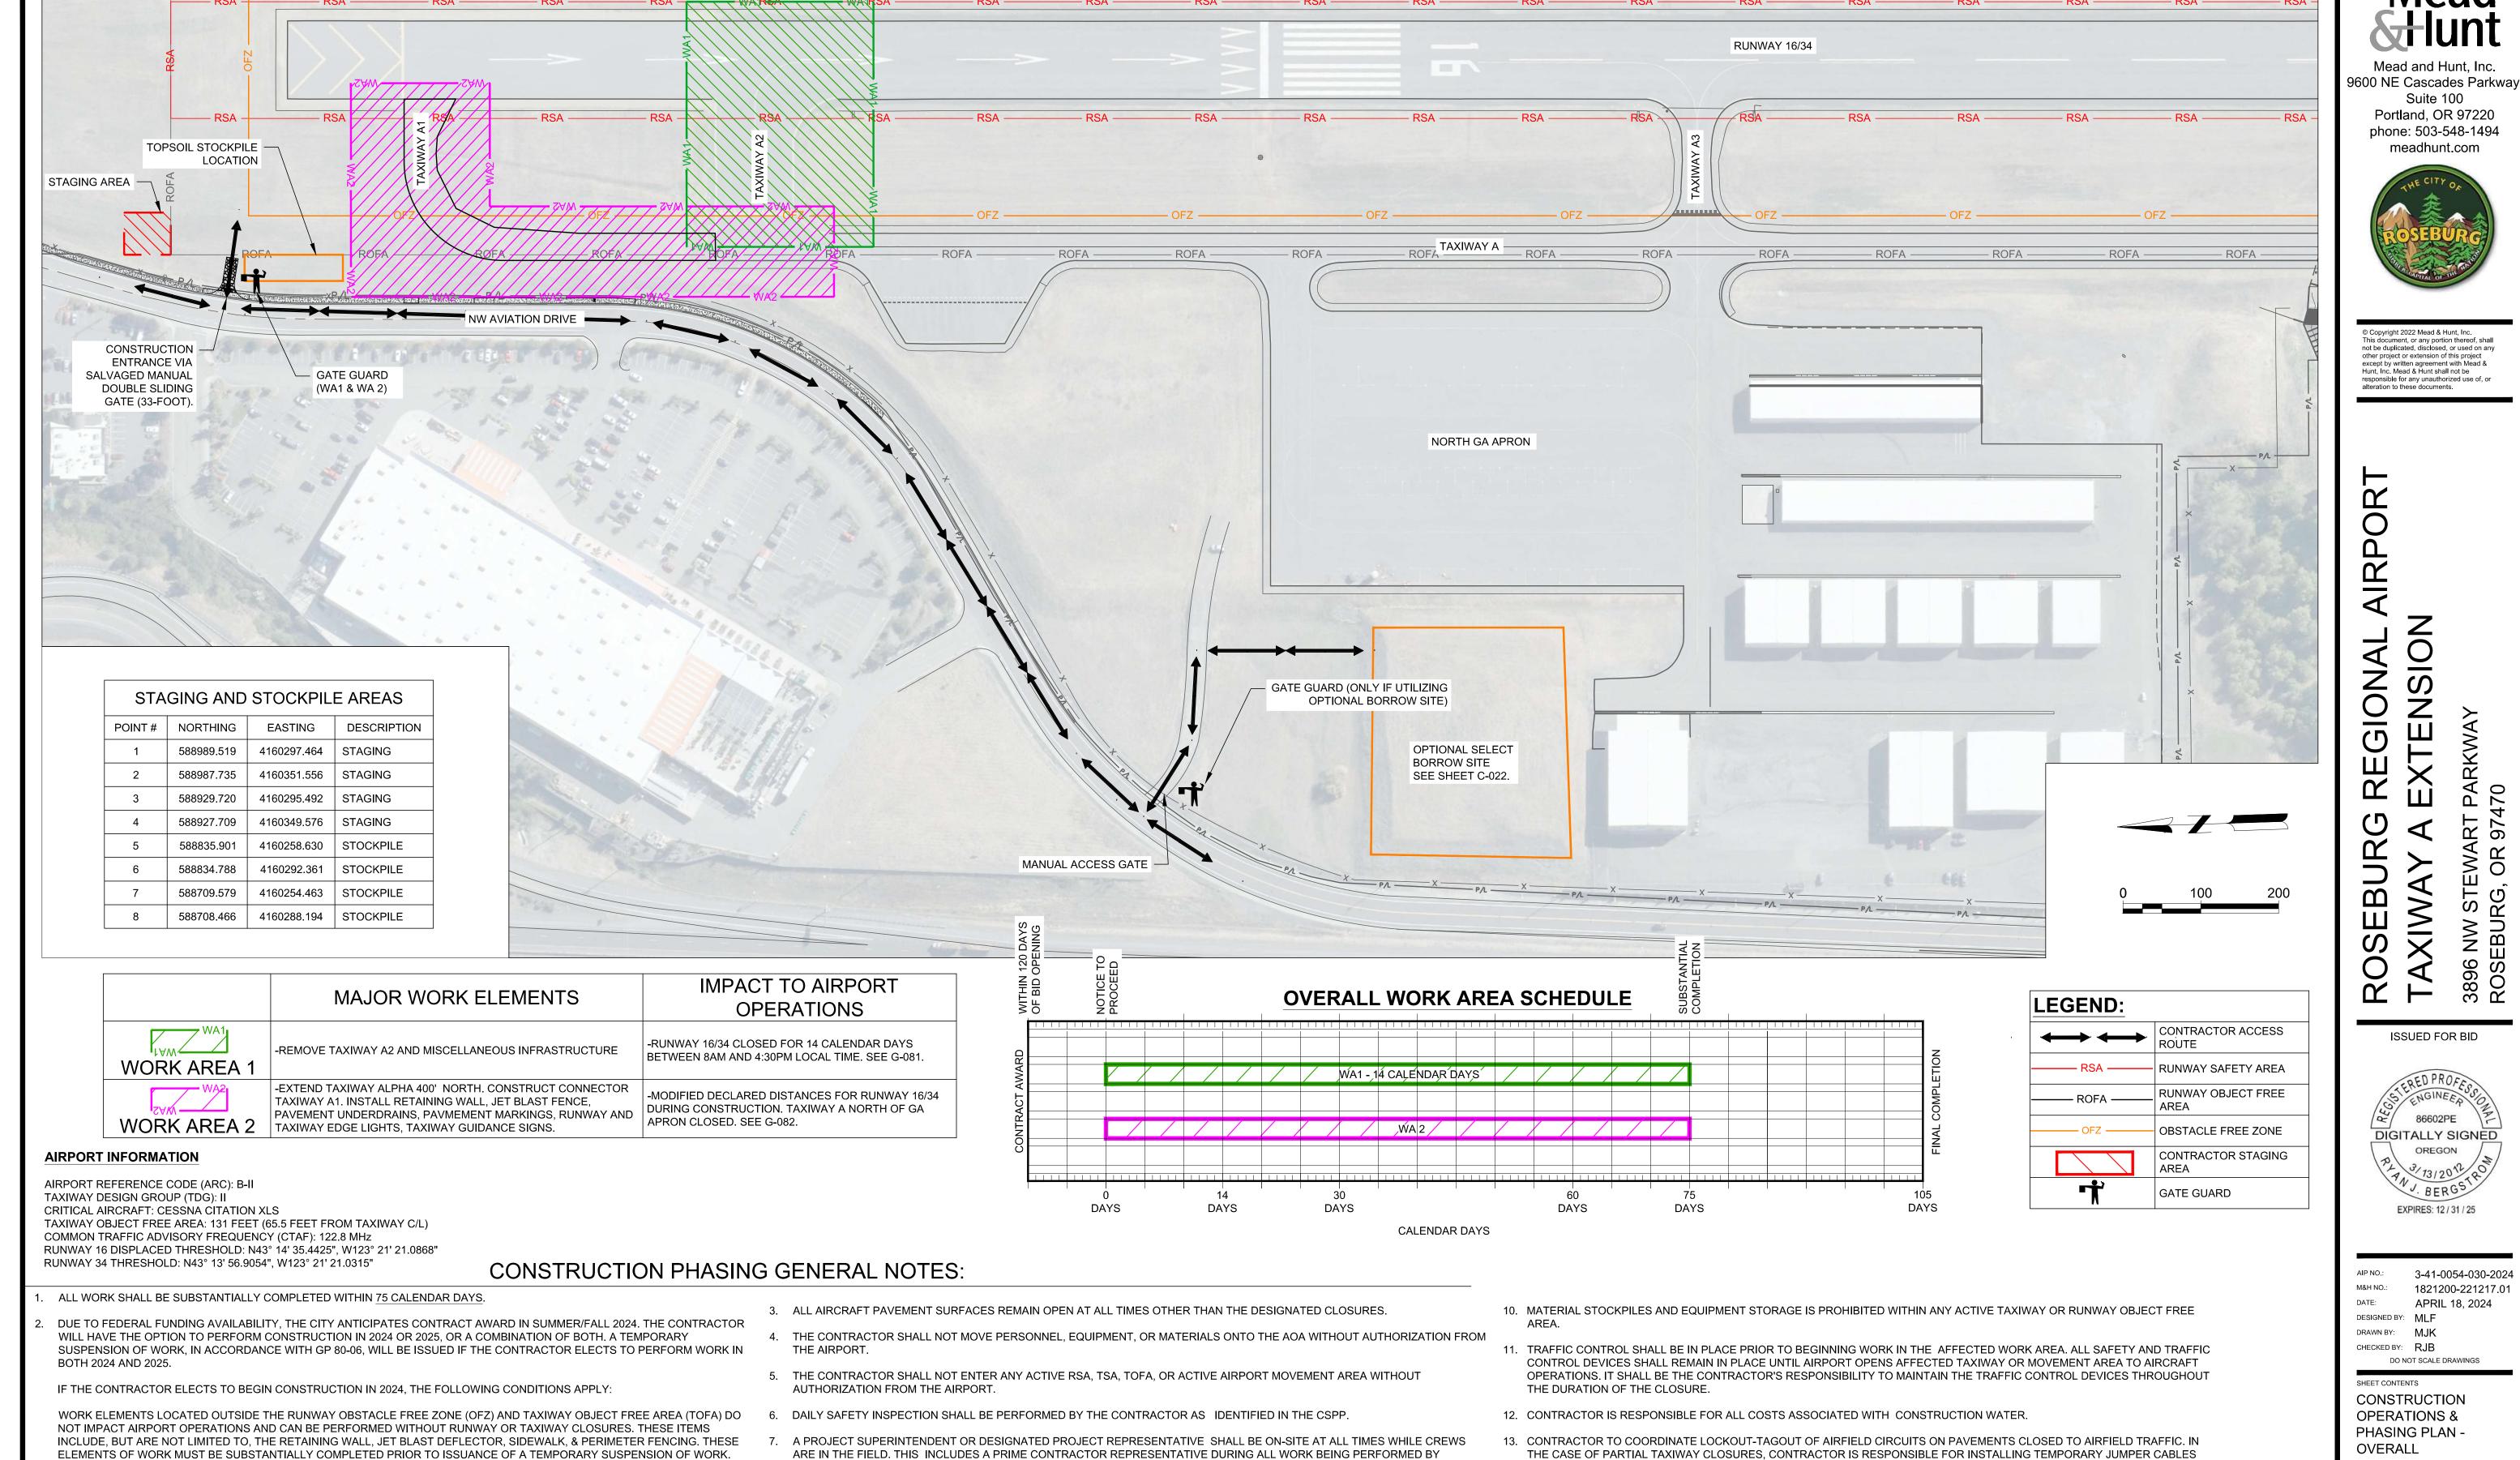


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SHEET CONTENTS SURVEY CONTROL PLAN

SHEET NO. 3 of 40



THE CONTRACTOR SHALL BE RESPONSIBLE FOR FURNISHING, DEPLOYING, MAINTAINING, RELOCATING, AND REMOVING THE

LOW-PROFILE BARRICADES AS SHOWN ON THE PLANS, OR AS DIRECTED BY THE AIRPORT. LOW PROFILE BARRICADES SHALL

9. CONTRACTOR SHALL FOLLOW ALL REQUIREMENTS OF THE CSPP. CONTRACTOR IS REQUIRED TO SUBMIT A SPCD, AS

BE PLACED END-TO-END OR INTERCONNECTED, OR AS DIRECTED BY THE AIRPORT.

OUTLINED IN THE CSPP, AT THE PRE-CONSTRUCTION MEETING.

PER NS-102 SPECIFICATIONS.

15. SIDEWALK CLOSURE REQUIREMENTS SHOWN ON G-084.

14. AIRPORT GATES LEFT OPEN FOR CONSTRUCTION TRAFFIC MUST BE MONITORED BY A DESIGNATED GATE GUARD AT ALL

SUBCONTRACTORS.

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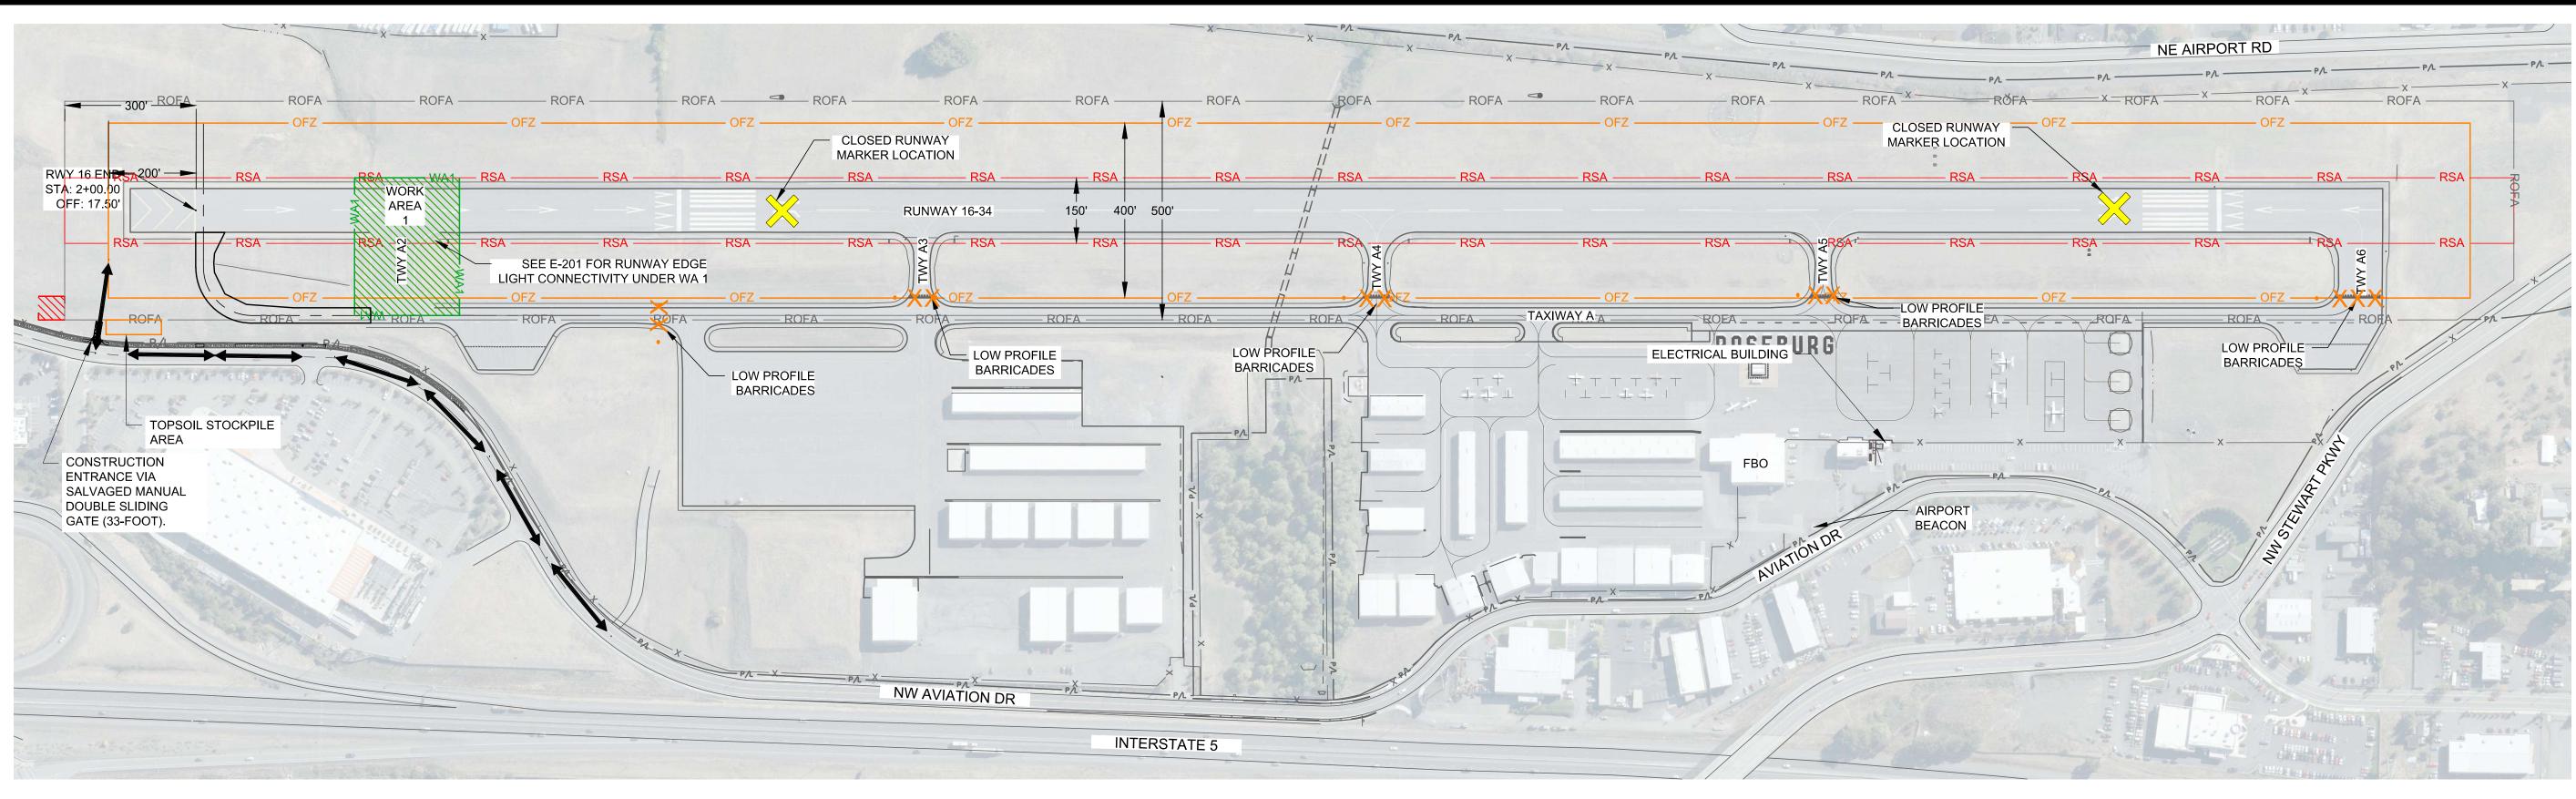
SHEET NO. 4 of 40

WORK ELEMENTS LOCATED WITHIN THE RUNWAY OBSTACLE FREE ZONE (OFZ) AND TAXIWAY OBJECT FREE AREA (TOFA) REQUIRE RUNWAY CLOSURE AND TEMPORARY PARTIAL RUNWAY CLOSURE. COMMENCEMENT OF WORK WITHIN THE OFZ AND

IF THE CONTRACTOR ELECTS TO PERFORM CONSTRUCTION IN 2025, IT SHALL BEGIN NO LATER THAN APRIL 1, 2025, UNLESS

TOFA WILL REQUIRE FINAL COMPLETION OF THE PROJECT IN ITS ENTIRETY IN 2024.

OTHERWISE APPROVED BY THE CITY.



#### PROJECT WORK AREA REQUIREMENTS:

- 1. THE STATION/OFFSETS IDENTIFIED ON THIS SHEET ARE REFERENCED OFF THE TAXIWAY A ALIGNMENT
- ALL WORK CONTAINED IN THE PROJECT WORK AREA REQUIRES RUNWAY CLOSURE.
- SCHEDULE DURING THE PRE-CONSTRUCTION MEETING THAT IDENTIFIES THE INTENDED DATES AND SEQUENCE OF RUNWAY CLOSURE(S). START OF WORK AREA 2 MAY BE CONCURRENT WITH THE START OF WORK AREA 1
- 4. DURING PERIODS OF RUNWAY CLOSURE, THE RUNWAY MAY ONLY BE CLOSED FROM 8:00 AM TO 4:30 PM LOCAL TIME.
- ARE LOCATED OUTSIDE THE ACTIVE RUNWAY SAFETY AREA AND TAXIWAY OBJECT FREE AREA. HOWEVER, MATERIAL STOCKPILES AND EQUIPMENT STORAGE IS PROHIBITED WITHIN THE RUNWAY OBJECT FREE AREA AT ALL TIMES WHEN THE RUNWAY IS OPEN.
- CONTRACTOR SHALL FOLLOW ALL REQUIREMENTS OF THE CONSTRUCTION SAFETY AND PHASING PLAN (CSPP). CONTRACTOR REQUIRED TO SUBMIT A SAFETY PLAN COMPLIANCE DOCUMENT (SPCD) AS OUTLINED IN THE CSPP, AT THE PRE-CONSTRUCTION MEETING.
- 7. DAILY SAFETY INSPECTION SHALL BE PERFORMED BY THE CONTRACTOR AS IDENTIFIED IN THE CSPP.
- A PROJECT SUPERINTENDENT OR DESIGNATED PROJECT REPRESENTATIVE SHALL BE ON-SITE AT ALL TIMES WHILE CREWS AR IN THE FIELD. THIS INCLUDES A PRIME CONTRACTOR REPRESENTATIVE DURING ALL WORK BEING PERFORMED BY SUBCONTRACTORS.
- TO PREPARE FOR THE PARTIAL RUNWAY CLOSURE REQUIRED FOR WORK AREA 2, CONTRACTOR MAY INSTALL TEMPORARY THRESHOLD LIGHT BASE CANS DURING THIS WORK AREA. EXISTING RUNWAY EDGE LIGHTING SHALL REMAIN OPERATIONAL IN THE EXISTING CONFIGURATION UNTIL THE ONE CALENDAR DAY RUNWAY CONVERSION DESCRIBED UNDER WORK AREA 2 IS PERFORMED.
- 10. EQUIPMENT HEIGHT SHALL NOT EXCEED 25-FEET, UNLESS OTHERWISE APPROVED BY THE CITY.

#### RUNWAY CLOSURE REQUIREMENTS:

- 1. ALL CONSTRUCTION SHALL BE IN COMPLIANCE WITH THE CONSTRUCTION SAFETY AND PHASING PLAN (CSPP).
- 2. RUNWAY 16-34 SHALL BE CLOSED WHENEVER PERSONNEL, MATERIALS, OR EQUIPMENT ARE WITHIN THE RUNWAY SAFETY AREA (RSA) OR THE RUNWAY OBSTACLE FREE ZONE (OFZ). THE CITY WILL ISSUE A NOTICE TO AIRMEN (NOTAM) DURING PERIODS OF RUNWAY CLOSURE.
- THE CONTRACTOR SHALL NOT ENTER ANY ACTIVE RUNWAY SAFETY AREA (RSA), OBSTACLE FREE ZONE (OFZ), OR TAXIWAY OBJECT FREE AREA (TOFA) WITHOUT AUTHORIZATION FROM THE CITY.
- AFTER THE NOTAM HAS BEEN ISSUED AND ACCESS TO THE RUNWAY HAS BEEN GRANTED BY THE CITY, CONTRACTOR SHALL IMMEDIATELY PLACE RUNWAY CLOSURE MARKERS ON BOTH ENDS OF THE RUNWAY.
- THE CONTRACTOR SHALL DISABLE THE FOLLOWING CIRCUITS INSIDE THE ELECTRICAL BUILDING ONCE THE NOTAM HAS BEEN ISSUED AND BEFORE WORK MAY BEGIN: RUNWAY EDGE LIGHTING, TAXIWAY EDGE LIGHTING, RUNWAY 16 REIL, RUNWAY 34 REIL, RUNWAY 34 PAPI, AND WINDCONE.
- PRIOR TO REOPENING RUNWAY 16-34, A FINAL INSPECTION OF THE ENTIRE RUNWAY AND RUNWAY SAFETY AREA WILL BE MADE TO ENSURE THAT ALL REQUIREMENTS HAVE BEEN MET AND THAT THE RUNWAY IS IN SAFE OPERATING CONDITION PRIOR TO REOPENING. THE CONTRACTOR SHALL COORDINATE WITH THE CITY TO ENSURE THAT ALL RUNWAY EDGE LIGHTS AND NAVAIDS ARE OPERATING CORRECTLY AND THAT CLOSED RUNWAY MARKERS HAVE BEEN REMOVED.
- A PROJECT SUPERINTENDENT OR DESIGNATED PROJECT REPRESENTATIVE SHALL BE ON-SITE AT ALL TIME WHILE CREWS ARE IN THE FIELD. THIS INCLUDES A PRIME CONTRACTOR REPRESENTATIVE DURING ALL WORK BEING PERFORMED BY SUBCONTRACTORS.
- LIQUIDATED DAMAGES FOR FAILURE TO COMPLETE WORK IN THE TIME PROVIDED ARE DEFINED IN SECTION 80-08 OF THE GENERAL CONTRACT PROVISIONS.

## MAJOR WORK ELEMENTS

SEE NOTE 10.

OMNI-DIRECTIONAL

SOLAR RED FLASHER

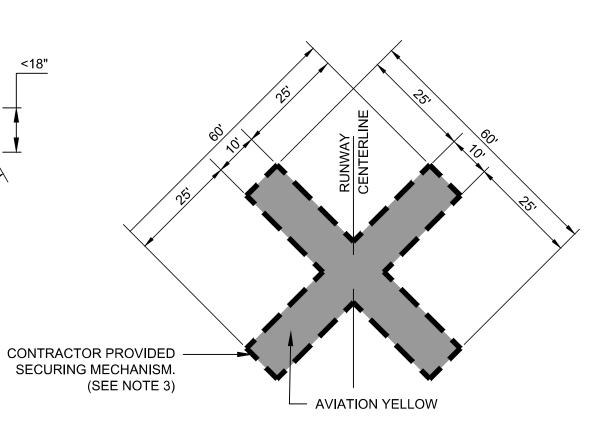


INSTALL TEMPORARY THRESHOLD LIGHT BASE CANS FOR PARTIALLY CLOSED RUNWAY NEEDED UNDER WORK AREA 2.

REMOVE TAXIWAY A2 AND MISCELLANEOUS INFRASTRUCTURE

## **IMPACT TO AIRPORT OPERATIONS**

-RUNWAY 16/34 CLOSED FOR 10 CALENDAR DAYS BETWEEN 8AM AND 4:30PM LOCAL TIME. RUNWAY EDGE LIGHTING - OUT OF SERVICE TAXIWAY EDGE LIGHTING - OUT OF SERVICE RUNWAY 16 REIL - OUT OF SERVICE **RUNWAY 34 REIL - OUT OF SERVICE** RUNWAY 34 PAPI - OUT OF SERVICE



#### **LOW PROFILE** BARRICADE DETAIL

WATER RELEASE VALVE

DIRECTED BY THE AIRPORT.

MIN. 6" ORANGE

REFLECTIVE STRIPES

LOW PROFILE BARRICADE NOTES:

OMNI-DIRECTIONAL

SOLAR RED FLASHER

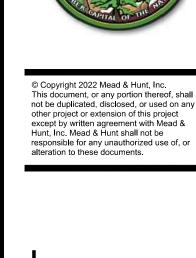
- 1. LOW PROFILE BARRICADES AND OMNIDIRECTIONAL FLASHERS WILL BE FURNISHED BY THE CONTRACTOR. THE CONTRACTOR IS RESPONSIBLE FOR DEPLOYING, RELOCATING, AND REMOVING LOW PROFILE BARRICADES IN ACCORDANCE WITH THE PHASING PLANS OR AS OTHERWISE
- 2. CONTRACTOR SHALL MAINTAIN ALL FLASHERS IN WORKING ORDER FOR THE DURATION OF THE PROJECT.
- 3. LOW PROFILE BARRICADES SHALL BE PLACED END-TO-END OR INTERCONNECTED UNLESS OTHERWISE DIRECTED BY THE AIRPORT.

## **FABRIC CLOSED RUNWAY MARKER**

#### **CLOSED RUNWAY NOTES:**

- 1. FABRIC CLOSED RUNWAY MARKERS SHALL BE PLACED ON THE RUNWAY NUMERALS AT EACH END OF RUNWAY 16-34 DURING RUNWAY CLOSURE PERIODS.
- 2. FABRIC CLOSED RUNWAY MARKERS WILL BE SUPPLIED BY THE AIRPORT. CONTRACTOR IS RESPONSIBLE FOR PLACING, MAINTAINING, AND REMOVAL OF CLOSED RUNWAY MARKERS FOR EACH DAY OF CLOSURE.
- 3. CONTRACTOR SHALL PROVIDE MEANS TO SECURE THE FABRIC CLOSED RUNWAY MARKERS SO AS TO NOT BE AFFECTED BY WIND. THIS MAY CONSIST OF SANDBAGS, 2" X 6" LUMBER, OR COMBINATION THEREOF, OR AS OTHERWISE APPROVED BY THE RPR. SECURING MECHANISMS MUST BE YELLOW IN COLOR.

#### LEGEND: **CONTRACTOR ACCESS RUNWAY SAFETY AREA** RUNWAY OBJECT FREE OBSTACLE FREE ZONE **CONTRACTOR STAGING** GATE GUARD LOW-PROFILE XXXXXX BARRICADES RUNWAY CLOSURE MARKER



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SHEET NO. 5 of 40

**WORK AREA 1** 

# WORK AREA 2 PAVEMENT UNDERDRAINS, PAVMEMENT MARKINGS, RUNWAY AND TAXIWAY EDGE LIGHTS, TAXIWAY GUIDANCE SIGNS. PROJECT WORK AREA REQUIREMENTS:

1. THIS WORK AREA REQUIRES A TEMPORARY PARTIALLY CLOSED RUNWAY AND IMPLEMENTATION OF MODIFIED DECLARED DISTANCES. CONVERSION TO THE PARTIALLY CLOSED RUNWAY CONFIGURATION SHALL BE COMPLETED IN ONE (1) CALENDAR DAY CONCURRENT WITH WORK AREA 1. WORK ELEMENTS NEEDED TO PARTIALLY CLOSE THE RUNWAY INCLUDE COMPLETION OF THE FOLLOWING:

MAJOR WORK ELEMENTS

-EXTEND TAXIWAY ALPHA 400' NORTH. CONSTRUCT CONNECTOR

TAXIWAY A1. INSTALL RETAINING WALL, JET BLAST FENCE,

**OPERATIONS** 

TEMPORARY PARTIALLY CLOSED RUNWAY THAT WILL

MODIFY DECLARED DISTANCES FOR RUNWAY 16/34

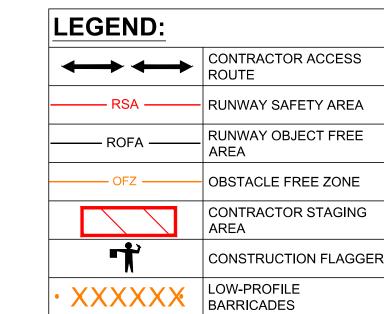
WORK AREA 1 LIMITED TO WORK OUTSIDE THE

OBSTACLE FREE ZONE.


DURING CONSTRUCTION. WORK CONCURRENT WITH

-OBSCURING THREE (3) RUNWAY ARROWS AND TAILS
-INSTALLING SEVEN (7) CHEVRON MARKINGS
-INSTALLING ONE (1) DEMARCATION BAR
-RELOCATING EIGHT (8) EXISTING RUNWAY THRESHOLD LIGHT FIXTURES AND TRANSFORMERS
AND INSTALLING THEM ON NEW BASE CANS LOCATED AT THE DEMARCATION BAR.
-INSTALLING A TEMPORARY JUMPER BETWEEN RUNWAY LIGHTS R71 AND R72.
-OBSCURING RUNWAY LIGHTS R67, R68, R69, & R70 LOCATED BETWEEN THE DEMARCATION BAR
AND THE TEMPORARY JUMPER.
-INSTALLING YELLOW/WHITE RUNWAY GLOBES ON RUNWAY LIGHTS R38, R39, R40, R41, AND R42.

- 2. WORK AREA 2 SHALL BE SUBSTANTIALLY COMPLETED IN 75 CALENDAR DAYS. THE CONTRACTOR SHALL PROVIDE A SCHEDULE DURING THE PRE-CONSTRUCTION MEETING THAT IDENTIFIES THE INTENDED DATES AND SEQUENCE OF RUNWAY CLOSURE(S). START OF WORK AREA 2 MAY BE CONCURRENT WITH THE START OF WORK AREA 1.
- 3. OPEN TRENCHES AND EXCAVATIONS ARE ALLOWED TO REMAIN OPEN WHILE THE RUNWAY IS OPERATIONAL PROVIDED THEY ARE LOCATED OUTSIDE THE ACTIVE RUNWAY SAFETY AREA AND TAXIWAY OBJECT FREE AREA. HOWEVER, MATERIAL STOCKPILES AND EQUIPMENT STORAGE IS PROHIBITED WITHIN THE RUNWAY OBJECT FREE AREA AT ALL TIMES WHEN THE RUNWAY IS OPEN.
- 4. CONTRACTOR SHALL FOLLOW ALL REQUIREMENTS OF THE CONSTRUCTION SAFETY AND PHASING PLAN (CSPP). CONTRACTOR REQUIRED TO SUBMIT A SAFETY PLAN COMPLIANCE DOCUMENT (SPCD) AS OUTLINED IN THE CSPP, AT THE PRE-CONSTRUCTION MEETING.
- 5. DAILY SAFETY INSPECTION SHALL BE PERFORMED BY THE CONTRACTOR AS IDENTIFIED IN THE CSPP.
- 6. A PROJECT SUPERINTENDENT OR DESIGNATED PROJECT REPRESENTATIVE SHALL BE ON-SITE AT ALL TIMES WHILE CREWS AR IN THE FIELD. THIS INCLUDES A PRIME CONTRACTOR REPRESENTATIVE DURING ALL WORK BEING PERFORMED BY SUBCONTRACTORS.
- 7. ALL COMPONENTS OF THE TAXIWAY A ELECTRICAL SYSTEM OUTSIDE OF THE PROJECT WORK AREA AND NOT OTHERWISE NOTED SHALL REMAIN OPERATIONAL.
- 8. EQUIPMENT HEIGHT SHALL NOT EXCEED 25-FEET, UNLESS OTHERWISE APPROVED BY THE CITY.



RUNWAY 16-34 DECLARED					
	DISTANC	ES			
EFFECTIVE FOR THE DURATION OF WORK AREA 2.					
	RUNWAY 16	RUNWAY 34			
TORA	4339'	4339'			
TODA	4339'	4339'			
ASDA	4339'	4339'			
LDA	3902'	3968'			

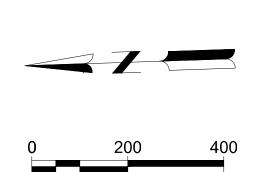

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9600 NE Cascades Parkway
Suite 100
Portland, OR 97220
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ROSEBURG REGIONAL AIRPC FAXIWAY A EXTENSION 100 SEBURG, OR 97470

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SHEET CONTENTS

OPERATIONS &
PHASING PLAN WORK AREA 2

SHEET NO. 6 of 40

G-082

TEMPORARY PARTIALLY CLOSED

**RUNWAY MARKINGS** 

Mead and Hunt, Inc. 9600 NE Cascades Parkway Suite 100

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NW STI

ISSUED FOR BID

DIGITALLY SIGNED OREGON EXPIRES: 12 / 31 / 25

AIP NO.: 3-41-0054-030-2024 1821200-221217.01 DATE: APRIL 18, 2024 DESIGNED BY: MLF

DRAWN BY: MJK CHECKED BY: RJB DO NOT SCALE DRAWINGS

SHEET CONTENTS **TEMPORARY** PARTIALLY CLOSED

SHEET NO. 7 of 40

RUNWAY 16 TEMPORARY THRESHOLD DETAIL

RUNWAY

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3896 NW STE ROSEBURG,

ISSUED FOR BID

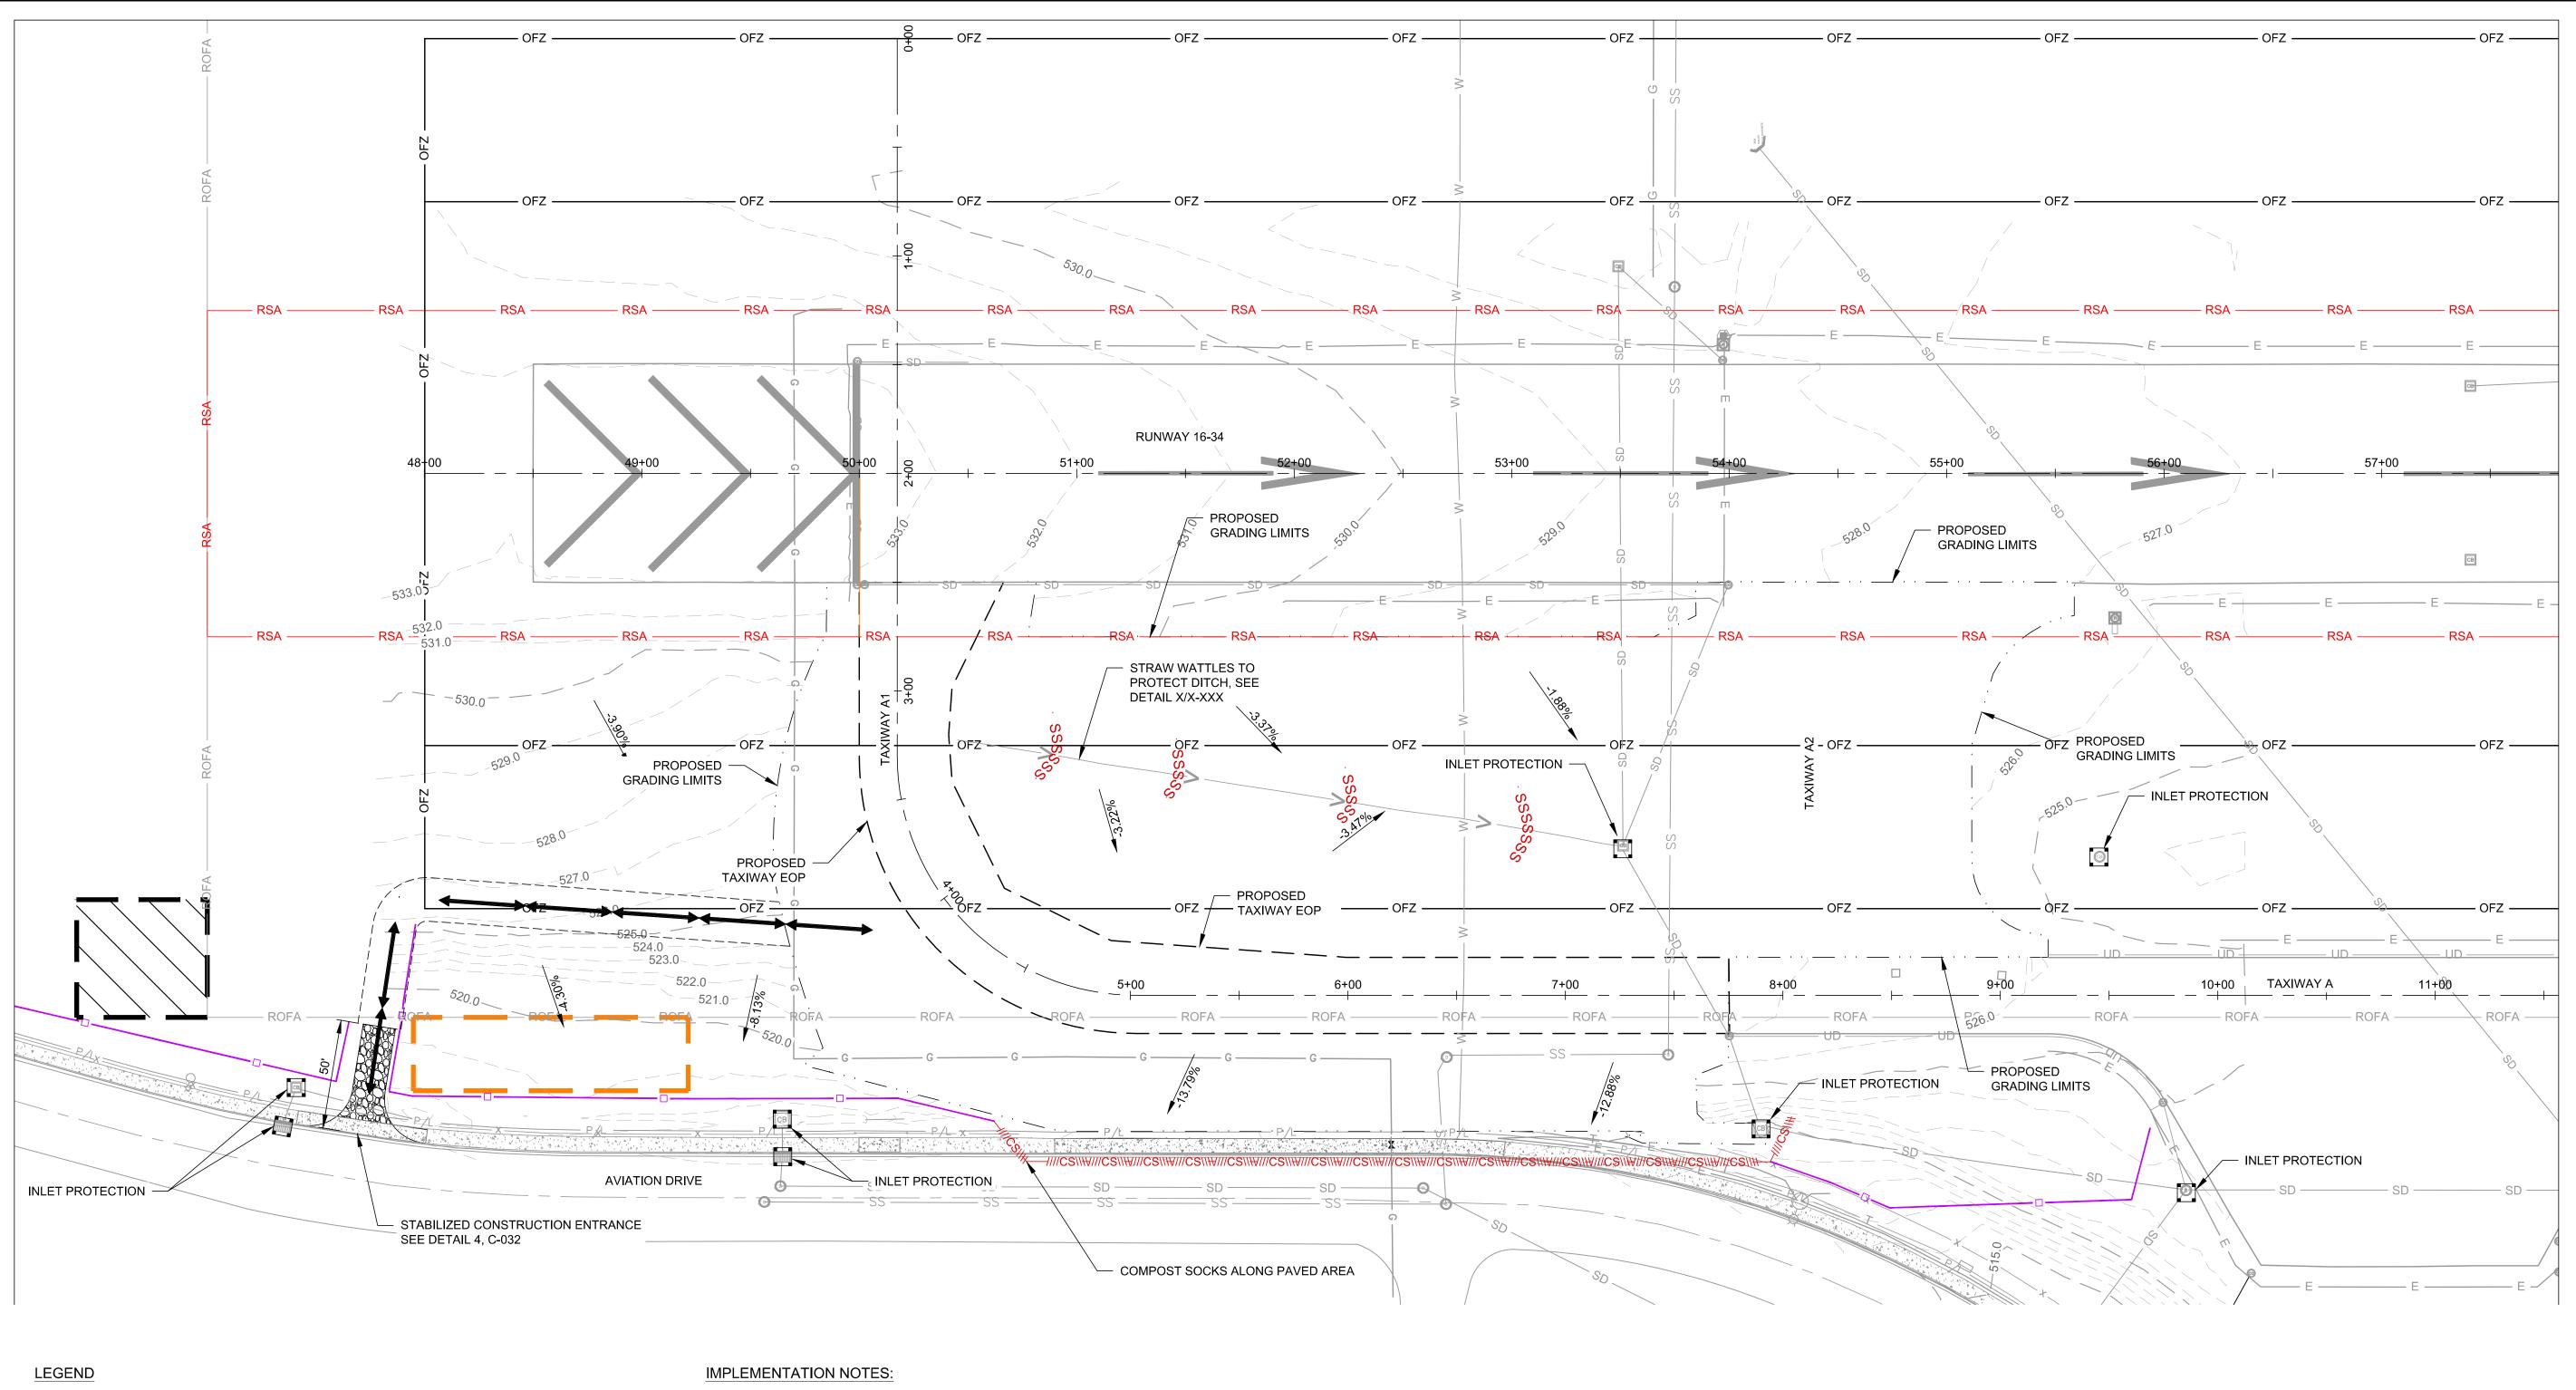


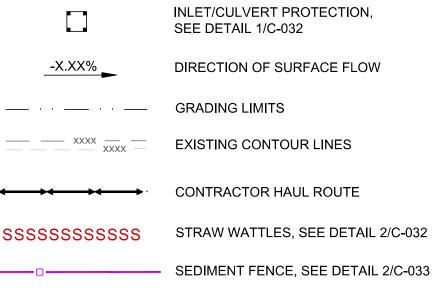
3-41-0054-030-2024 1821200-221217.01 DATE: APRIL 18, 2024

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SHEET CONTENTS TRAFFIC CONTROL PLAN


SHEET NO. 8 of 40





- 1. SEE SHEET C-031 FOR EROSION AND SEDIMENT CONTROL 1200-C PERMIT REQUIREMENTS.
- 2. THIS PLAN INDICATES THE MINIMUM EROSION CONTROL AND SEDIMENT MEASURES REQUIRED FOR THE PROJECT. THE CONTRACTOR SHALL EMPLOY ADDITIONAL BMPs, AS NECESSARY, TO KEEP SEDIMENT FROM LEAVING THE SITE OR FROM ENTERING STORM FACILITIES. ADDITIONAL BMPs WILL BE PAID THROUGH QUANTITY ADJUSTMENTS TO THE RESPECTIVE EROSION CONTROL BID ITEMS.
- 3. AREAS USED FOR STAGING AND TEMPORARY HAUL ROUTES DURING CONSTRUCTION SHALL BE RESTORED TO THEIR ORIGINAL CONDITION.
- 4. TEMPORARY HAUL ROUTES NEEDED FOR EXECUTION OF THE WORK WILL BE THE RESPONSIBILITY OF THE CONTRACTOR. TEMPORARY HAUL ROUTES CONSTRUCTED BY THE CONTRACTOR SHALL BE REMOVED UPON COMPLETION OF HAULING OPERATIONS AND THE GROUND RESTORED TO IT'S ORIGINAL CONDITION. THIS WORK INCLUDE, BUT NOT LIMITED TO, RESTORING THE AREA TO ORIGINAL GRADE, TOPSOILING, FERTILIZING, SEEDING, MULCHING, ETC.



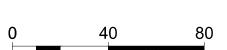

INITIAL EROSION CONTROL PLAN

SHEET CONTENTS

DESIGNED BY: MLF

DRAWN BY: MJK
CHECKED BY: RJB

DATE:

SHEET NO. 9 of 40

C-021

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OREGON

EXPIRES: 12 / 31 / 25

3-41-0054-030-2024

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APRIL 18, 2024


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X:\1821200\221217.01\TECH\CAD\C-021 INITIAL EROSION CONTROL PLAN



EXISTING CONTOUR LINES

CONTRACTOR HAUL ROUTE

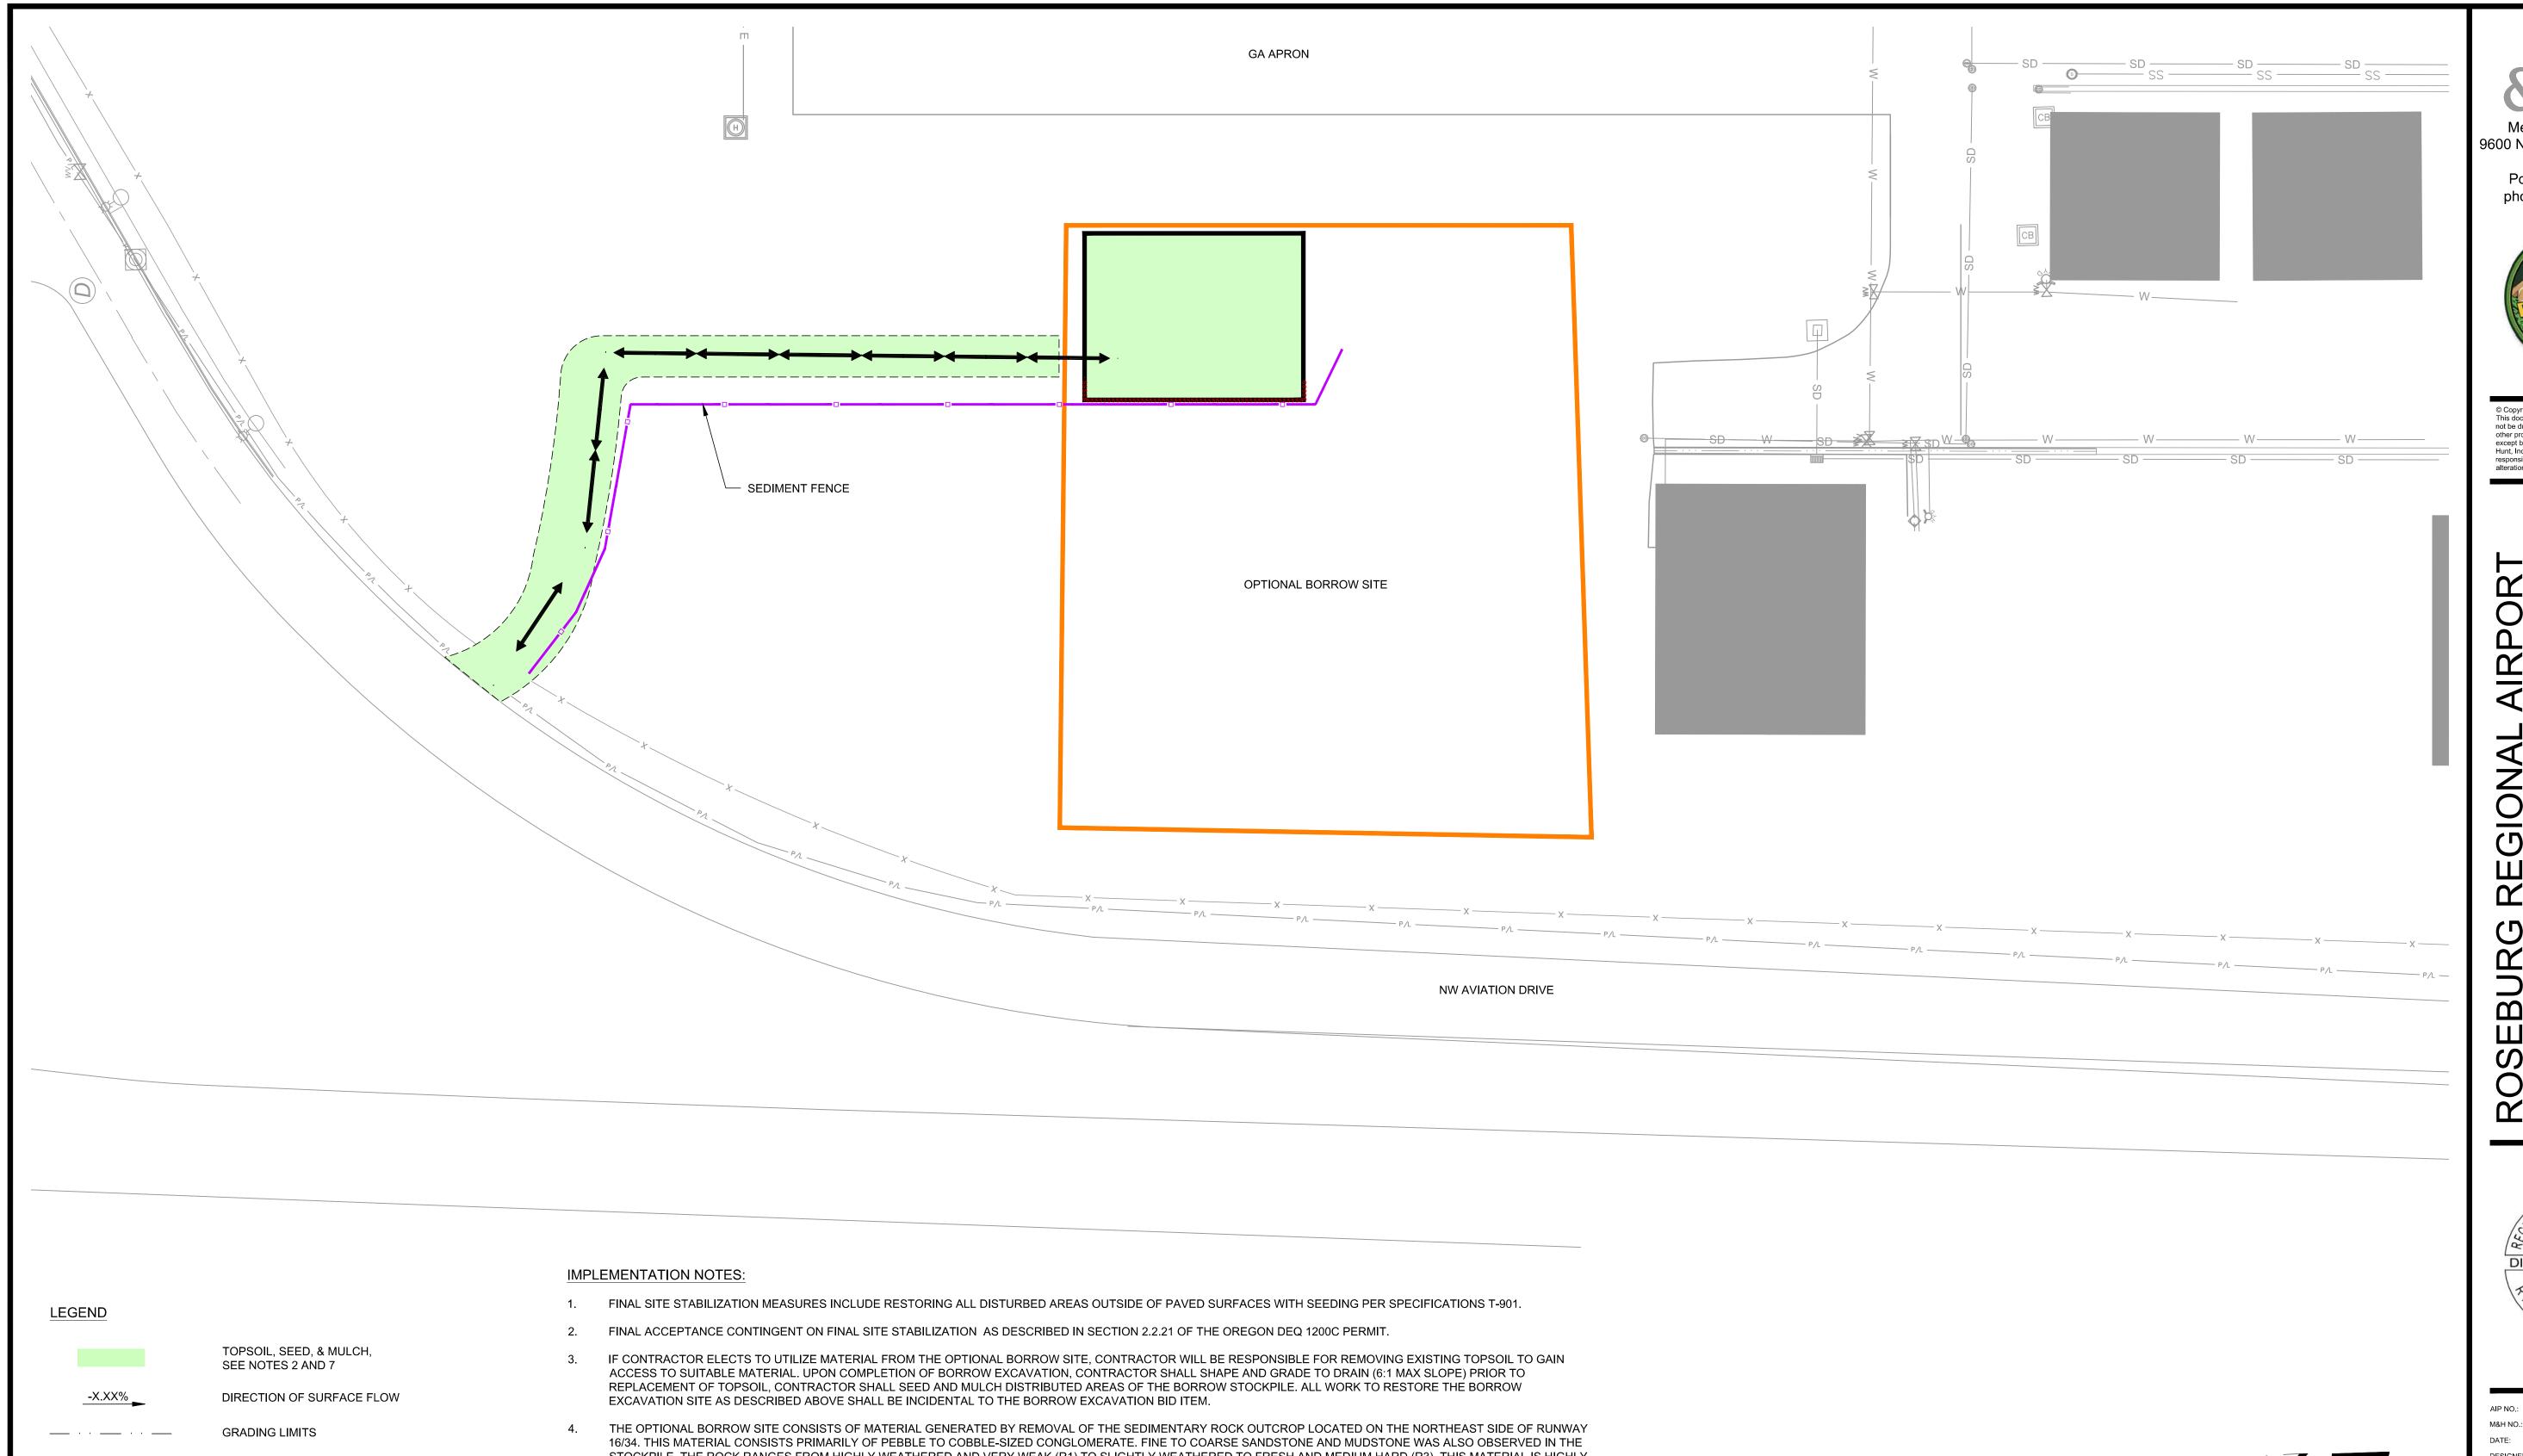SEDIMENT FENCE, SEE DETAIL 2/C-033

- STOCKPILE. THE ROCK RANGES FROM HIGHLY WEATHERED AND VERY WEAK (R1) TO SLIGHTLY WEATHERED TO FRESH AND MEDIUM HARD (R3). THIS MATERIAL IS HIGHLY SUSCEPTIBLE TO AIR AND MOISTURE SLAKING. IF UTILIZED, THE PROCESSING, IF NECESSARY, MAY INVOLVE CRUSHING, SCREENING, COMPACTING IN-PLACE, OR OTHER APPROVED METHODS TO ENSURE THE MAXIMUM PARTICLE SIZE DOES NOT EXCEED 2" AFTER FINAL PLACEMENT.
- SEE SHEET C-031 FOR EROSION AND SEDIMENT CONTROL, 1200-C PERMIT REQUIREMENTS.
- 6. THIS PLAN INDICATES THE MINIMUM EROSION CONTROL AND SEDIMENT MEASURES REQUIRED FOR THE PROJECT. THE CONTRACTOR SHALL EMPLOY ADDITIONAL BMPs, AS NECESSARY, TO KEEP SEDIMENT FROM LEAVING THE SITE OR FROM ENTERING STORM FACILITIES. ADDITIONAL BMPs WILL BE PAID THROUGH QUANTITY ADJUSTMENTS TO THE RESPECTIVE EROSION CONTROL BID ITEMS.
- 7. AREAS USED FOR STAGING AND TEMPORARY HAUL ROUTES DURING CONSTRUCTION SHALL BE RESTORED TO THEIR ORIGINAL CONDITION.
- TEMPORARY HAUL ROUTES NEEDED FOR EXECUTION OF THE WORK WILL BE THE RESPONSIBILITY OF THE CONTRACTOR. TEMPORARY HAUL ROUTES CONSTRUCTED BY THE CONTRACTOR SHALL BE REMOVED UPON COMPLETION OF HAULING OPERATIONS AND THE GROUND RESTORED TO IT'S ORIGINAL CONDITION. THIS WORK MAY INCLUDE, BUT NOT LIMITED TO, RESTORING THE AREA TO ORIGINAL GRADE, TOPSOILING, FERTILIZING, SEEDING, MULCHING, ETC.

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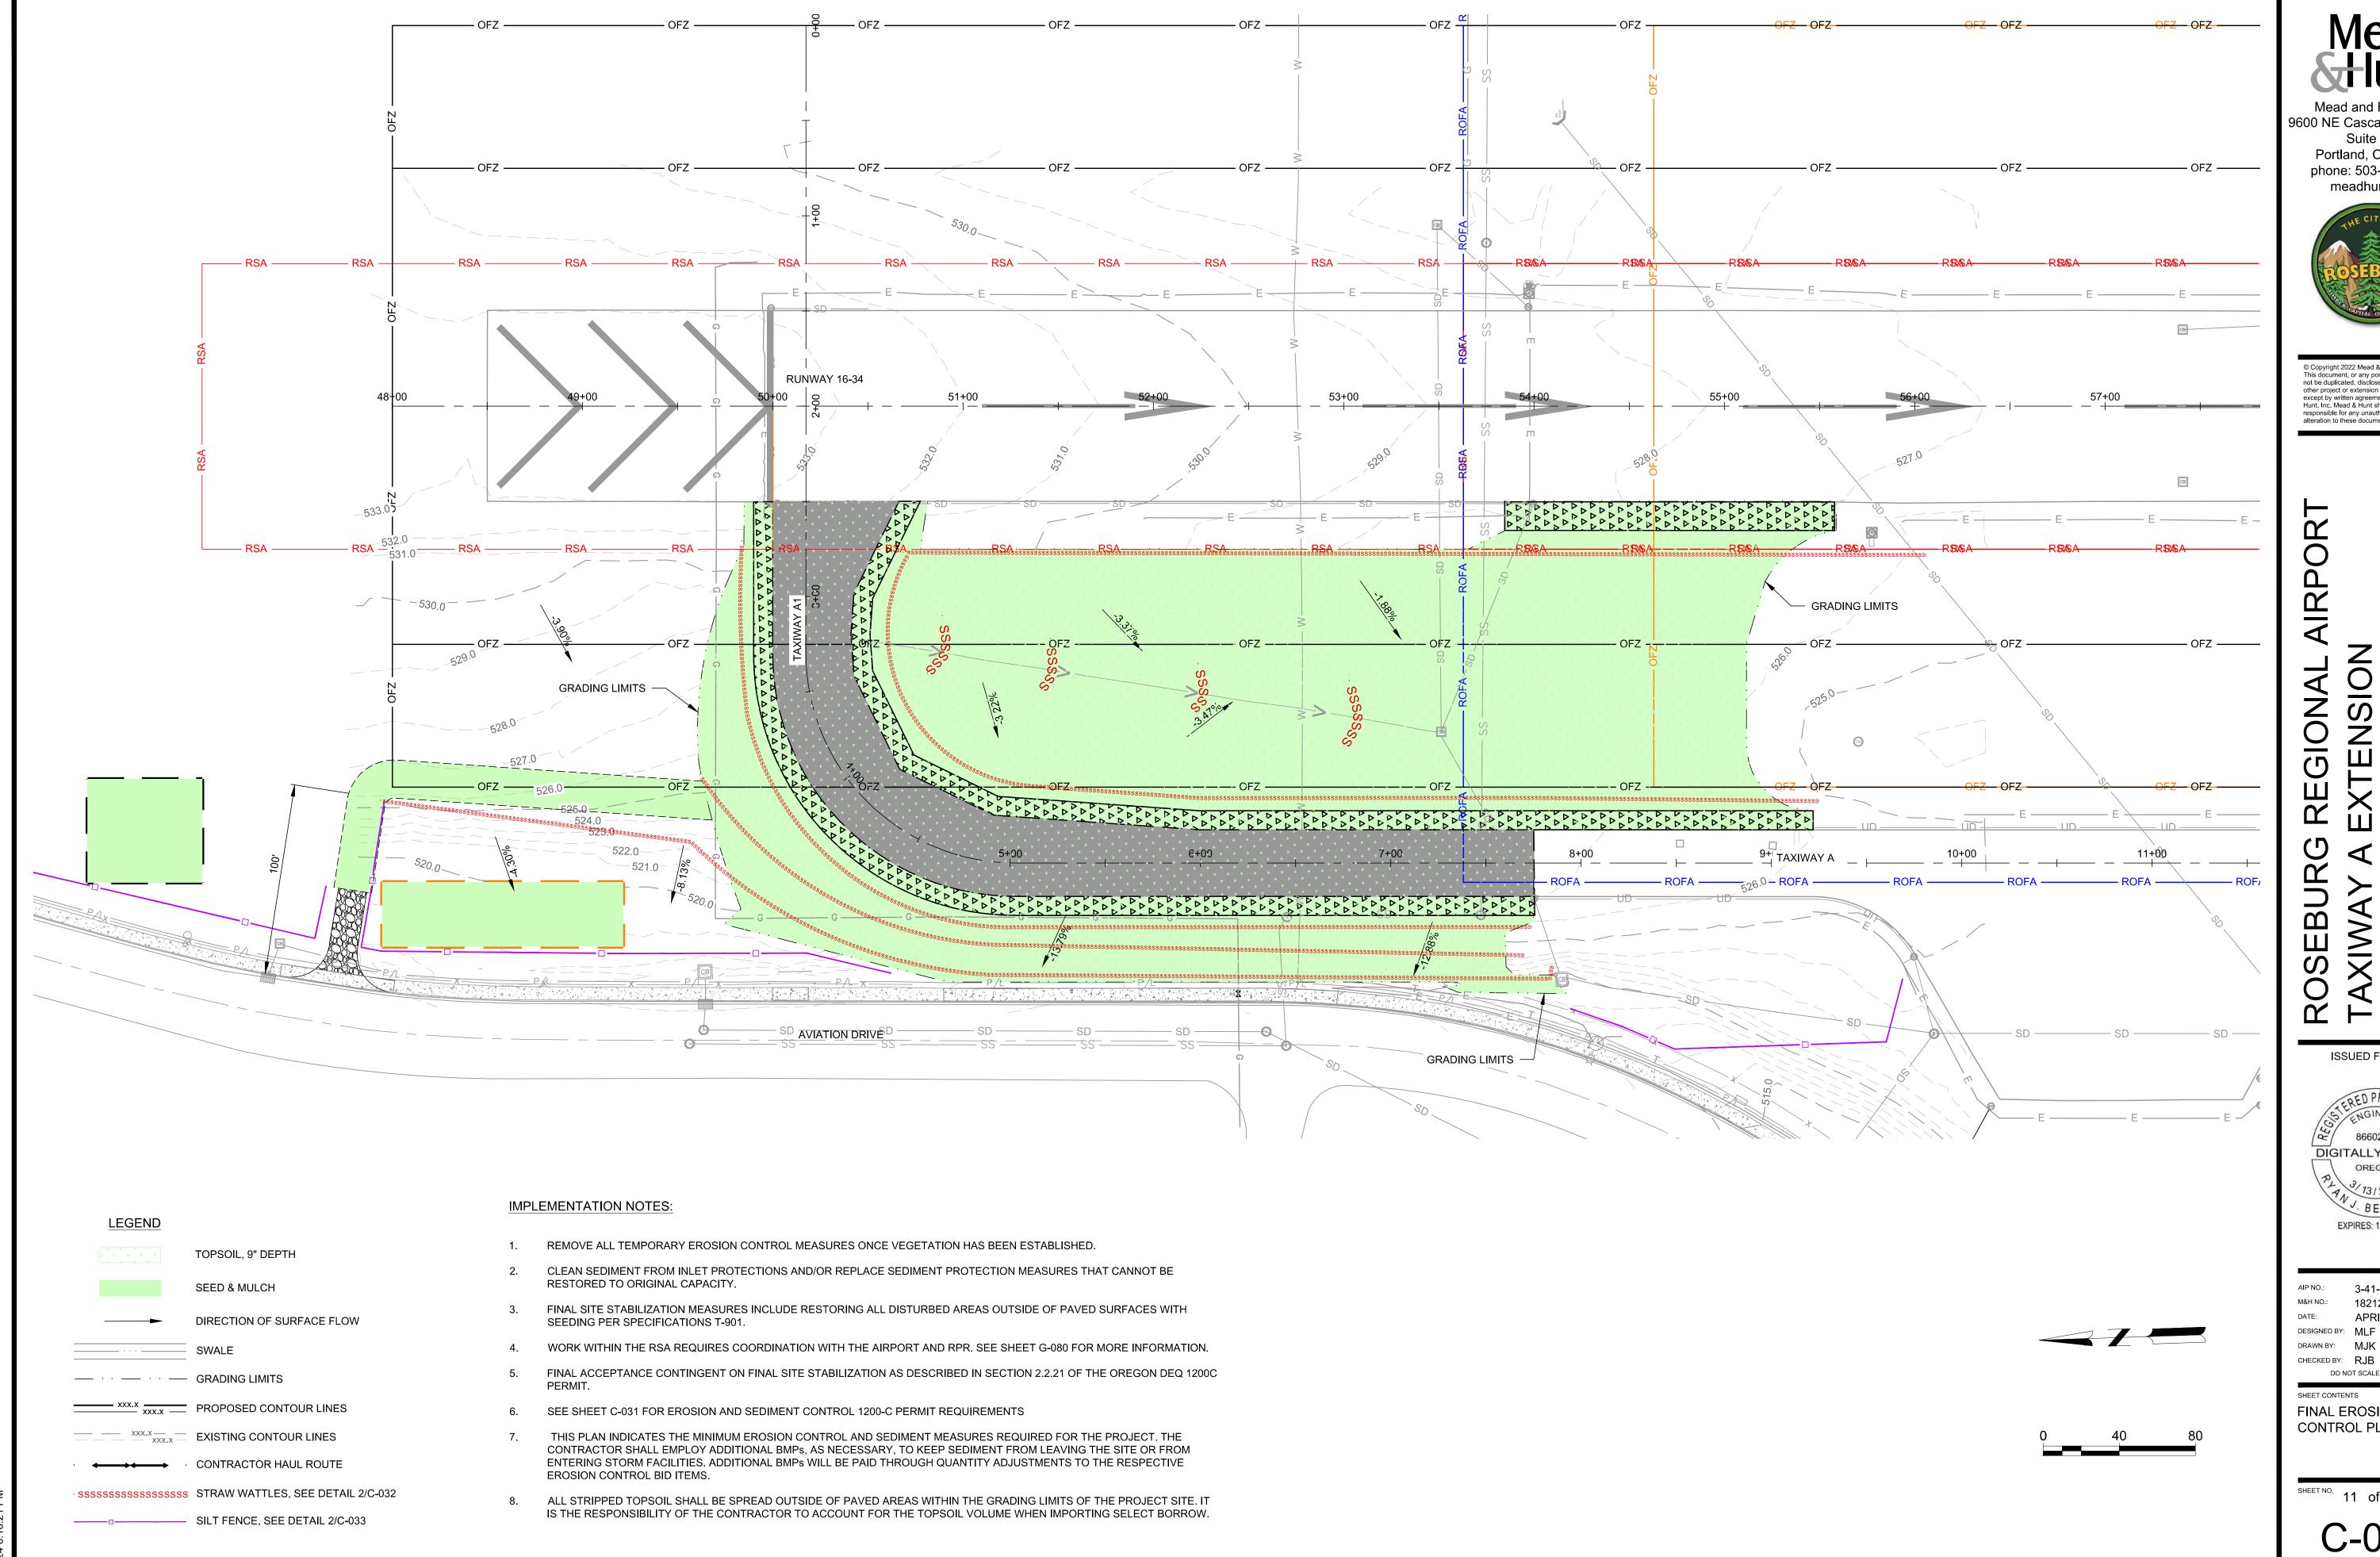
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SHEET CONTENTS EROSION CONTROL PLAN - BORROW SITE

SHEET NO. 10 of 40



Mead Hunt

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DO NOT SCALE DRAWINGS SHEET CONTENTS FINAL EROSION CONTROL PLAN

SHEET NO. 11 of 40

VISUAL MONITORING INSPECTION REPORTS MUST BE MADE IN ACCORDANCE WITH DEQ PERMIT REQUIREMENTS. (SECTION 6.5)

INSPECTION LOGS MUST BE KEPT IN ACCORDANCE WITH DEQ'S 1200-C PERMIT REQUIREMENTS. (SECTION 6.5.g)

RETAIN A COPY OF THE ESCP AND ALL REVISIONS ON SITE AND MAKE IT AVAILABLE ON REQUEST TO DEQ. AGENT. OR THE LOCAL MUNICIPALITY. (SECTION 4.7) 5. THE PERMIT REGISTRANT MUST IMPLEMENT THE ESCP. FAILURE TO IMPLEMENT ANY OF THE CONTROL MEASURES OR PRACTICES DESCRIBED IN THE ESCP IS A VIOLATION OF THE PERMIT. (SECTIONS 4

6. THE ESCP MUST BE ACCURATE AND REFLECT SITE CONDITIONS. (SECTION 4.8)

SUBMISSION OF ALL ESCP REVISIONS IS NOT REQUIRED. SUBMITTAL OF THE ESCP REVISIONS IS ONLY UNDER SPECIFIC CONDITIONS. SUBMIT ALL NECESSARY REVISION TO DEQ OR AGENT WITHIN 10 DAYS. (SECTION 4.9)

8. SEQUENCE CLEARING AND GRADING TO THE MAXIMUM EXTENT PRACTICAL TO PREVENT EXPOSED INACTIVE AREAS FROM BECOMING A SOURCE OF EROSION. (SECTION 2.2.2)

CREATE SMOOTH SURFACES BETWEEN SOIL SURFACE AND EROSION AND SEDIMENT CONTROLS TO PREVENT STORMWATER FROM BYPASSING CONTROLS AND PONDING. (SECTION 2.2.3) 10. IDENTIFY, MARK, AND PROTECT (BY CONSTRUCTION FENCING OR OTHER MEANS) CRITICAL RIPARIAN AREAS AND VEGETATION INCLUDING IMPORTANT TREES AND ASSOCIATED ROOTING ZONES, AND VEGETATION AREAS TO BE PRESERVED. IDENTIFY VEGETATIVE BUFFER ZONES BETWEEN THE SITE AND SENSITIVE AREAS (E.G. WETLANDS), AND OTHER AREAS TO BE PRESERVED, ESPECIALLY IN PERIMETER AREAS. (SECTION 2.2.1)

11. PRESERVE EXISTING VEGETATION WHEN PRACTICAL AND RE-VEGETATE OPEN AREAS. RE-VEGETATE OPEN AREAS WHEN PRACTICABLE BEFORE AND AFTER GRADING OR CONSTRUCTION. IDENTIFY THE TYPE OF VEGETATIVE SEED MIX USED. (SECTION 2.2.5)

12. MAINTAIN AND DELINEATE ANY EXISTING NATURAL BUFFER WITHIN THE 50-FEET OF WATERS OF THE STATE (SECTION 2.2.4)

13. INSTALL PERIMETER SEDIMENT CONTROL, INCLUDING STORM DRAIN INLET PROTECTION AS WELL AS ALL SEDIMENT BASINS, TRAPS, AND BARRIERS PRIOR TO LAND DISTURBANCE. (SECTIONS 2.1.3)

14. CONTROL BOTH PEAK FLOW RATES AND TOTAL STORMWATER VOLUME, TO MINIMIZE EROSION AT OUTLETS AND DOWNSTREAM CHANNELS AND STREAM BANKS. (SECTIONS 2.1.1 AND 2.2.16) 15. CONTROL SEDIMENT AS NEEDED ALONG THE SITE PERIMETER AND AT ALL OPERATIONAL INTERNAL STORM DRAIN INLETS AT ALL TIMES DURING CONSTRUCTION, BOTH INTERNALLY AND AT THE SITE BOUNDARY. (SECTIONS 2.2.6 AND 2.2.13)

16. ESTABLISH CONCRETE TRUCK AND OTHER EQUIPMENT WASHOUT AREAS BEFORE BEGINNING CONCRETE WORK, (SECTION 2.2.14)

17. APPLY TEMPORARY AND/OR PERMANENT SOIL STABILIZATION MEASURES IMMEDIATELY ON ALL DISTURBED AREAS AS GRADING PROGRESSES. TEMPORARY OR PERMANENT STABILIZATIONS MEASURES ARE NOT REQUIRED FOR AREAS THAT ARE INTENDED TO BE LEFT UNVEGETATED, SUCH AS DIRT ACCESS ROADS OR UTILITY POLE PADS. (SECTIONS 2.2.20 AND 2.2.21)

18. ESTABLISH MATERIAL AND WASTE STORAGE AREAS, AND OTHER NON-STORMWATER CONTROLS. (SECTION 2.3.7)

19. KEEP WASTE CONTAINER LIDS CLOSED WHEN NOT IN USE AND CLOSE LIDS AT THE END OF THE BUSINESS DAY FOR THOSE CONTAINERS THAT ARE ACTIVELY USED THROUGHOUT THE DAY. FOR WASTE CONTAINERS THAT DO NOT HAVE LIDS, PROVIDE EITHER (1) COVER (E.G. A TARP, PLASTIC SHEETING, TEMPORARY ROOF) TO PREVENT EXPOSURE OF WASTES TO PRECIPITATION, OR (2) A SIMILARLY EFFECTIVE MEANS DESIGNED TO PREVENT THE DISCHARGE OF POLLUTANTS (E.G. SECONDARY CONTAINMENT). (SECTION 2.3.7)

20. PREVENT TRACKING OF SEDIMENT ONTO PUBLIC OR PRIVATE ROADS USING BMP'S SUCH AS: CONSTRUCTION ENTRANCE, GRAVELED (OR PAVED) EXITS AND PARKING AREAS, GRAVEL ALL UNPAVED ROADS LOCATED ONSITE, OR USE AN EXIT TIRE WASH. THESE BMP'S MUST BE IN PLACE PRIOR TO LAND-DISTURBING ACTIVITIES. (Section 2.2.7)

21. WHEN TRUCKING SATURATED SOILS FROM THE SITE, EITHER USE WATER-TIGHT TRUCKS OR DRAIN LOADS ON SITE. (SECTION 2.2.7.f)

22. CONTROL PROHIBITED DISCHARGES FROM LEAVING THE CONSTRUCTION SITE, I.E., CONCRETE WASH-OUT, WASTEWATER FROM CLEANOUT OF STUCCO, PAINT AND CURING COMPOUNDS. (SECTIONS 1.5

23. ENSURE THAT STEEP SLOPE AREAS WHERE CONSTRUCTION ACTIVITIES ARE NOT OCCURRING ARE NOT DISTURBED. (SECTION 2.2.10)

24. PREVENT SOIL COMPACTION IN AREAS WHERE POST-CONSTRUCTION INFILTRATION FACILITIES ARE TO BE INSTALLED. (SECTOIN 2.2.12) 25. USE BMP'S TO PREVENT OR MINIMIZE STORMWATER EXPOSURE TO POLLUTANTS FROM SPILLS; VEHICLE AND EQUIPMENT FUELING, MAINTENANCE, AND STORAGE; OTHER CLEANING AND MAINTENANCE

ACTIVITIES; AND WASTE HANDLING ACTIVITIES. THESE POLLUTANTS INCLUDE FUEL, HYDRAULIC FLUID, AND OTHER OILS FROM VEHICLES AND MACHINERY, AS WELL AS DEBRIS, FERTILIZER, PESTICIDES AND HERBICIDES, PAINTS, SOLVENTS, CURING COMPOUNDS AND ADHESIVES FROM CONSTRUCTION OPERATIONS. (SECTIONS 2.2.15 AND 2.3)

26. PROVIDE PLANS FOR SEDIMENTATION BASINS THAT HAVE BEEN DESIGNED PER SECTION 2.2.17 AND STAMPED BY AN OREGON PROFESSIONAL ENGINEER. (SEE SECTION 2.2.17.a)

27. IF ENGINEERED SOILS ARE USED ON SITE, A SEDIMENTATION BASIN/IMPOUNDMENT MUST BE INSTALLED. (SEE SECTIONS 2.2.17 AND 2.2.18) 28. PROVIDE A DEWATERING PLAN FOR ACCUMULATED WATER FROM PRECIPITATION AND UNCONTAMINATED GROUNDWATER SEEPAGE DUE TO SHALLOW EXCAVATION ACTIVITIES. (SEE SECTION 2.4)

29. IMPLEMENT THE FOLLOWING BMP'S WHEN APPLICABLE: WRITTEN SPILL PREVENTION AND RESPONSE PROCEDURES, EMPLOYEE TRAINING ON SPILL PREVENTION AND PROPER DISPOSAL PROCEDURES. SPILL KITS IN ALL VEHICLES, REGULAR MAINTENANCE SCHEDULE FOR VEHICLES AND MACHINERY, MATERIAL DELIVERY AND STORAGE CONTROLS, TRAINING AND SIGNAGE, AND COVERED STORAGE AREAS FOR WASTE AND SUPPLIES. (SECTION 2.3)

30. USE WATER, SOIL-BINDING AGENT OR OTHER DUST CONTROL TECHNIQUE AS NEEDED TO AVOID WIND-BLOWN SOIL. (SECTION 2.2.9)

31. THE APPLICATION RATE OF FERTILIZERS USED TO REESTABLISH VEGETATION MUST FOLLOW MANUFACTURER'S RECOMMENDATIONS TO MINIMIZE NUTRIENT RELEASES TO SURFACE WATERS. EXERCISE

CAUTION WHEN USING TIME-RELEASE FERTILIZERS WITHIN ANY WATERWAY RIPARIAN ZONE. (SECTION 2.3.5)

32. IF AN ACTIVE TREATMENT SYSTEM (FOR EXAMPLE, ELECTRO-COAGULATION, FLOCCULATION, FILTRATION, ETC.) FOR SEDIMENT OR OTHER POLLUTANT REMOVAL IS EMPLOYED, SUBMIT AN OPERATION AND MAINTENANCE PLAN (INCLUDING SYSTEM SCHEMATIC, LOCATION OF SYSTEM, LOCATION OF INLET, LOCATION OF DISCHARGE, DISCHARGE DISPERSION DEVICE DESIGN, AND A SAMPLING PLAN AND FREQUENCY) BEFORE OPERATING THE TREATMENT SYSTEM. OBTAIN ENVIRONMENTAL MANAGEMENT PLAN APPROVAL FROM DEQ BEFORE OPERATING THE TREATMENT SYSTEM. OPERATE AND MAINTAIN THE TREATMENT SYSTEM ACCORDING TO MANUFACTURER'S SPECIFICATIONS. (SECTION 1.2.9)

33. TEMPORARILY STABALIZE SOILS AT THE END OF THE SHIFT BEFORE HOLIDAYS AND WEEKENDS, IF NEEDED. THE REGISTRANT IS RESPONSIBLE FOR ENSURING THAT SOILS ARE STABLE DURING RAIN EVENTS AT ALL TIMES OF THE YEAR. (SECTION 2.2)

34. AS NEEDED BASED ON WEATHER CONDITIONS, AT THE END OF EACH WORKDAY SOIL STOCKPILES MUST BE STABALIZED OR COVERED, OR OTHER BMP'S MUST BE IMPLEMENTED TO PREVENT DISCHARGES TO SURFACE WATERS OR CONVEYANCE SYSTEMS LEADING TO SURFACE WATERS. (SECTION 2.2.8)

35. SEDIMENT FENCE: REMOVE TRAPPED SEDIMENT BEFORE IT REACHES ONE THIRD OF THE ABOVE GROUND FENCE HEIGHT AND BEFORE FENCE REMOVAL. (SECTION 2.1.5.b)

36. OTHER SEDIMENT BARRIERS (SUCH AS BIOBAGS): REMOVE SEDIMENT BEFORE IT REACHES TWO INCHES DEPTH ABOVE GROUND HEIGHT AND BEFORE BMP REMOVAL. (SECTION 2.1.5.c)

37. CATCH BASINS: CLEAN BEFORE RETENTION CAPACITY HAS BEEN REDUCED BY FIFTY PERCENT. SEDIMENT BASINS AND SEDIMENT TRAPS: REMOVE TRAPPED SEDIMENTS BEFORE DESIGN CAPACITY HAS BEEN REDUCED BY FIFTY PERCENT AND AT COMPLETION OF PROJECT. (SECTION 2.1.5.d) 38. WITHIN 24 HOURS, SIGNIFICANT SEDIMENT THAT HAS LEFT THE CONSTRUCTION SITE, MUST BE REMEDIATED, INVESTIGATE THE CAUSE OF THE SEDIMENT RELEASE AND IMPLEMENT STEPS TO PREVENT A

RECURRENCE OF THE DISCHARGE WITHIN THE SAME 24 HOURS. ANY IN-STREAM CLEAN-UP OF SEDIMENT SHALL BE PERFORMED ACCORDING TO THE OREGON DEPARTMENT OS STATE LANDS REQUIRED TIMEFRAME. (SECTION 2.2.19.a) 39. THE INTENTIONAL WASHING OF SEDIMENT INTO STORM SEWERS OR DRAINAGE WAYS MUST NOT OCCUR. VACUUMING OR DRY SWEEPING AND MATERIAL PICKUP MUST BE USED TO CLEANUP RELEASED

SEDIMENTS. (SECTION 2.2.19) 40. DOCUMENT ANY PORTION(S) OF THE SITE WHERE LAND DISTURBING ACTIVITIES HAVE PERMANENTLY CEASED OR WILL BE TEMPORARILY INACTIVE FOR 14 OR MORE CALENDAR DAYS. (SECTION 6.5.f)

41. PROVIDE TEMPORARY STABALIZATION FOR THAT PORTION OF THE SITE WHERE CONSTRUCTION ACTIVITIES CEASE FOR 14 DAYS OR MORE WITH A COVERING OF BLOWN TACKIFIER, LOOSE STRAW, OR AN ADEQUATE COVERING OF COMPOST MULCH UNTIL WORK RESUMES ON THAT PORTION OF THE SITE. (SECTION 2.2.20)

42. DO NOT REMOVE TEMPORARY SEDIMENT CONTROL PRACTICES UNTIL PERMANENT VEGETATION OR OTHER COVER OF EXPOSED AREAS IS ESTABLISHED. ONCE CONSTRUCTION IS COMPLETE AND THE SITE IS STABALIZED, ALL TEMPORARY EROSION CONTROLS AND RETAINED MOVED AND DISPOSED OF PROPERLY, UNLESS NEEDED FOR LONG TERM USE FOLLOWING TERMINATION OF PERMIT

COVERAGE. (SECTION 2.2.21) 43. THE PERMITTEE IS REQUIRED TO MEET ALL THE CONDITIONS OF THE 1200C PERMIT. THIS ESCP AND GENERAL CONDITIONS HAVE BEEN DEVELOPED TO FACILITATE COMPLIANCE WITH THE 1200C PERMIT. REQUIREMENTS. IN CASES OF DISCREPANCIES OR OMISSIONS, THE 1200C PERMIT REQUIREMENTS SUPERCEDE REQUIREMENTS OF THIS PLAN

#### BMP MATRIX FOR CONSTRUCTION PHASES

REFER TO DEQ GUIDANCE MANUAL FOR A COMPREHENSIVE LIST OF AVAILABLE BMP'S

		MASS	UTILITY	PAVEMENT	FINAL
	CLEARING	GRADING	INSTALLATION	CONSTRUCTION	STABILIZATIO
<b>EROSION PREVENTION</b>					
PRESERVE NATURAL VEGETATION	X**	Х	Х	X	X
GROUND COVER					Х
HYDRAULIC APPLICATIONS					
PLASTIC SHEETING					
MATTING					
DUST CONTROL	Х	Х	Х	Х	Х
TEMPORARY/ PERMANENT SEEDING			Х	Х	Х
BUFFER ZONE	X**		Х	X	Х
BONDED FIBER MATRIX					
OTHER:					
SEDIMENT CONTROL					
SILT FENCE (PERIMETER)	X**	Х	Х	X	Х
COMPOST FILTER SOCK (EXTERIOR)	X**	Х	Х	Х	Х
STRAW WATTLES	X**	Х	Х	Х	Х
FILTER BERM				Х	Х
INLET PROTECTION	X**	Х	Х	Х	Х
DEWATERING					
SEDIMENT TRAP					
OTHER:					
RUN OFF CONTROL					•
CONSTRUCTION ENTRANCE	X**		Х	X	х
PIPE SLOPE DRAIN					
OUTLET PROTECTION					
SURFACE ROUGHENING					
CHECK DAMS	X**				
OTHER:					
POLLUTION PREVENTION					
PROPER SIGNAGE	Х	Х	х	x	Х
HAZ WASTE MGMT	X	X	X	X	X
SPILL KIT ON-SITE	X	X	Х	X	X
CONCRETE WASHOUT AREA		X	Х	X	X
OTHER:					

\*\* SIGNIFIES BMP THAT WILL BE INSTALLED PRIOR TO ANY GROUND DISTURBING ACTIVITY.

#### RATIONALE STATEMENT

A COMPREHENSIVE LIST OF AVAILABLE BEST MANAGEMENT PRACTICES (BMP) OPTIONS BASED ON DEQ'S GUIDANCE MANUAL HAS BEEN REVIEWED TO COMPLETE THIS EROSION AND SEDIMENT CONTROL PLAN. SOME OF THE ABOVE LISTED BMP's WERE NOT CHOSEN BECAUSE THEY WERE DETERMINED TO NOT EFFECTIVELY MANAGE EROSION PREVENTION AND SEDIMENT CONTROL FOR THIS PROJECT BASED ON SPECIFIC SITE CONDITIONS, INCLUDING SOIL CONDITIONS TOPOGRAPHIC CONSTRAINTS, ACCESSIBILITY TO THE SITE, AND OTHER RELATED CONDITIONS, AS THE PROJECT PROGRESSES AND THERE IS A NEED TO REVISE THE ESC PLAN, AN ACTION PLAN WILL BE SUBMITTED.

	INITIAL
PERMITTEE'S SITE INSPECTOR:	
COMPANY/AGENCY: PHONE:	
FAX:	
E-MAIL:	
DESCRIPTION OF EXPERIENCE:	

#### NARRATIVE DESCRIPTIONS:

#### **EXISTING CONDITIONS:**

EXISTING CONDITIONS INCLUDE RUNWAYS, TAXIWAYS, APRONS, HANGARS, AND ASSOCIATED UTILITIES FOR AVIATION OPERATIONS.

#### **DEVELOPED CONDITIONS:**

BITUMINOUS PAVEMENT CONSTRUCTION OF TAXIWAY A AND ASSOCIATED DRAINAGE, LIGHTING, SIGNAGE, FENCING, RETAINING WALL, AND MARKINGS.

#### **SCHEDULE:**

- CLEARING: SEPTEMBER 2024 TO JUNE 2025 MASS GRADING: SEPTEMBER 2024 TO JUNE 2025
- UTILITY INSTALLATION: SEPTEMBER 2024 TO JUNE 2025
- PAVEMENT CONSTRUCTION: SEPTEMBER 2024 TO JUNE 2025

TOTAL DISTURBED AREA\*\* = 120,192 SF = 2.76 ACRES

FINAL STABILIZATION: SEPTEMBER 2024 TO JUNE 2025

TOTAL SITE AREA = 120,192 SF = 2.76 ACRES

\*\*DISTURBED AREA DOES NOT INCLUDE PAVEMENT MILL AND INLAY AREAS SITE SOIL CLASSIFICATION:

#### SEVERAL HYDRIC SOIL TYPES ARE WITHIN THE PROJECT AREA. PRIMARILY THERE ARE MEDIUM

STIFF, MEDIUM-BROWN SILTY CLAYS, WITH A COMPONENT OF FRACTURED COBBLE. UNDERNEATH THIS LAYER EXISTS A NATURAL STIFF, MEDIUM TO DARK BROWN, CLAY.

#### **RECEIVING WATER BODIES:**

NEAREST WATER BODY: NEWTON CREEK

## PROJECT LOCATION:

3896 NW STEWART PARKWAY. PROJECT ADDRESS: ROSEBURG, OR 97470 NORTH SIDE OF AIRFIELD. ACTUAL ADDRESS:

1. ACTIVE PERIOD

(Schedule A.8.c.i.(3))

LOCATION. (Schedule B.2.a)

ACCESS OFF OF AVIATION DRIVE LATITUDE = 43° 14' 21.6102" N, LONGITUDE = 123° 21' 21.0569" W

SITE CONDITION

**INSPECTION FREQUENCY:** 

PRIOR TO THE SITE BECOMING INACTIVE OR

INACTIVE PERIODS GREATER THAN FOURTEEN

INACCESSIBLE DUE TO INCLEMENT WEATHER.

IN ANTICIPATION OF SITE INACCESSIBILITY.

(14) CONSECUTIVE CALENDAR DAYS.

PERIODS DURING WHICH THE SITE IS

PERIODS DURING WHICH DISCHARGE IS

UNLIKELY DUE TO FROZEN CONDITIONS.

#### PROPERTY DESCRIPTION: DEVELOPER:

**REGIONAL AIRPORT** 

MINIMUM FREQUENCY

MADE PRIOR TO LEAVING THE SITE.

RUNOFF IS OCCURRING.

ONCE EVERY MONTH.

DOWNSTREAM LOCATION.

DISCHARGES LIKELY

HOLD A PRE-CONSTRUCTION MEETING OF PROJECT CONSTRUCTION PERSONNEL THAT INCLUDES THE

\* ALL INSPECTIONS MUST BE MADE IN ACCORDANCE WITH DEQ 1200-C PERMIT REQUIREMENTS. \* INSPECTION LOGS MUST BE KEPT IN ACCORDANCE WITH DEQ'S 1200-C PERMIT REQUIREMENTS.

INSPECTOR TO DISCUSS EROSION AND SEDIMENT CONTROL MEASURES AND CONSTRUCTION LIMITS.

\* RETAIN A COPY OF THE ESCP AND ALL REVISIONS ON SITE AND MAKE IT AVAILABLE ON REQUEST TO DEQ. AGENT, OR THE LOCAL MUNICIPALITY. DURING INACTIVE PERIODS OF GREATER THAN SEVEN (7) CONSECUTIVE CALENDAR DAYS, RETAIN THE ESCP AT THE CONSTRUCTION SITE OR AT ANOTHER

DAILY WHEN STORMWATER RUNOFF, INCLUDING

AT LEAST ONCE EVERY FOURTEEN (14) CALENDAR

DAYS REGARDLESS OF WHETHER STORMWATER

ONCE TO ENSURE THAT EROSION AND SEDIMENT CONTROL MEASURES ARE IN WORKING ORDER. ANY

NECESSARY MAINTENANCE AND REPAIR MUST BE

IF PRACTICAL, INSPECTIONS MUST OCCUR DAILY AT A

MONTHLY. RESUME MONITORING IMMEDIATELY UPON

MELT, OR WHEN WEATHER CONDITIONS MAKE

RELEVANT AND ACCESSIBLE DISCHARGE POINT OR

RUNOFF FROM SNOW MELT, IS OCCURRING.

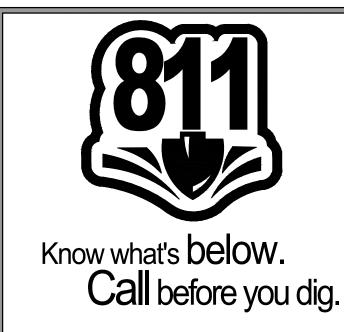
900 SE DOUGLAS AVE. ROSEBURG, OR 97470

## PLANNING / ENGINEERING /

ROSEBURG REGIONAL AIRPORT MEAD & HUNT, INC CONTACT: NIKKI MESSENGER CONTACT: MARK FORSLUND 9600 NE CASCADES PARKWAY, SUITE 100 PORTLAND, OR 97220 PHONE: 541-492-6730 PHONE: 971-256-0888

#### ATTENTION EXCAVATORS

OREGON LAW REQUIRES YOU TO FOLLOW RULES ADOPTED BY THE OREGON UTILITY NOTIFICATION CENTER. THOSE RULES ARE SET FORTH IN OAR 952-001-0010 THROUGH OAR 952-001-0100. YOU MAY OBTAIN COPIES OF THESE RULES FROM THE CENTER BY CALLING 503-232-1987. IF YOU HAVE ANY QUESTIONS ABOUT THE RULES, YOU MAY CONTACT THE CENTER. YOU MUST NOTIFY THE CENTER AT LEAST TWO BUSINESS DAYS, BEFORE COMMENCING AN EXCAVATION. CALL 503-246-6699.



#### ATTENTION

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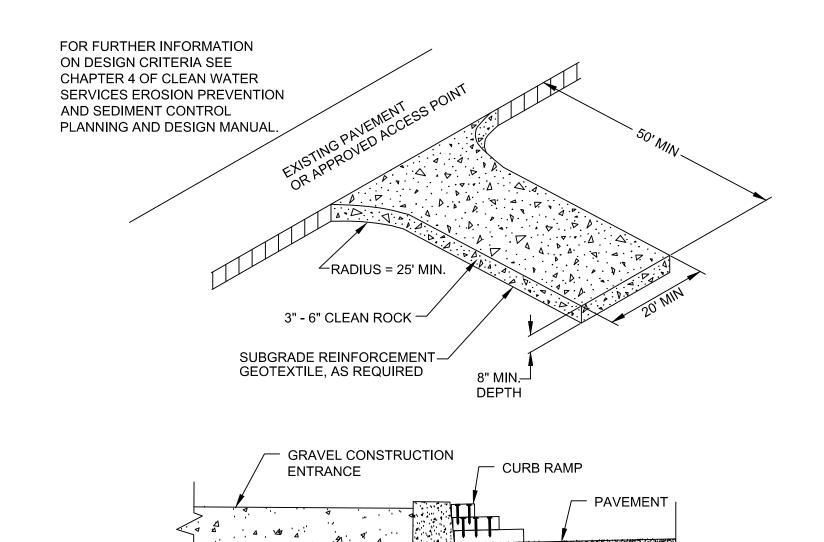
AIP NO.: 3-41-0054-030-2024 M&H NO. 1821200-221217.01 DATE: APRIL 18, 2024 DESIGNED BY: MLF

DRAWN BY: MJK CHECKED BY: RJB DO NOT SCALE DRAWINGS

SHEET CONTENTS **EROSION CONTROL** NOTES


SHEET NO. 12 of 40

# 3 CONCRETE WASHOUT DETAIL NO SCALE


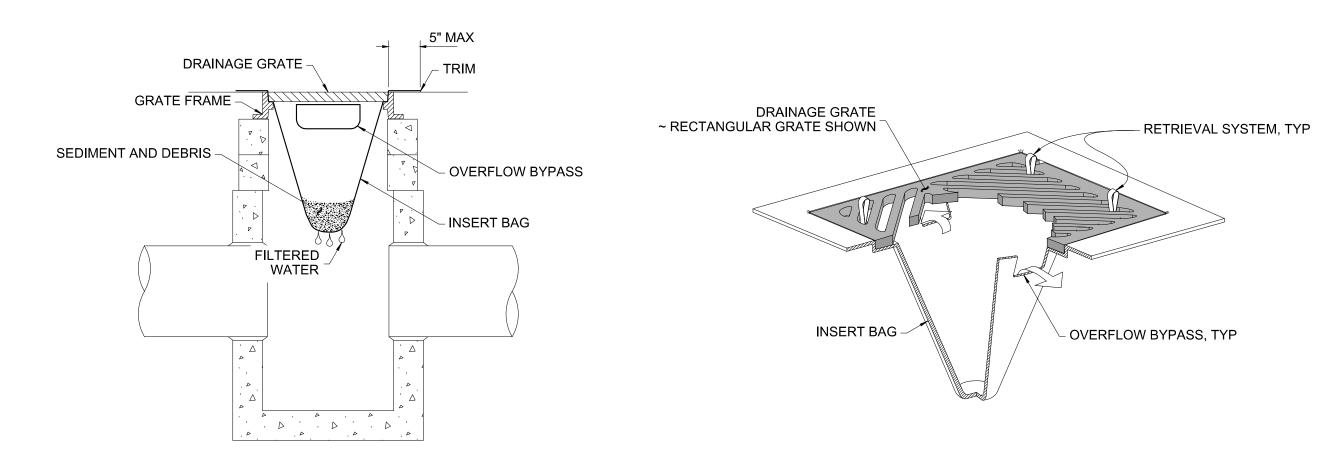
#### NOTES:


- 1. THE ENTRANCE SHALL BE MAINTAINED IN A CONDITION THAT WILL PREVENT TRACKING OR FLOWING OF SEDIMENT ONTO PUBLIC RIGHT-OF-WAYS. THIS MAY REQUIRE TOP DRESSING, REPAIR AND/OR CLEAN OUT OF ANY MEASURES USED TO TRAP SEDIMENT.
- 2. WHEN NECESSARY, WHEELS SHALL BE CLEANED PRIOR TO ENTRANCE ONTO PUBLIC RIGHT-OF-WAY.
- 3. WHEN WASHING IS REQUIRED, IT SHALL BE DONE ON AN AREA STABILIZED WITH CRUSHED STONE THAT DRAINS INTO AN APPROVED SEDIMENT TRAP OR SEDIMENT BASIN.
- 4. WHERE RUNOFF CONTAINING SEDIMENT LADEN WATER IS LEAVING THE SITE VIA THE CONSTRUCTION ENTRANCE, OTHER MEASURES SHALL BE IMPLEMENTED TO DIVERT RUNOFF THROUGH AN APPROVED FILTERING SYSTEM.
- 5. DIMENSIONS
- MIN 50' LONG BY 20' WIDE 3-6" CLEAN ROCK,



#### NOTES

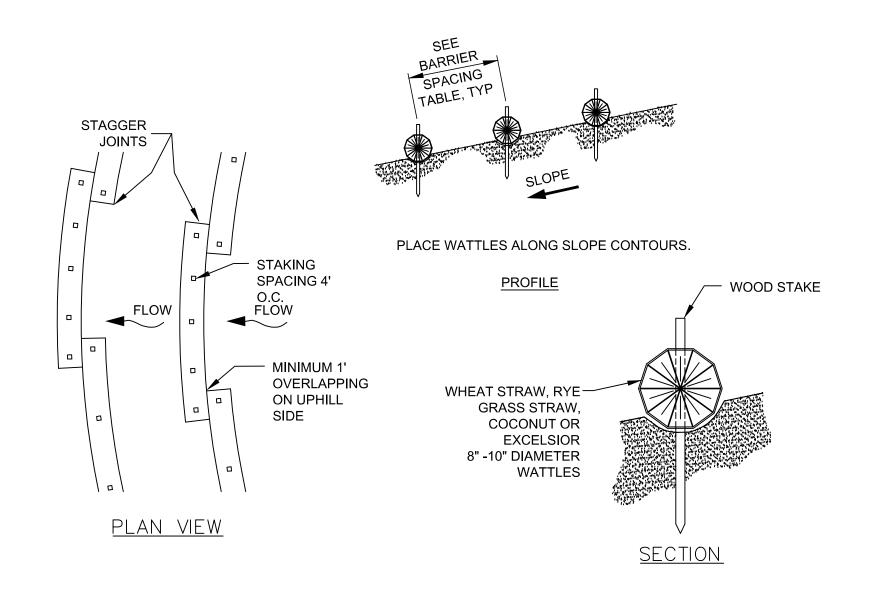- 1. SIZE THE INSERT BAG FOR THE STORM WATER STRUCTURE IT WILL SERVICE.
- 2. THE INSERT BAG SHALL HAVE A BUILT-IN HIGH-FLOW RELIEF SYSTEM (OVERFLOW BYPASS).
- 3. THE RETRIEVAL SYSTEM MUST ALLOW REMOVAL OF THE INSERT BAG WITHOUT SPILLING THE COLLECTED MATERIAL.
- 4. PERFORM MAINTENANCE IN ACCORDANCE WITH ESCP NOTES AND 1200C PERMIT





BARRIER SPACING						
% SLOPE	SLOPE H:V	MAXIMUM SPACING				
10% OR FLATTER	10:1 OR FLATTER	300'				
>10% OR <15%	>10:1 OR <7.5:1	150'				
>15% OR <20%	>7.5:1 OR <5:1	100'				
>20% OR <30%	>5:1 OR <3.5:1	50'				
>30% OR <50%	>3.5:1 OR <2:1	25'				

#### NOTES:

- STAKING SPECIFICATIONS:
   a. 1"X2" WOODEN STAKES
  - b. ADDITIONAL STAKES MAY BE INSTALLED ON DOWNHILL SIDE OF WATTLES, ON STEEP SLOPE OR HIGHLY EROSIVE SOILS.
- 2. SPACING IN ACCORDANCE WITH BARRIER SPACING TABLE.
- REMOVE ALL ROCKS, CLODS, VEGETATION OR OTHER OBSTRUCTIONS SO THAT THE INSTALLED WATTLES WILL HAVE DIRECT CONTACT WITH THE SOIL.
- 4. INSTALL THE WATTLES IN A 2" DEEP TRENCH, INSURING THAT NO GAPS EXIST BETWEEN THE SOIL AND THE BOTTOM OF THE WATTLE. THE ENDS OF ADJACENT WATTLES SHALL BE OVERLAPPED 1 FT. MINIMUM TO PREVENT SEDIMENT PASSING THROUGH THE FIELD JOINT.





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GIONAL AIRPORT TENSION

3896 NW STEWART PARKWAY
ROSEBURG, OR 97470

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SHEET CONTENTS

EROSION CONTROL
DETAILS

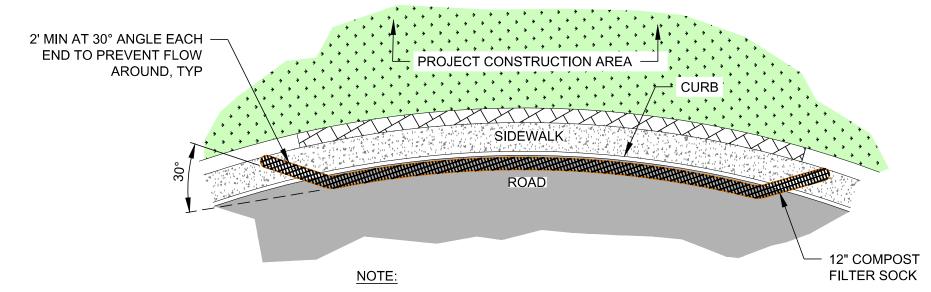
SHEET NO. 13 of 40

C-032

SEDIMENT FENCE DETAIL NO SCALE

SPACING

**FRONT VIEW** 



COMPOST SOCK SHALL BE 12 " SYNTHETIC SOCK MESH FILLED WITH MIXED YARD DEBRIS COMPOST. COMPOST SOCKS SHALL BE PLACED AS A SEAL ON CONCRETE OR ASPHALT SURFACES. SEE EROSION CONTROL PLANS FOR LOCATION.

COMPOST FILTER SOCK

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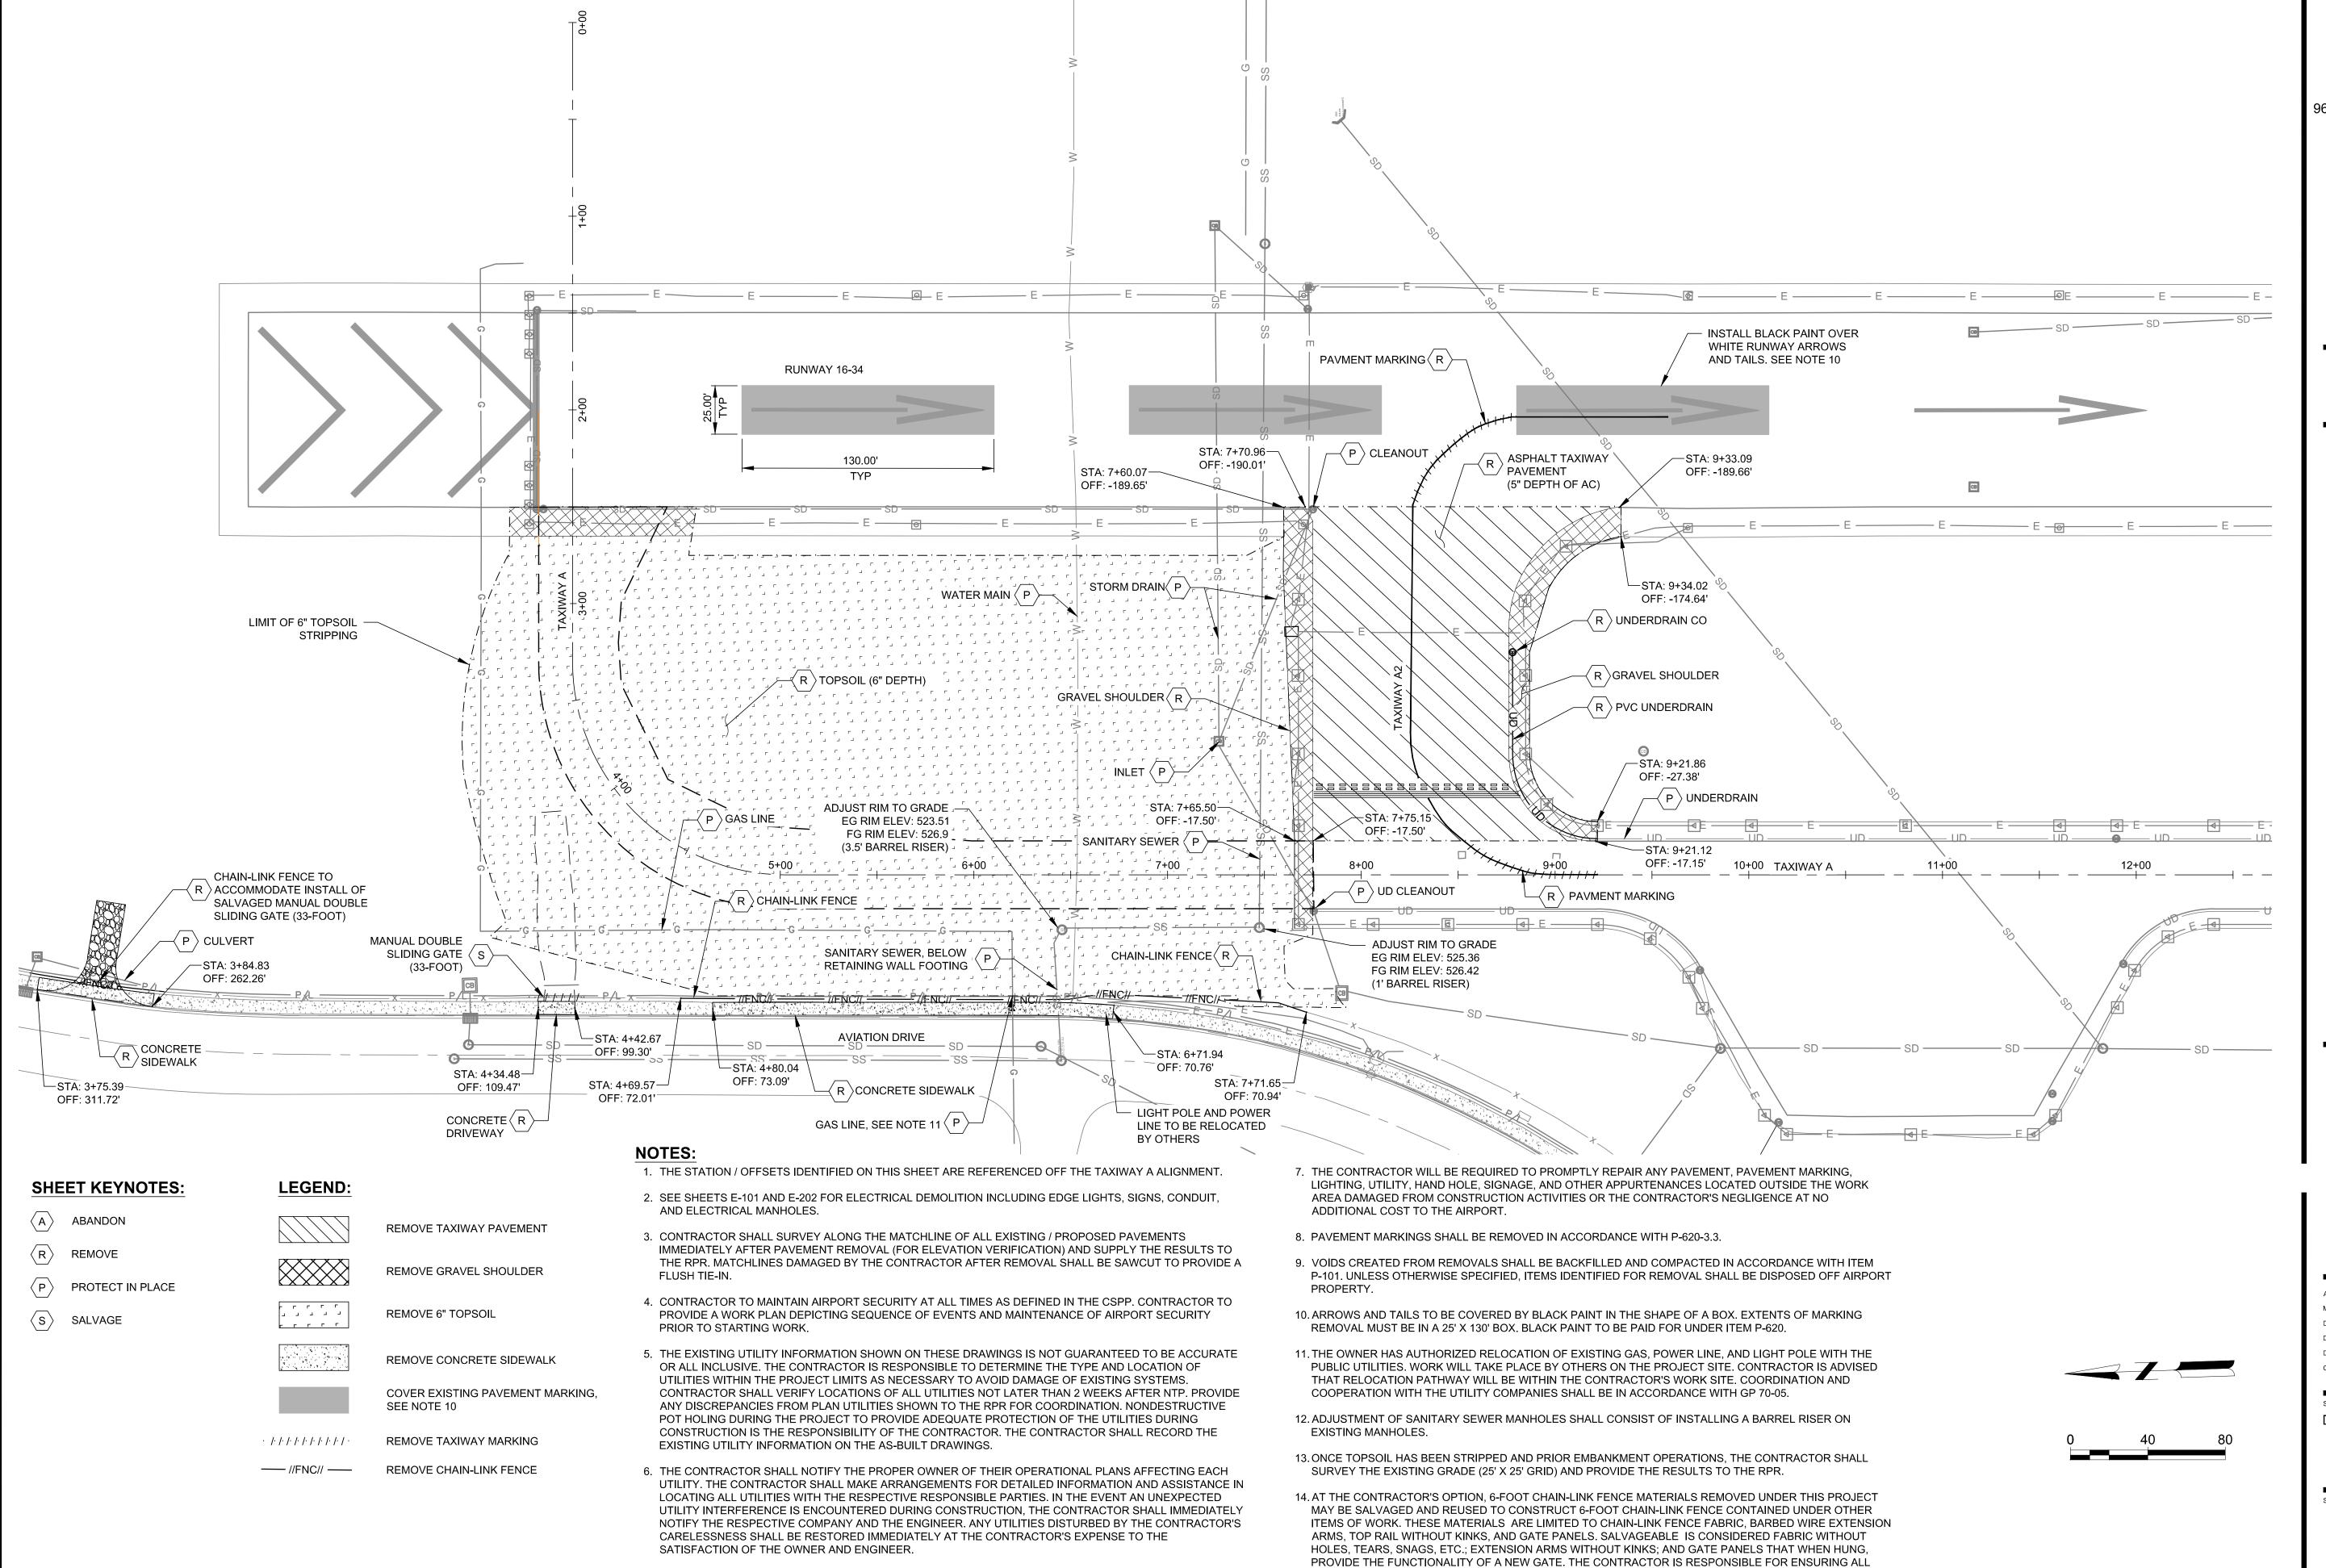
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SHEET CONTENTS **EROSION CONTROL** DETAILS

SHEET NO. 14 of 40



SALVAGED COMPONENTS ARE COMPATIBLE WITH THE NEW MATERIALS BEING PROVIDED.

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SHEET CONTENTS DEMOLITION PLAN

SHEET NO. 15 of 40

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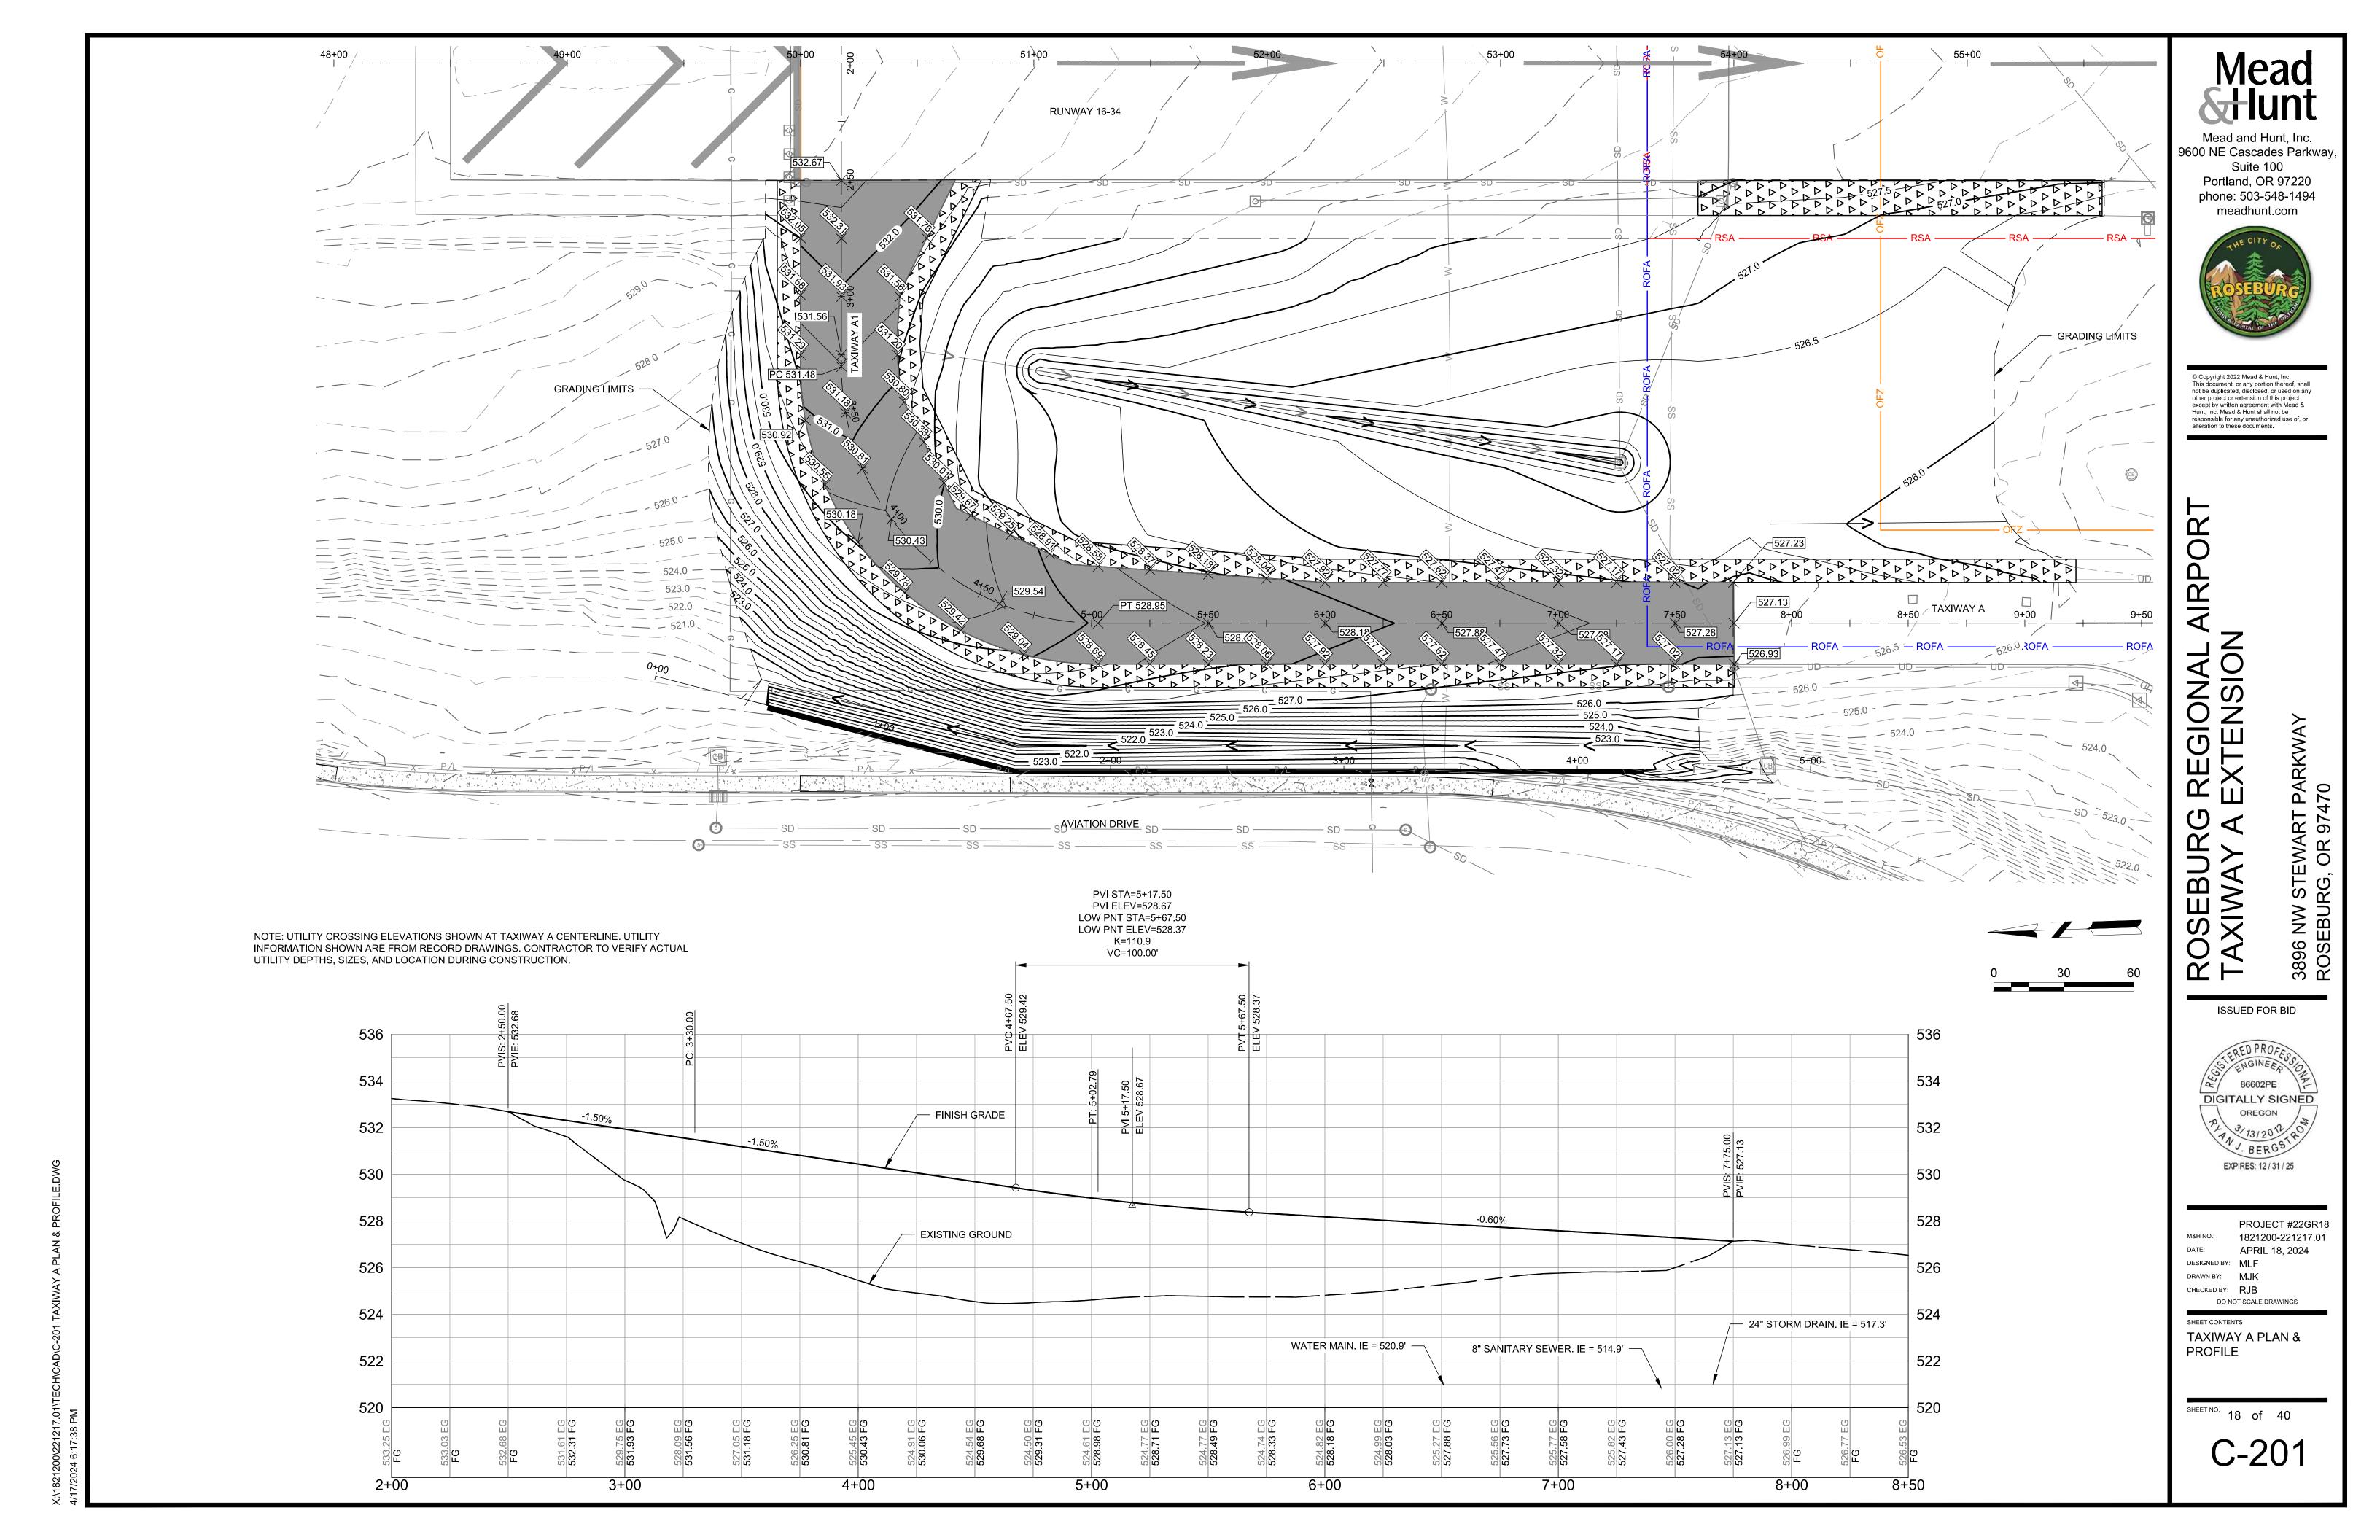
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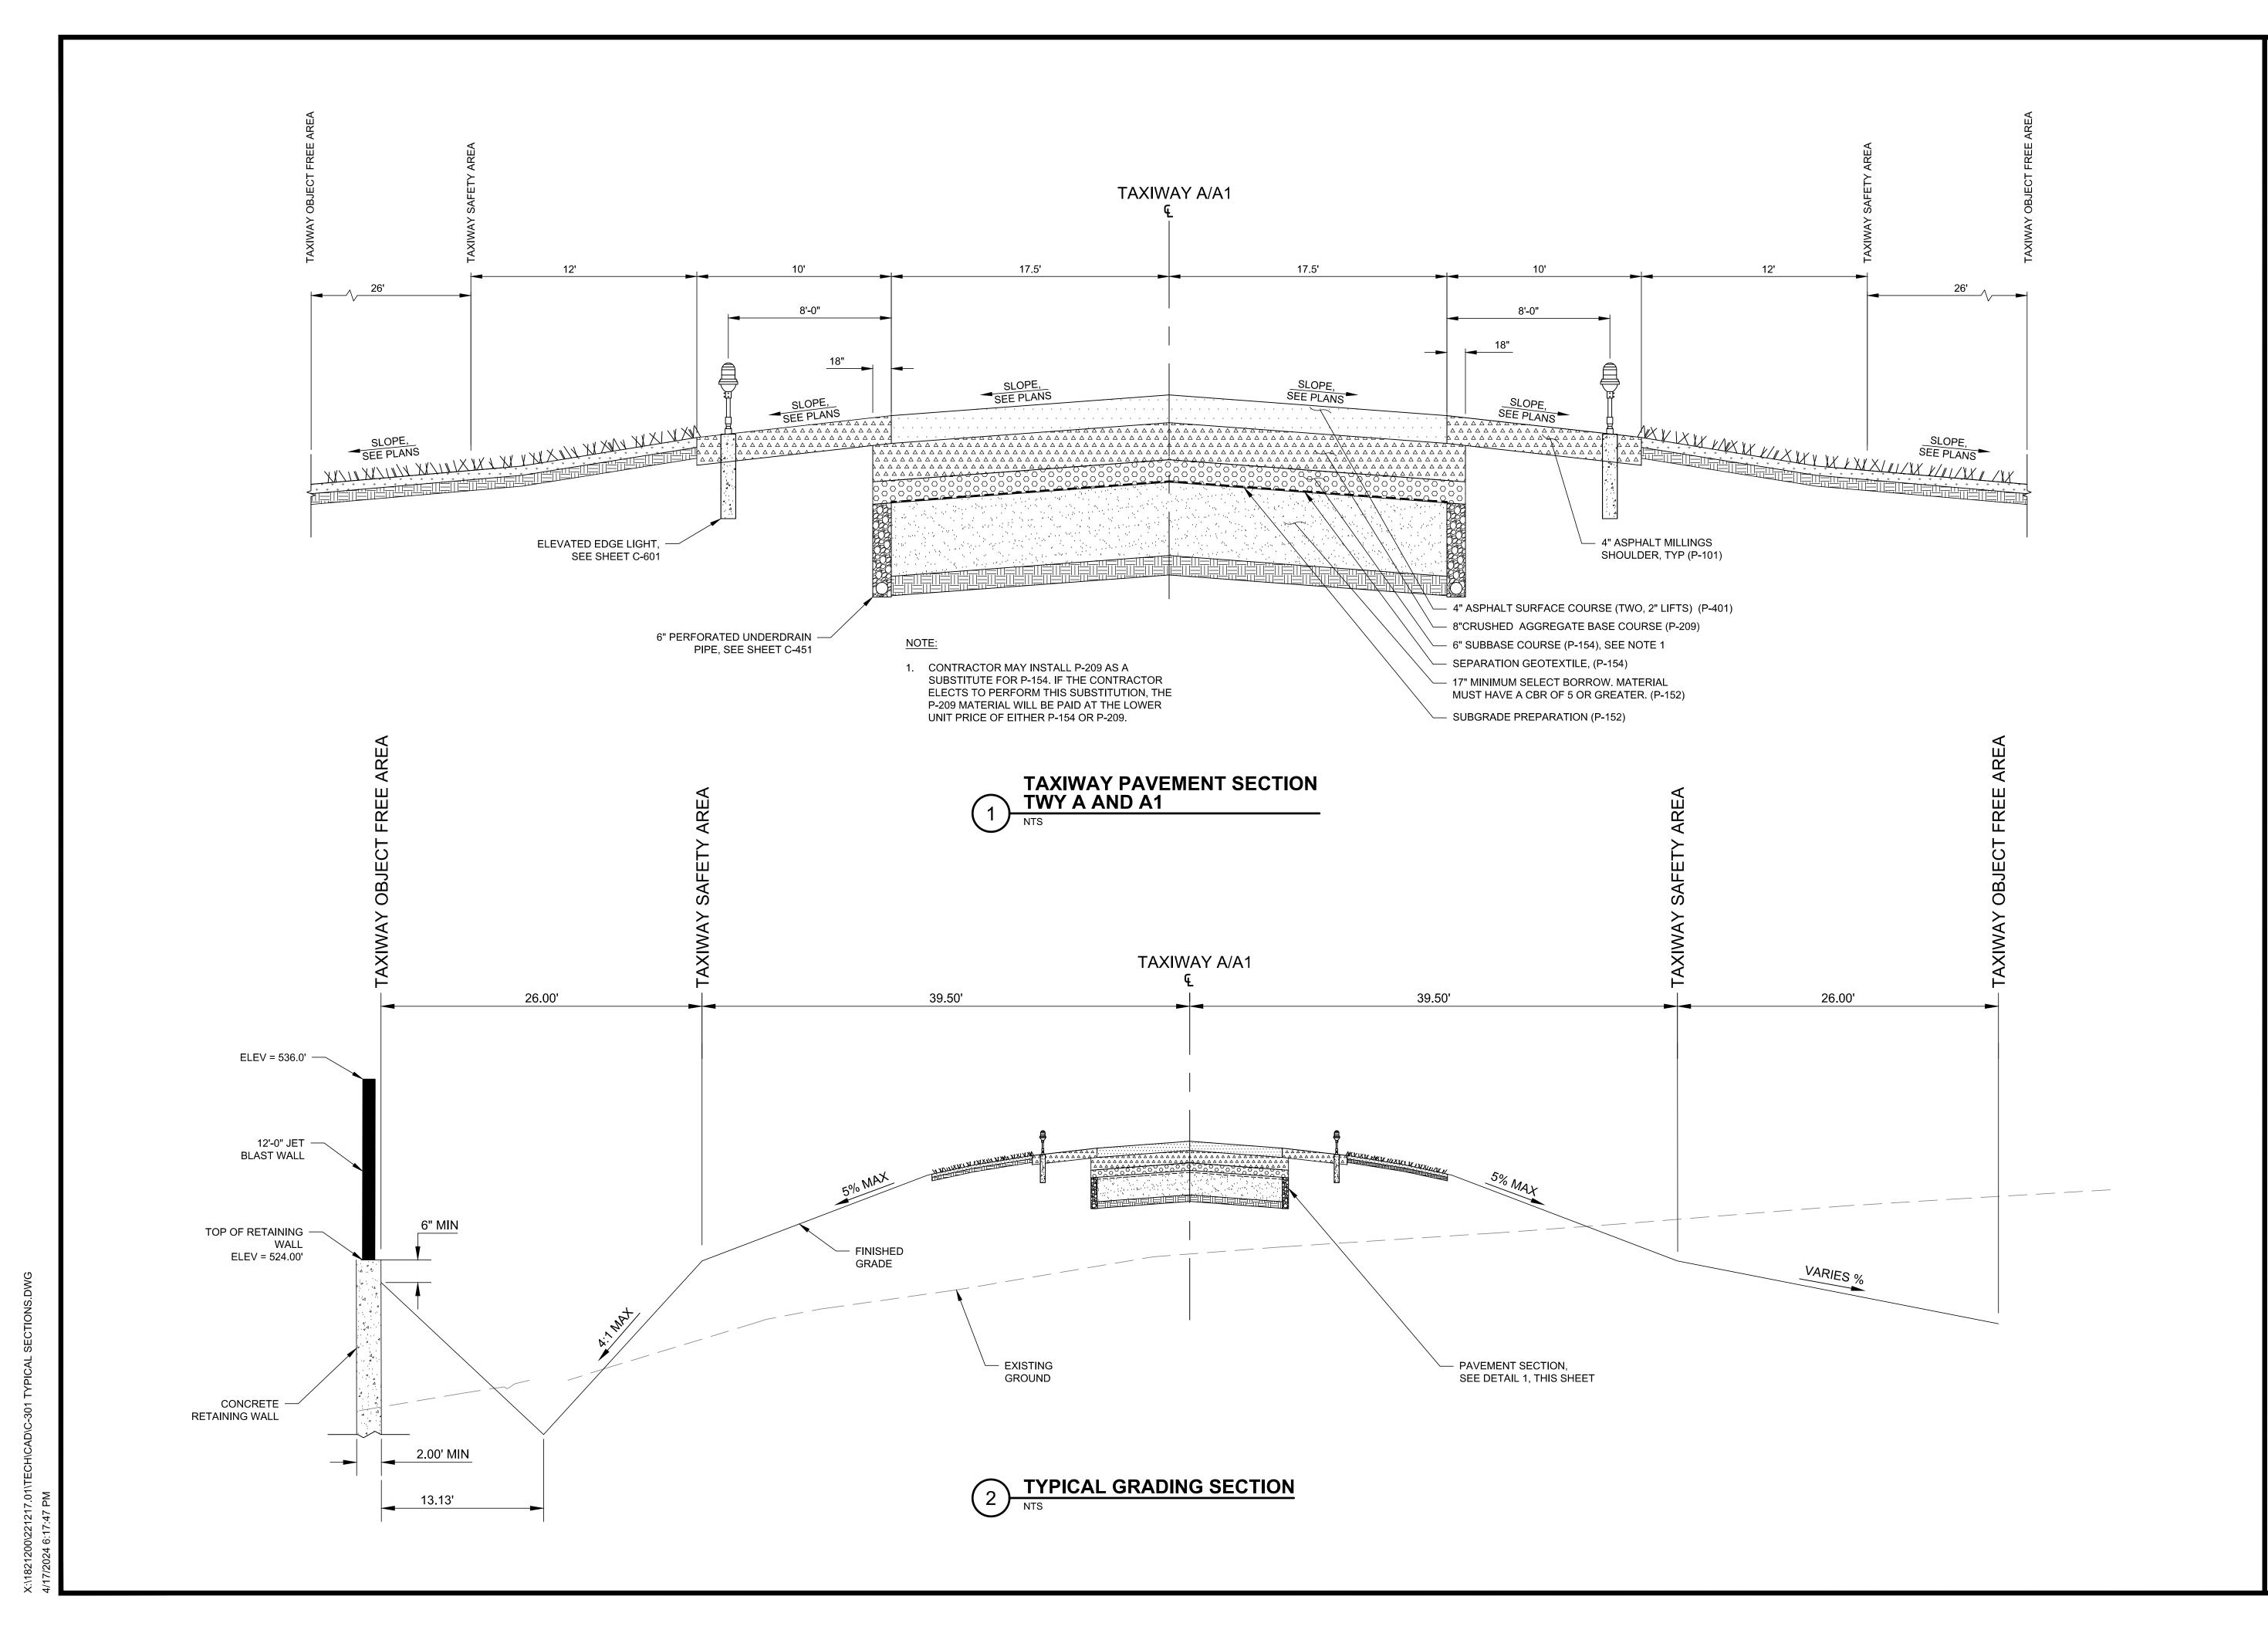


3-41-0054-030-2024 1821200-221217.01 APRIL 18, 2024


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GRADING & DRAINAGE





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DO NOT SCALE DRAWINGS SHEET CONTENTS TYPICAL SECTIONS

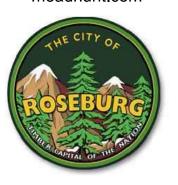
SHEET NO. 19 of 40

C-301

#### NOTES:

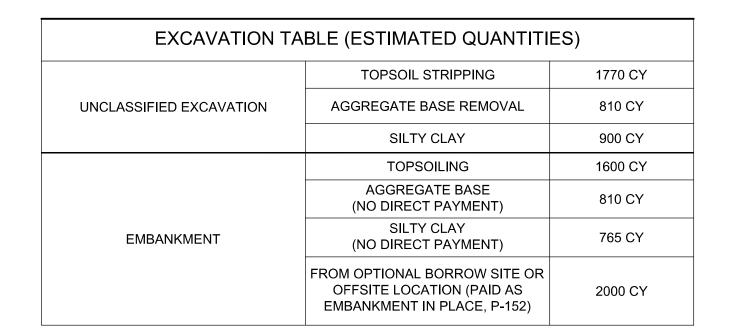
1. SMOOTHNESS REQUIREMENTS FROM NEW TO EXISTING PAVEMENTS SHALL MEET THE REQUIREMENTS OF P-401-5.3.g.





#### NOTES:

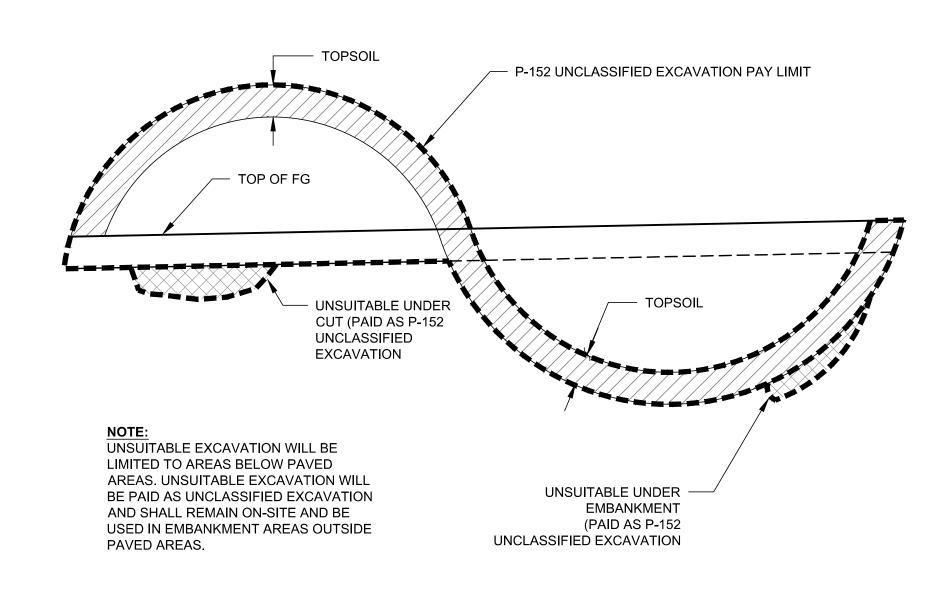- 1. QUANTITIES IN TABLE ARE FOR ESTIMATED PURPOSES ONLY.
- 2. UNCLASSIFIED EXCAVATION SHALL REMAIN ON-SITE AND BE USED AS EMBANKMENT MATERIAL IN THE AREAS ALLOWED PER THE PLANS AND SPECIFICATIONS.
- 3. A SHRINKAGE FACTOR OF 15% HAS BEEN ASSUMED FOR EXCAVATED CLAY MATERIAL. A SHRINKAGE FACTOR OF 10% HAS BEEN ASSUMED FOR EXCAVATED TOPSOIL.



EARTHWORK VOLUME

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**AIRPOI** GIONAL

**XTENSION** AXIWAY 3896 NW STE ROSEBURG,

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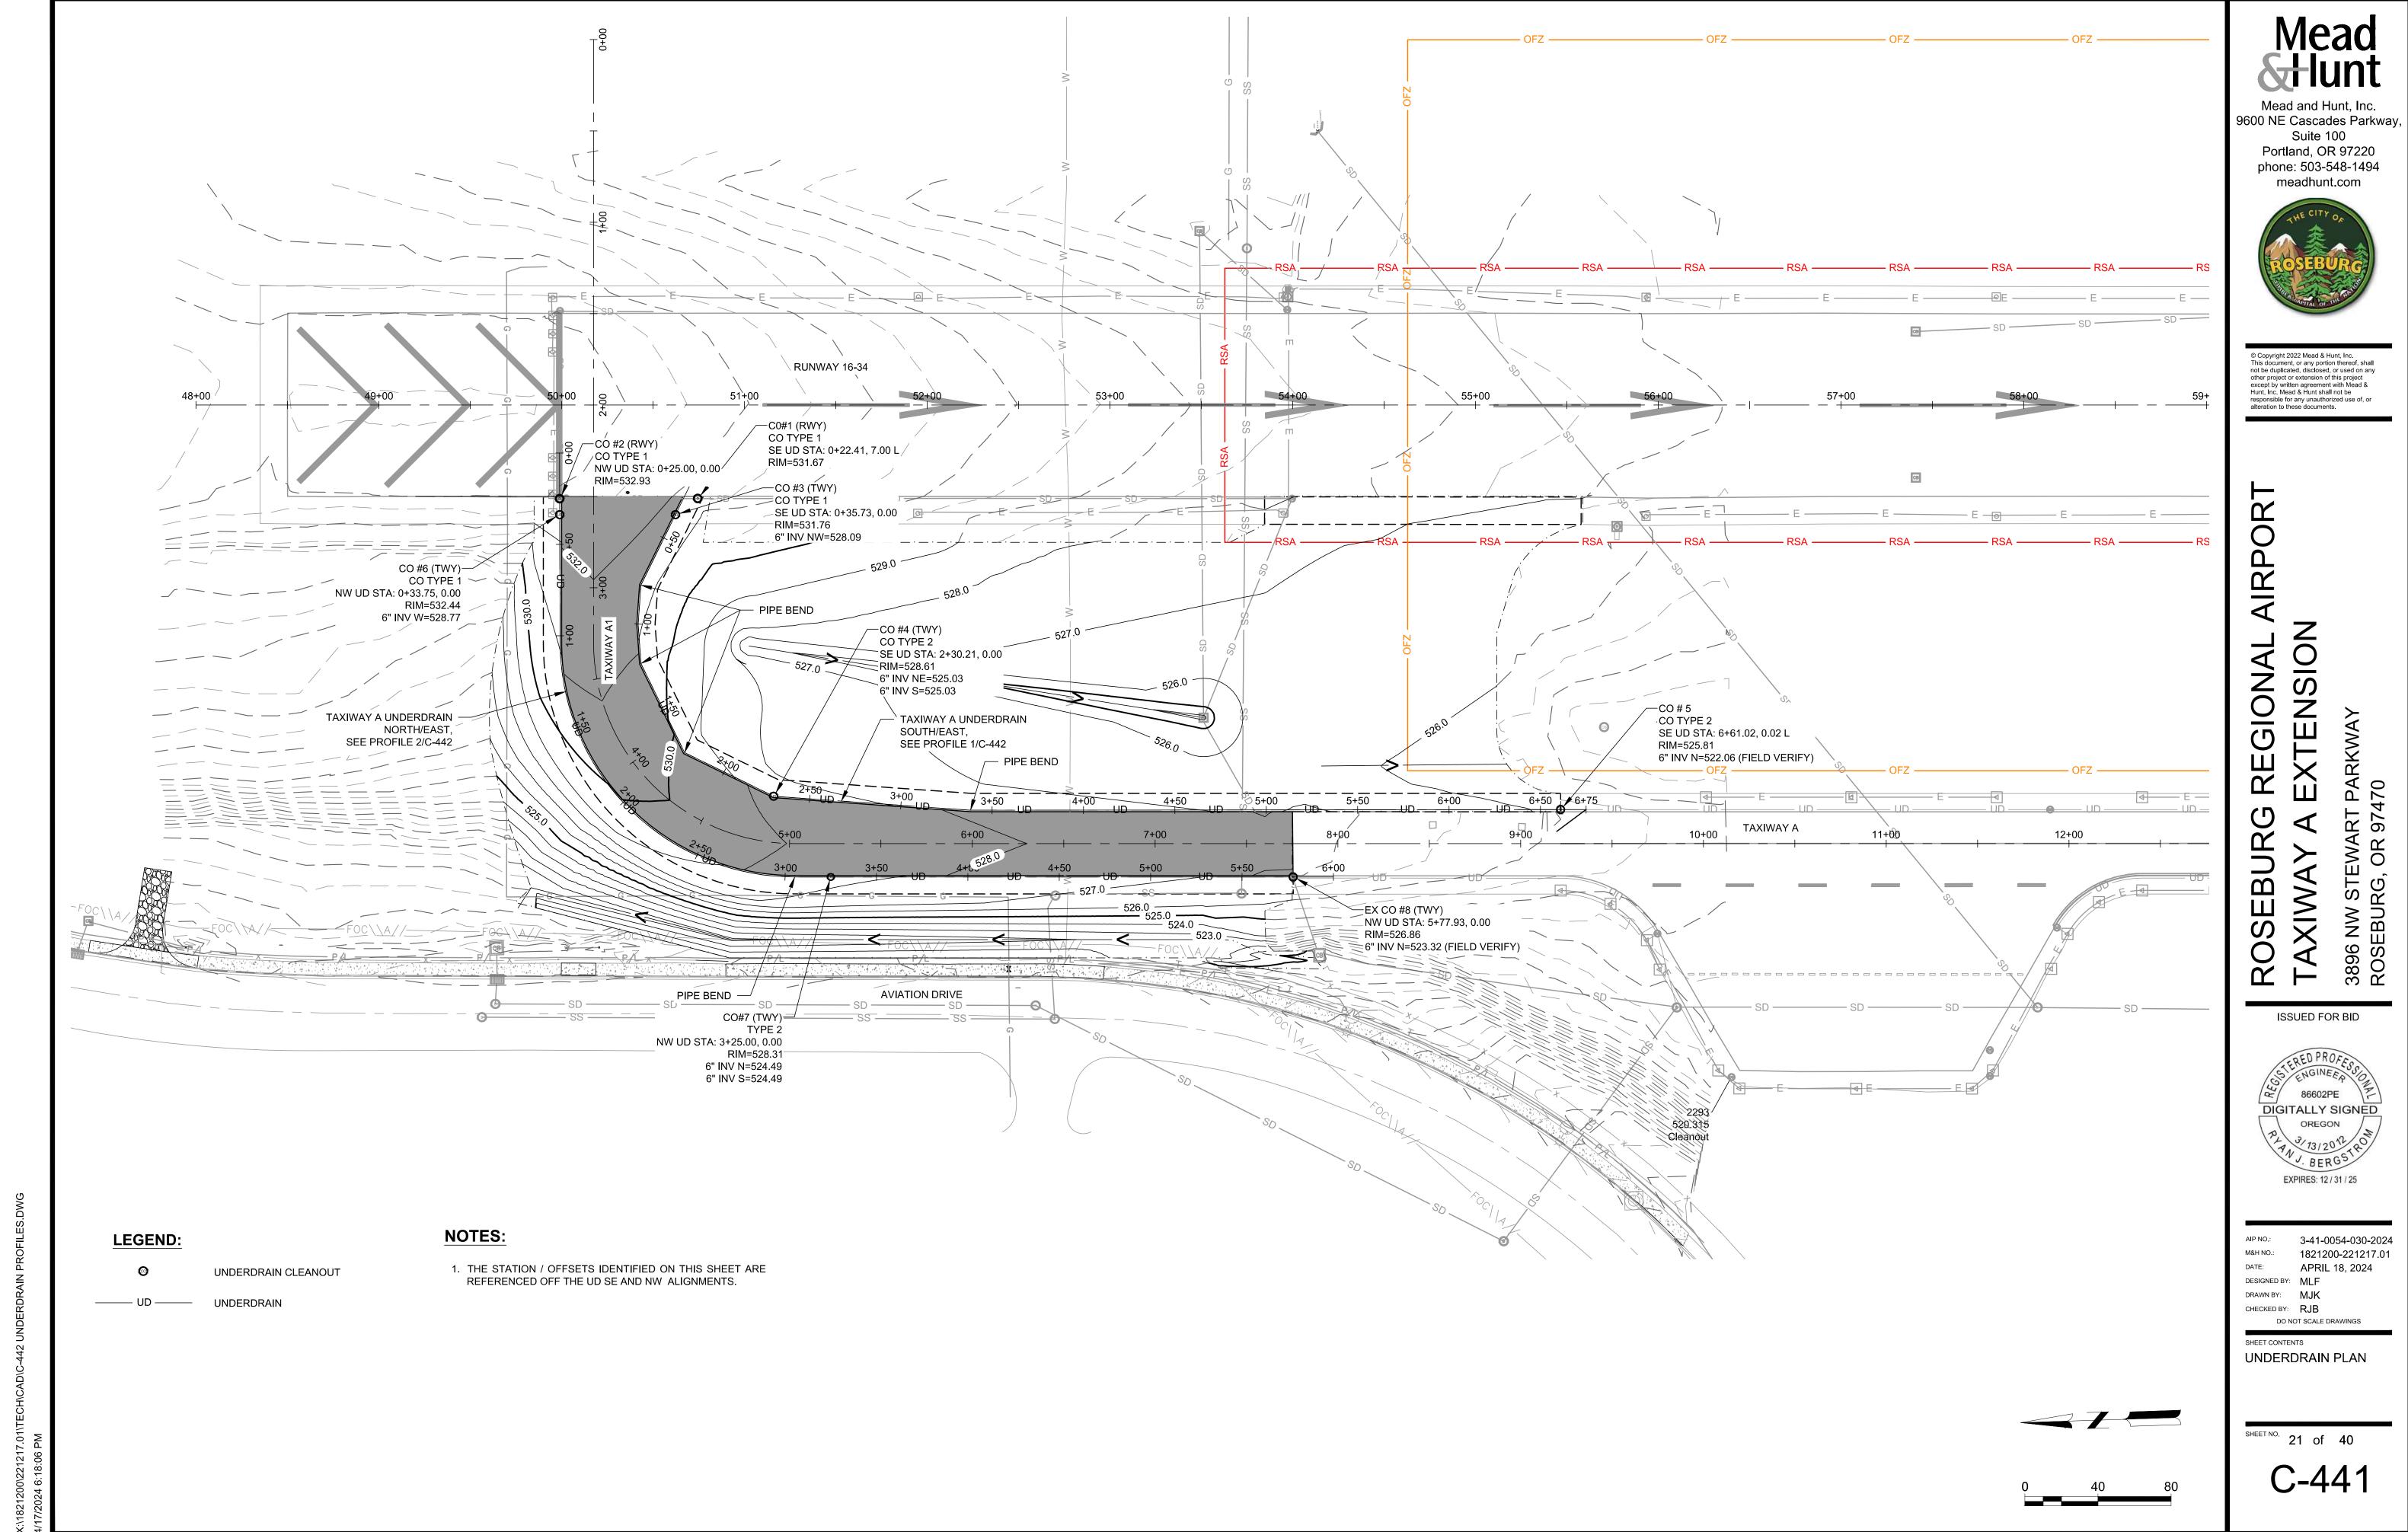
86602PE DIGITALLY SIGNED OREGON 7 3/13/2012 RCSTRO EXPIRES: 12 / 31 / 25

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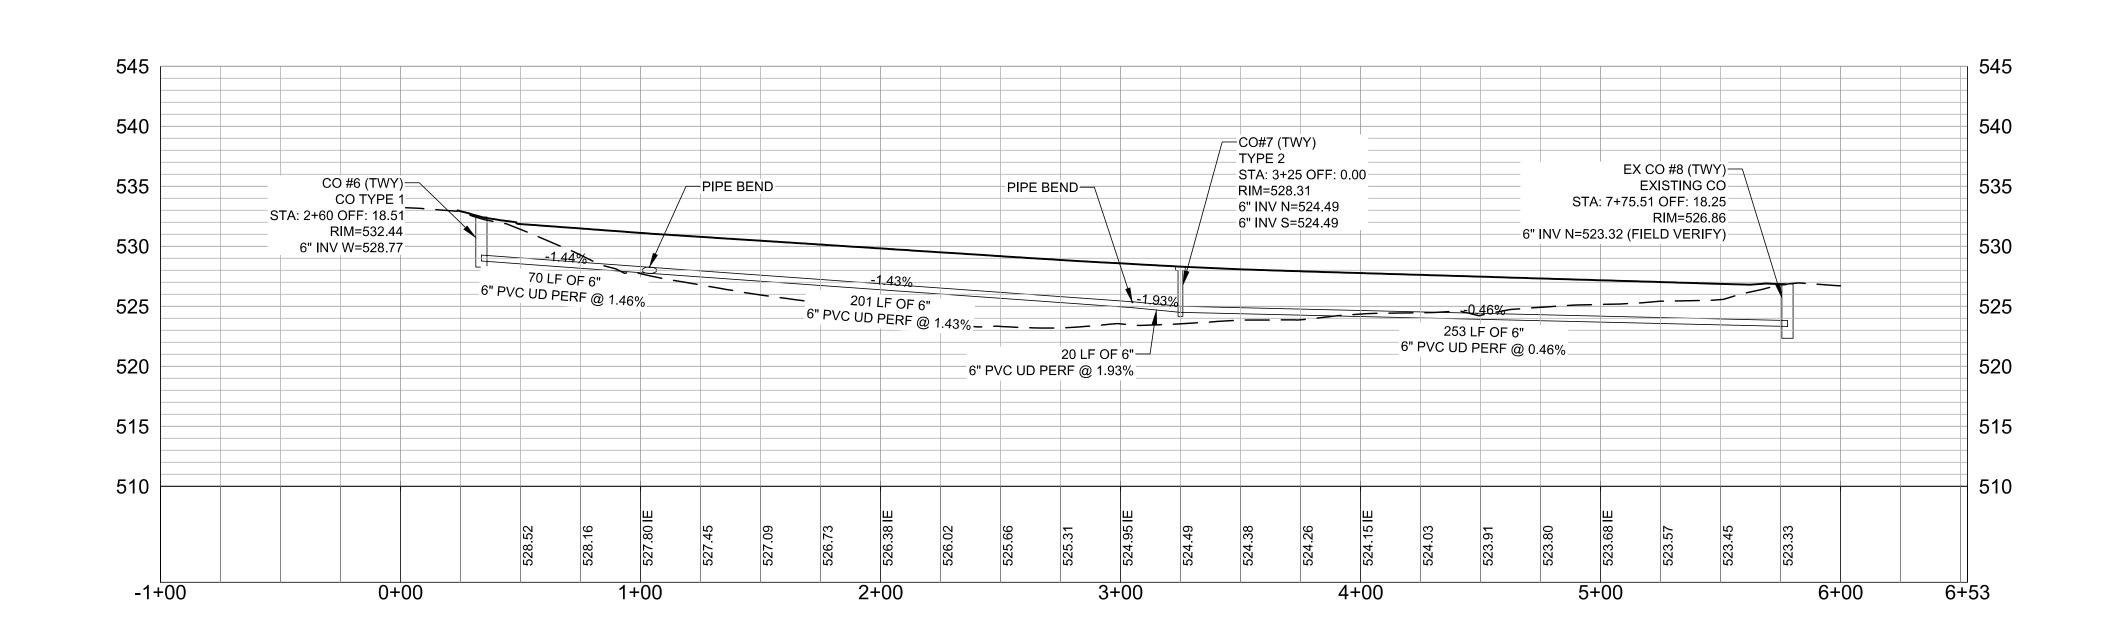
SHEET CONTENTS TYPICAL SECTIONS

SHEET NO. 20 of 40



 THE STATION / OFFSETS
 IDENTIFIED REFERENCED OFF THE UD SE ALIGNMENT.

# TWY A SOUTH/EAST UNDERDRAIN PLAN SCALE: 1" = 40'



#### NOTES:

1. THE STATION / OFFSETS IDENTIFIED REFERENCED OFF THE UD NW ALIGNMENT.



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AIRPOR **XTENSION** REGIONAL T PARKWAY 7470 TAXIWAY 3896 NW STE ROSEBURG, OSEBI

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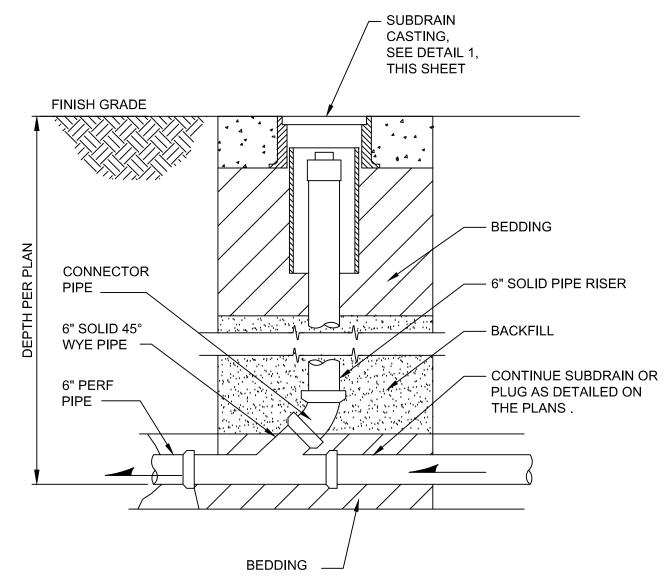
SHEET CONTENTS UNDERDRAIN **PROFILES** 

SHEET NO. 22 of 40

#### NOTES:

- 1. HOLES IN PERFORATED PIPE SHALL BE ORIENTED AS SHOWN.
- 2. CONTRACTOR IS RESPONSIBLE FOR PROTECTING THE ADJACENT PAVEMENT SECTION. ANY DAMAGE RESULTING FROM TRENCHING ACTIVITIES WILL BE REPAIRED AT THE EXPENSE OF THE CONTRACTOR.

# PERFORATED UNDERDRAIN TRENCH



- PLUG END OF WYE. BEDDING \_\_\_ **PROFILE VIEW** PROFILE VIEW

CLEANOUT TYPE 2

NOT TO SCALE



**UNDERDRAIN CASTING** 

FINISH GRADE

CONNECTOR

6" SOLID 45°

WYE PIPE

6" PERF

PIPE —

- SUBDRAIN

SEE DETAIL 1,

THIS SHEET

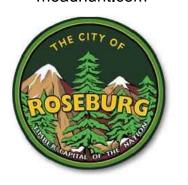
— BEDDING

– BACKFILL

— 6" SOLID PIPE RISER

CASTING,

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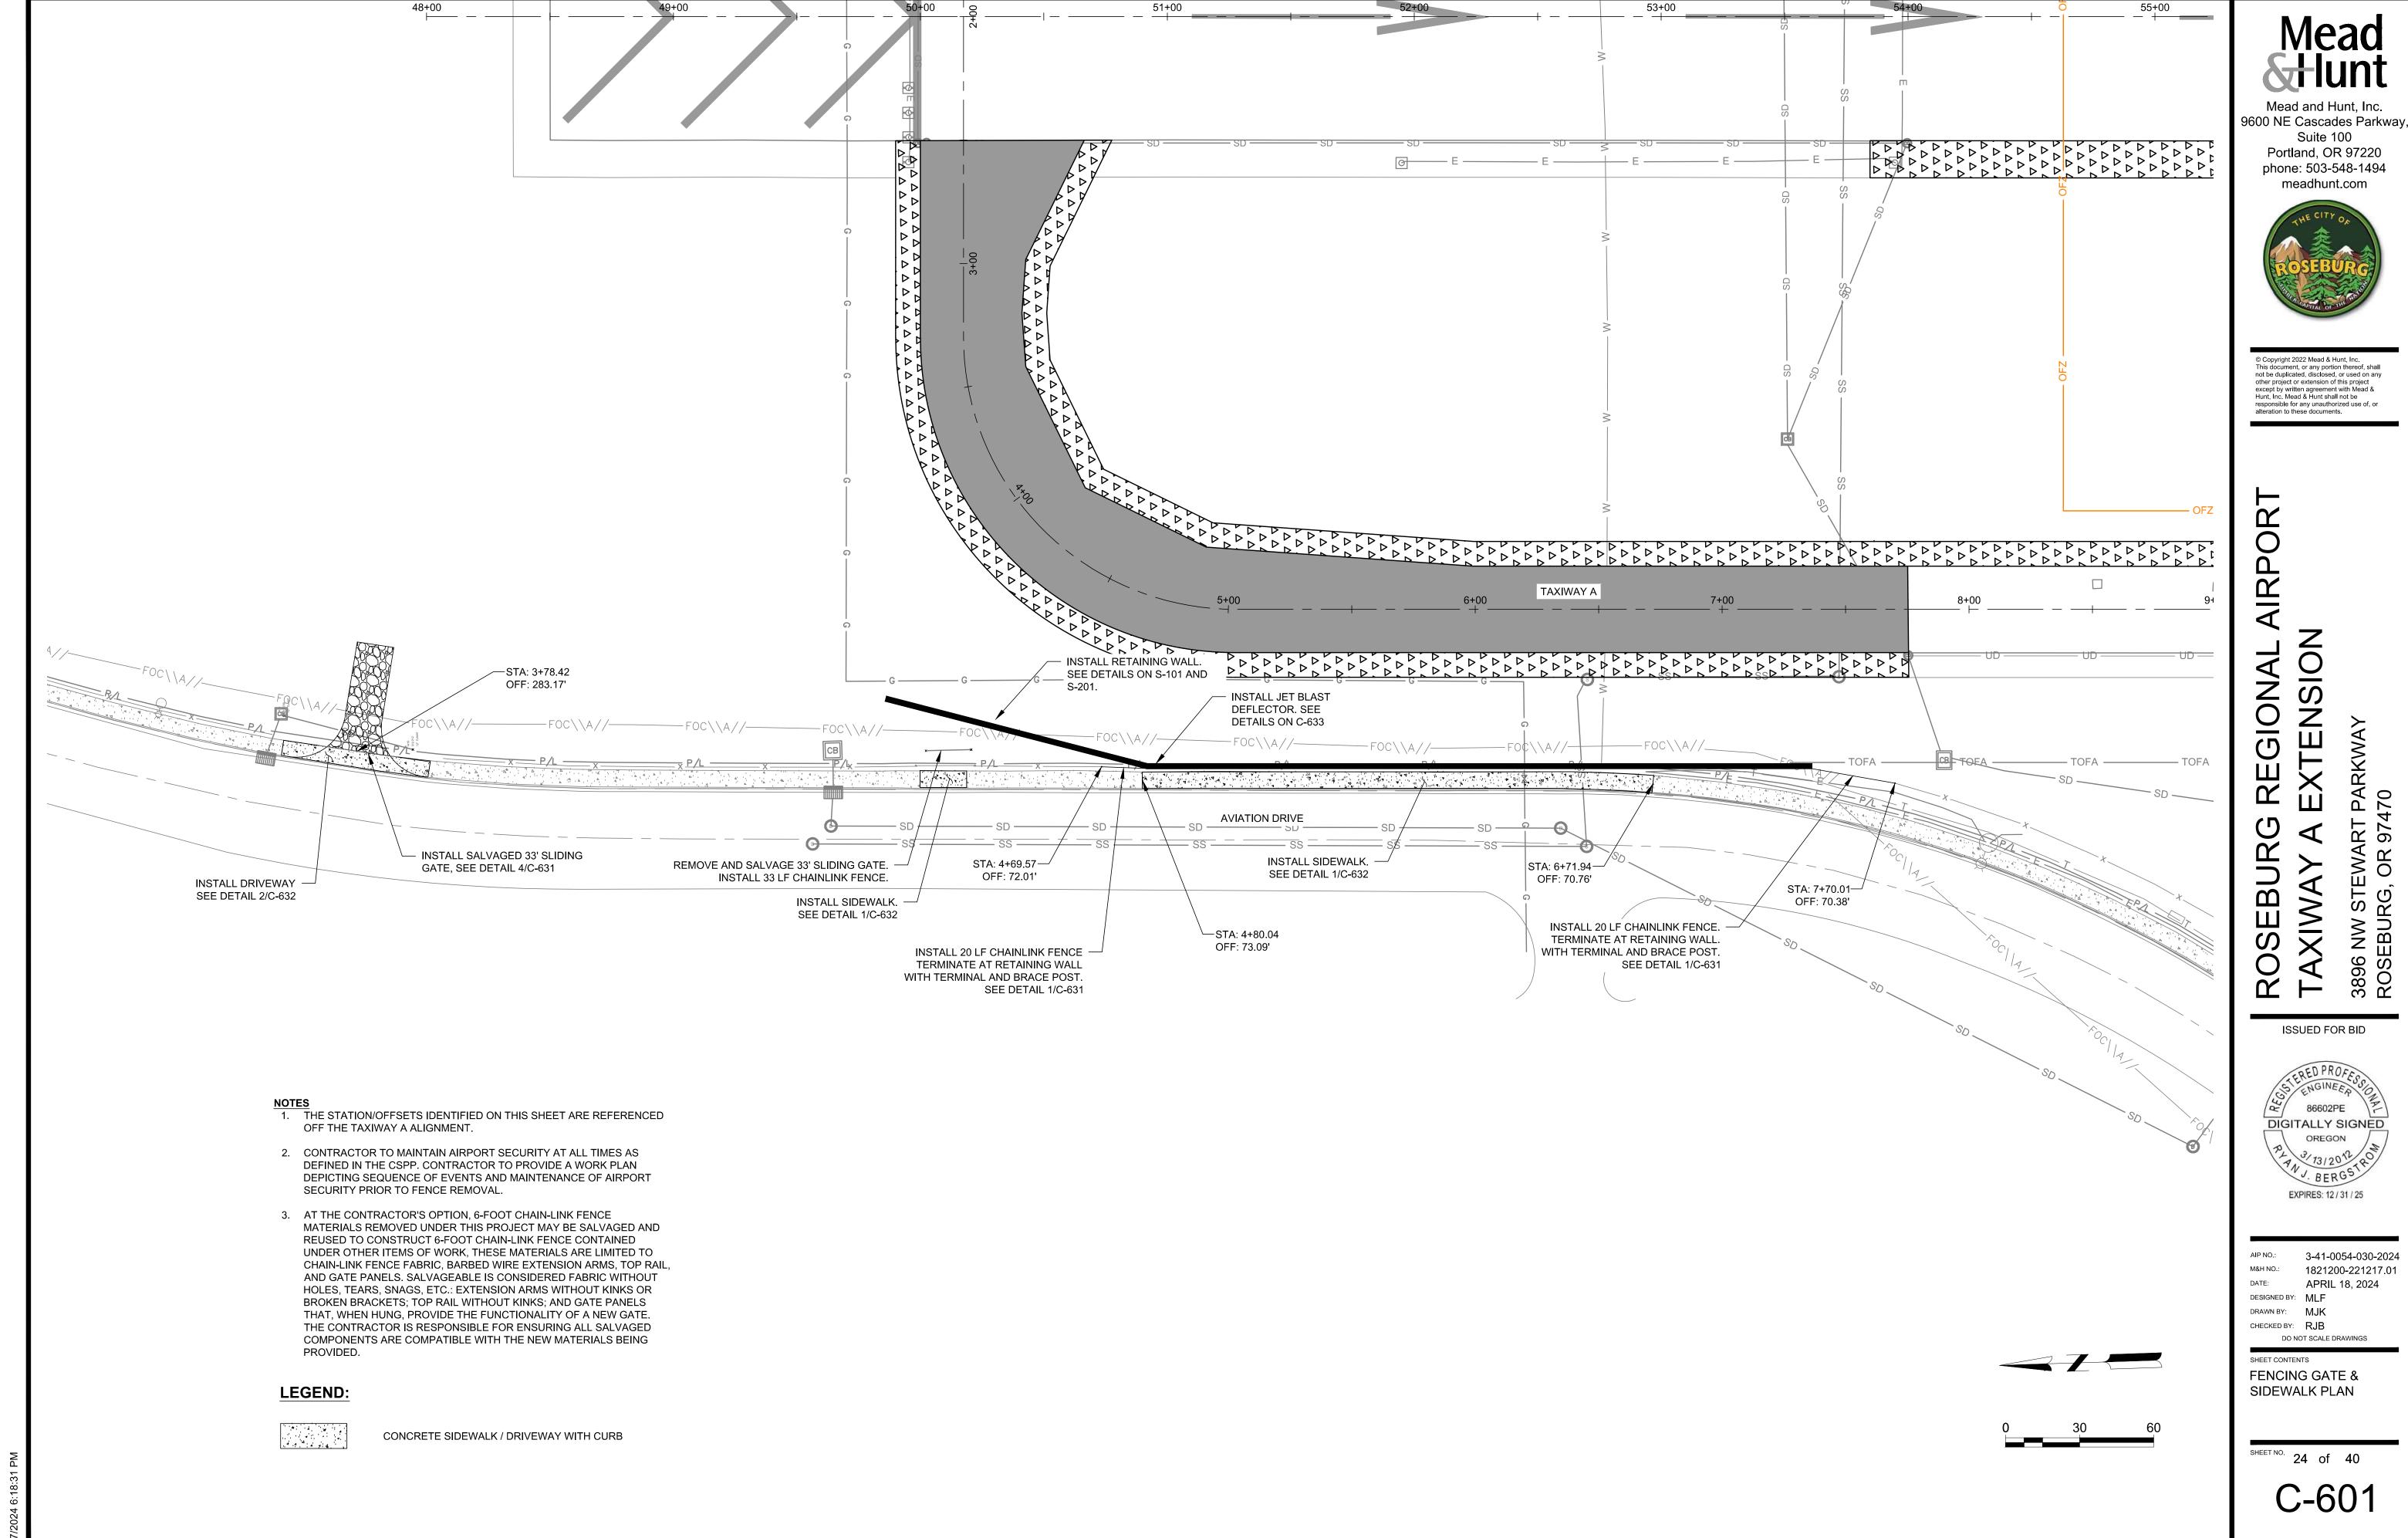
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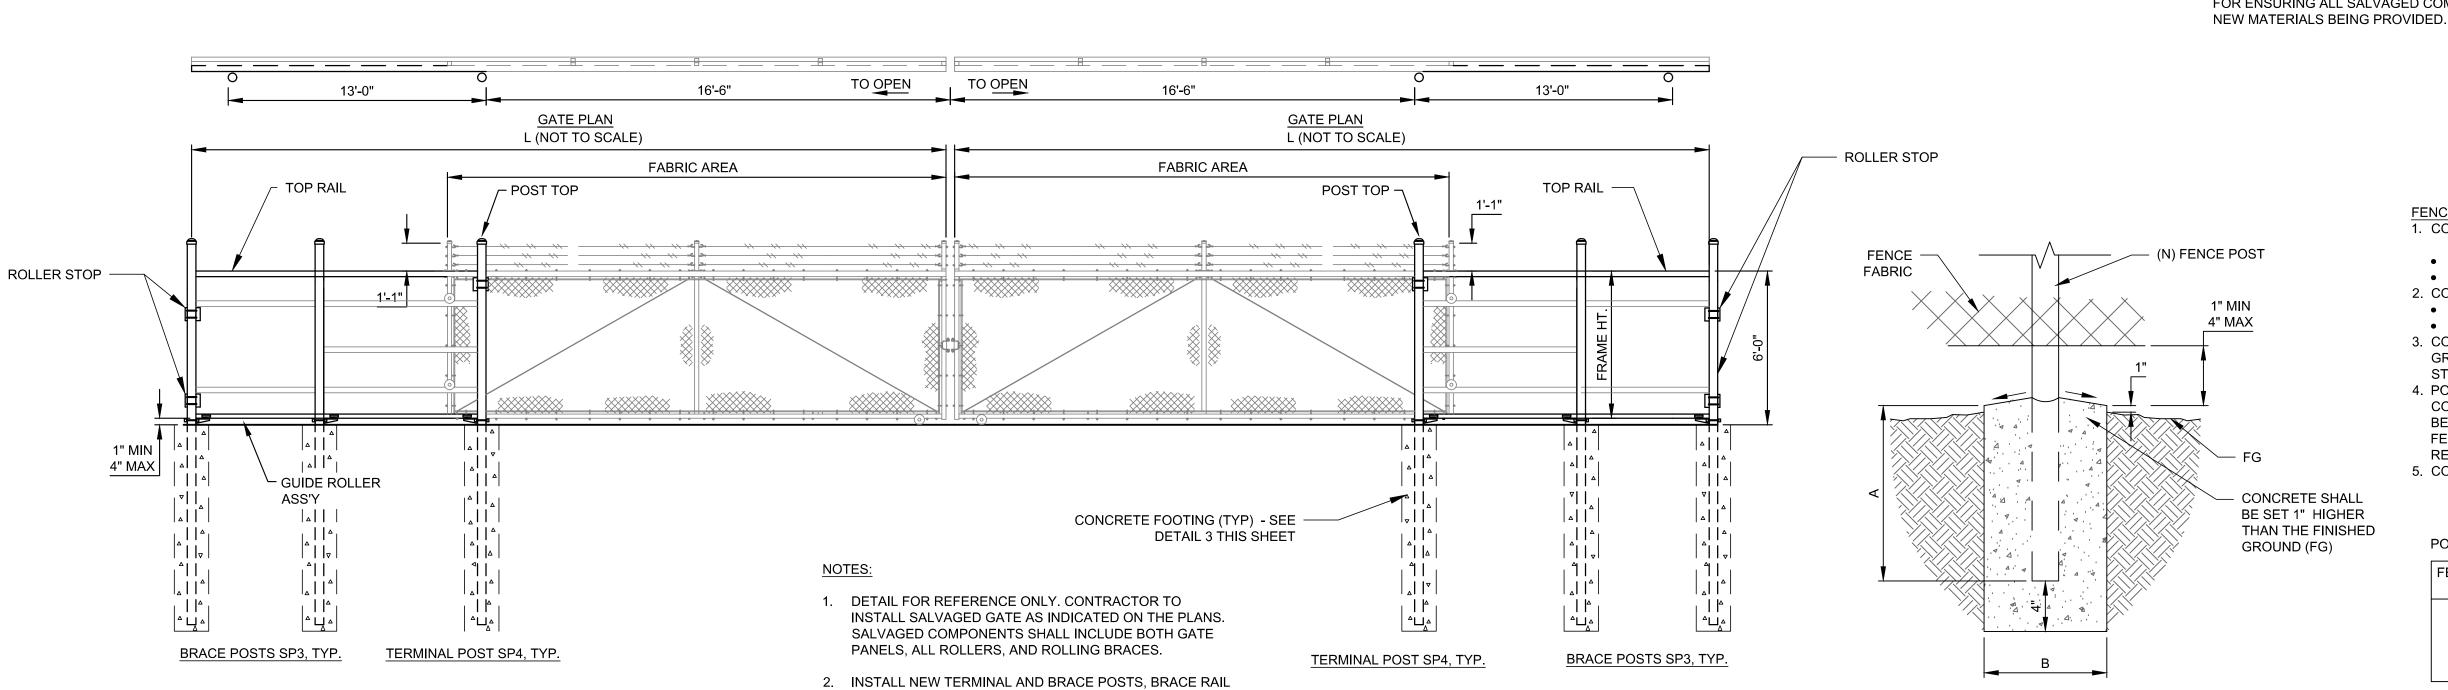
UNDERDRAIN DETAILS

SHEET NO. 23 of 40



X:\1821200\221217.01\TECH\CAD\C-601 FENCING GATE & SIDEWALK PLA

SALVAGEABLE IS CONSIDERED FABRIC WITHOUT HOLES, TEARS, SNAGS, ETC.: EXTENSION ARMS WITHOUT KINKS OR BROKEN BRACKETS; TOP RAIL WITHOUT KINKS; AND GATE PANELS THAT, WHEN HUNG, PROVIDE THE FUNCTIONALITY OF A NEW GATE. THE CONTRACTOR IS RESPONSIBLE FOR ENSURING ALL SALVAGED COMPONENTS ARE COMPATIBLE WITH THE



FENCE FOOTING AND MATERIALS NOTES:

- 1. CONCRETE FOOTING DEPTH (A) 6' - 0" CHAINLINK FENCE
- TERMINAL POSTS & GATE POSTS 3'-6"
- BRACE POSTS 3'-0" 2. CONCRETE FOOTING WIDTH (B)
- TERMINAL POSTS & GATE POSTS 18" BRACE POSTS - 12" 3. CONCRETE SHALL BE OF A COMMERCIAL
- GRADE WITH MINIMUM 28 DAY COMPRESSIVE STRENGTH OF 3,000 PSI.
- 4. POSTS, RAILS AND BRACING SIZES SHALL CONFORM TO THE SIZES LISTED IN THE TABLE BELOW OF FED SPEC RR-F-191/3. ALL OTHER FENCING MATERIALS SHALL CONFORM TO THE RELEVANT FED SPEC FOR THAT MATERIAL.
- 5. CONCRETE TO HAVE A SMOOTH FINISH.

POST SIZES PER FED SPEC RR-F-191/3,

FED SPEC SIZE	OUTSIDE DIAMETER	MIN WALL THICKNESS
SP2	1.900"	0.120"
SP3	2.375"	0.130"
SP4	2.875"	0.160"
SP5	4.000"	0.226"
SP6	6.625	0.280

SALVAGED MANUAL DOUBLE SLIDING GATE

AND TRUSS ROD AT LIMITS OF FENCE REMOVAL.

TYPICAL FENCE POST FOOTING

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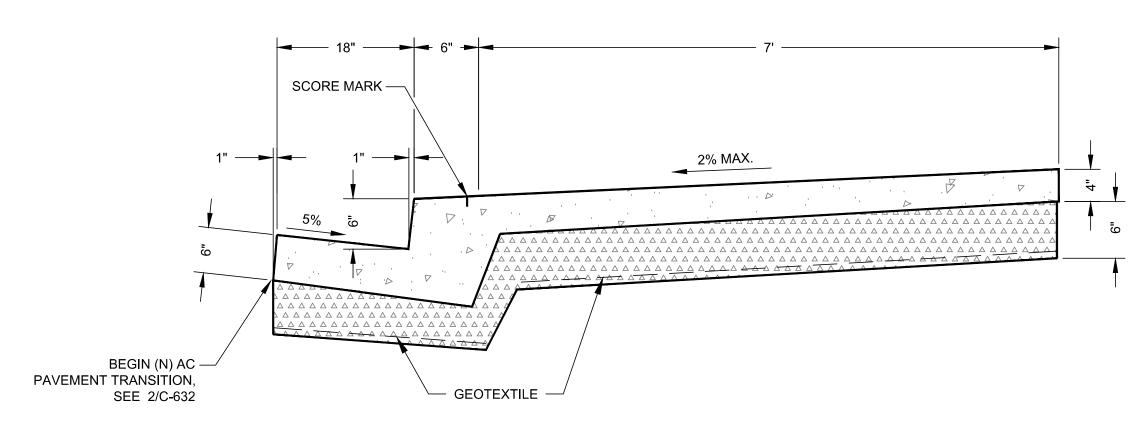


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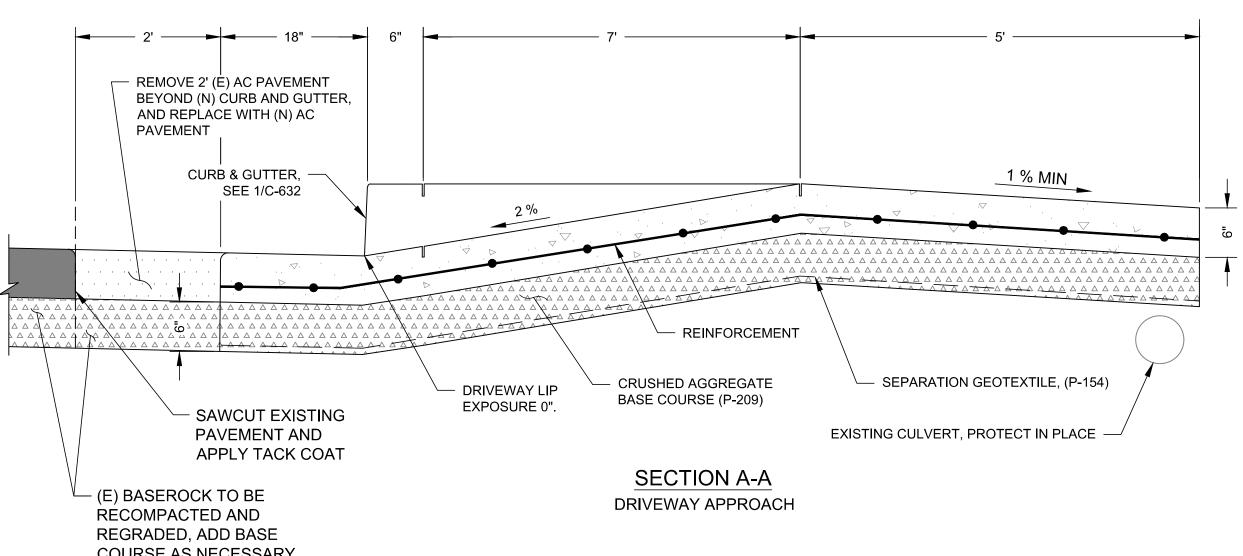
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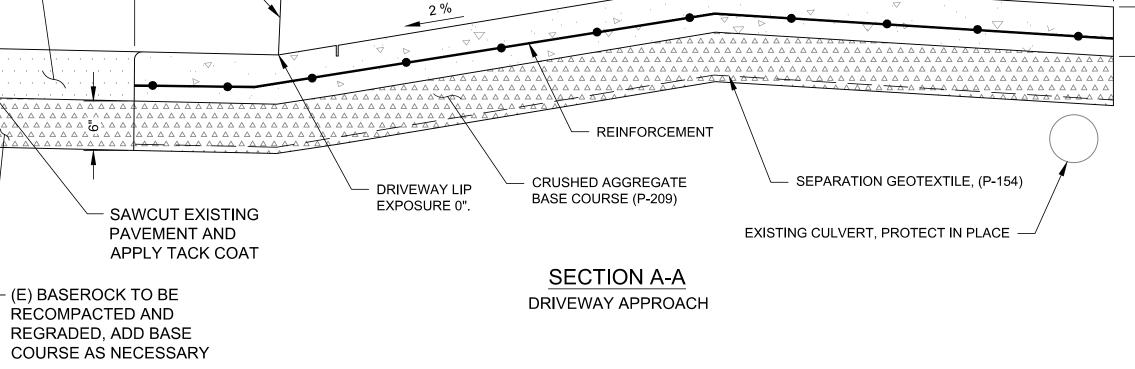
SHEET CONTENTS FENCING & GATE DETAILS

SHEET NO. 25 of 40



SIDEWALK WITH CURB AND GUTTER CROSS SECTION






#### NOTES:

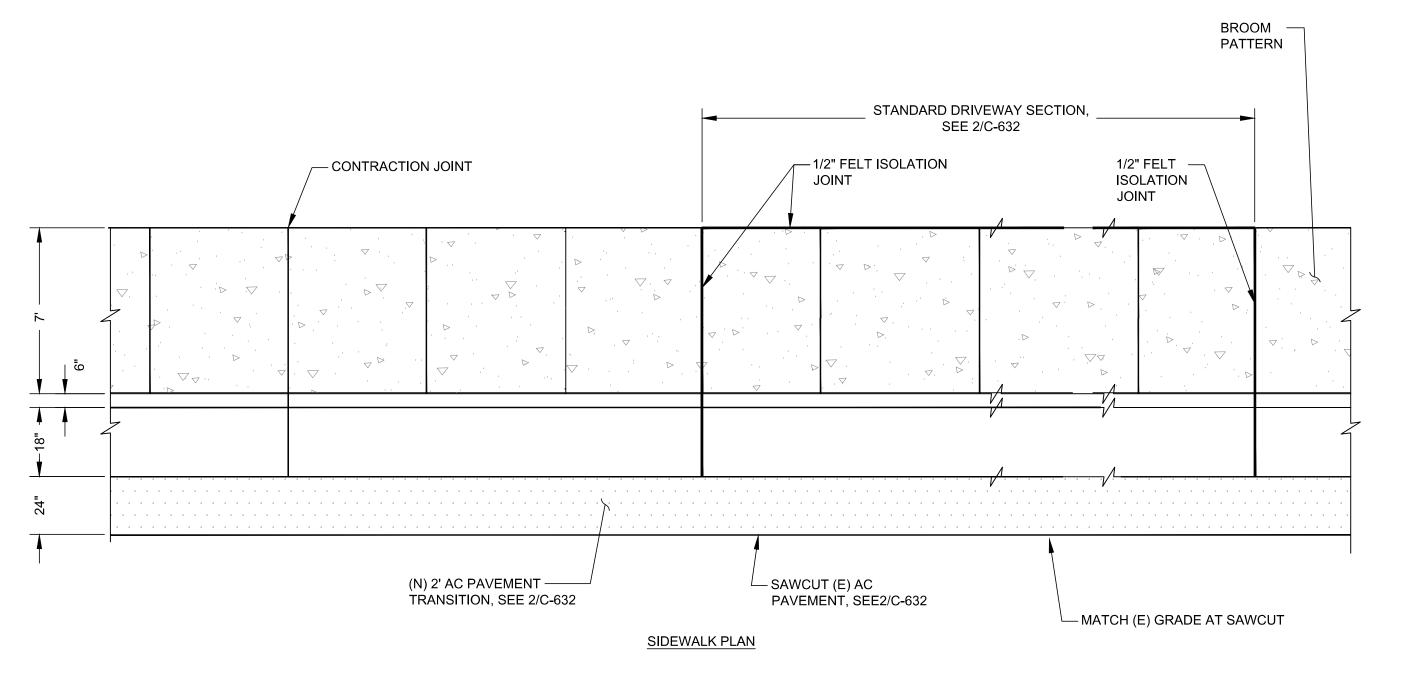- 1. SIDEWALK SECTIONS THROUGH THE DRIVEWAY APPROACH SHALL HAVE A MINIMUM NOMINAL THICKNESS OF 6".
- 2. CONCRETE SHALL MEET THE REQUIREMENTS OF ITEM P-610
- 3. CURB TRANSITIONS FOR DRIVEWAY APPROACHES SHALL BE 7 FEET.
- 4. REINFORCEMENT SHALL BE #4 REBAR. REBAR SHALL BE PLACED 12" O.C. EACH WAY, FOR THE FULL 60 LF DRIVEWAY SECTION.





#### NOTES:

- 1. CONCRETE USED IN SIDEWALKS SHALL MEET THE REQUIREMENTS OF
- 2. ALL RADII SHALL BE 3/4" UNLESS OTHERWISE SHOWN.
- 3. ISOLATION JOINTS (FELT EXPANSION JOINTS) SHALL BE PLACED AT 45' INTERVALS.
- 4. CONTRACTION JOINTS SHALL BE PLACED AT 15' INTERVALS AND SHALL EXTEND THROUGH THE CURB OR CURB AND GUTTER EVERY OTHER ONE.



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**TENSION** GION 3896 NW STE ROSEBURG, SEB

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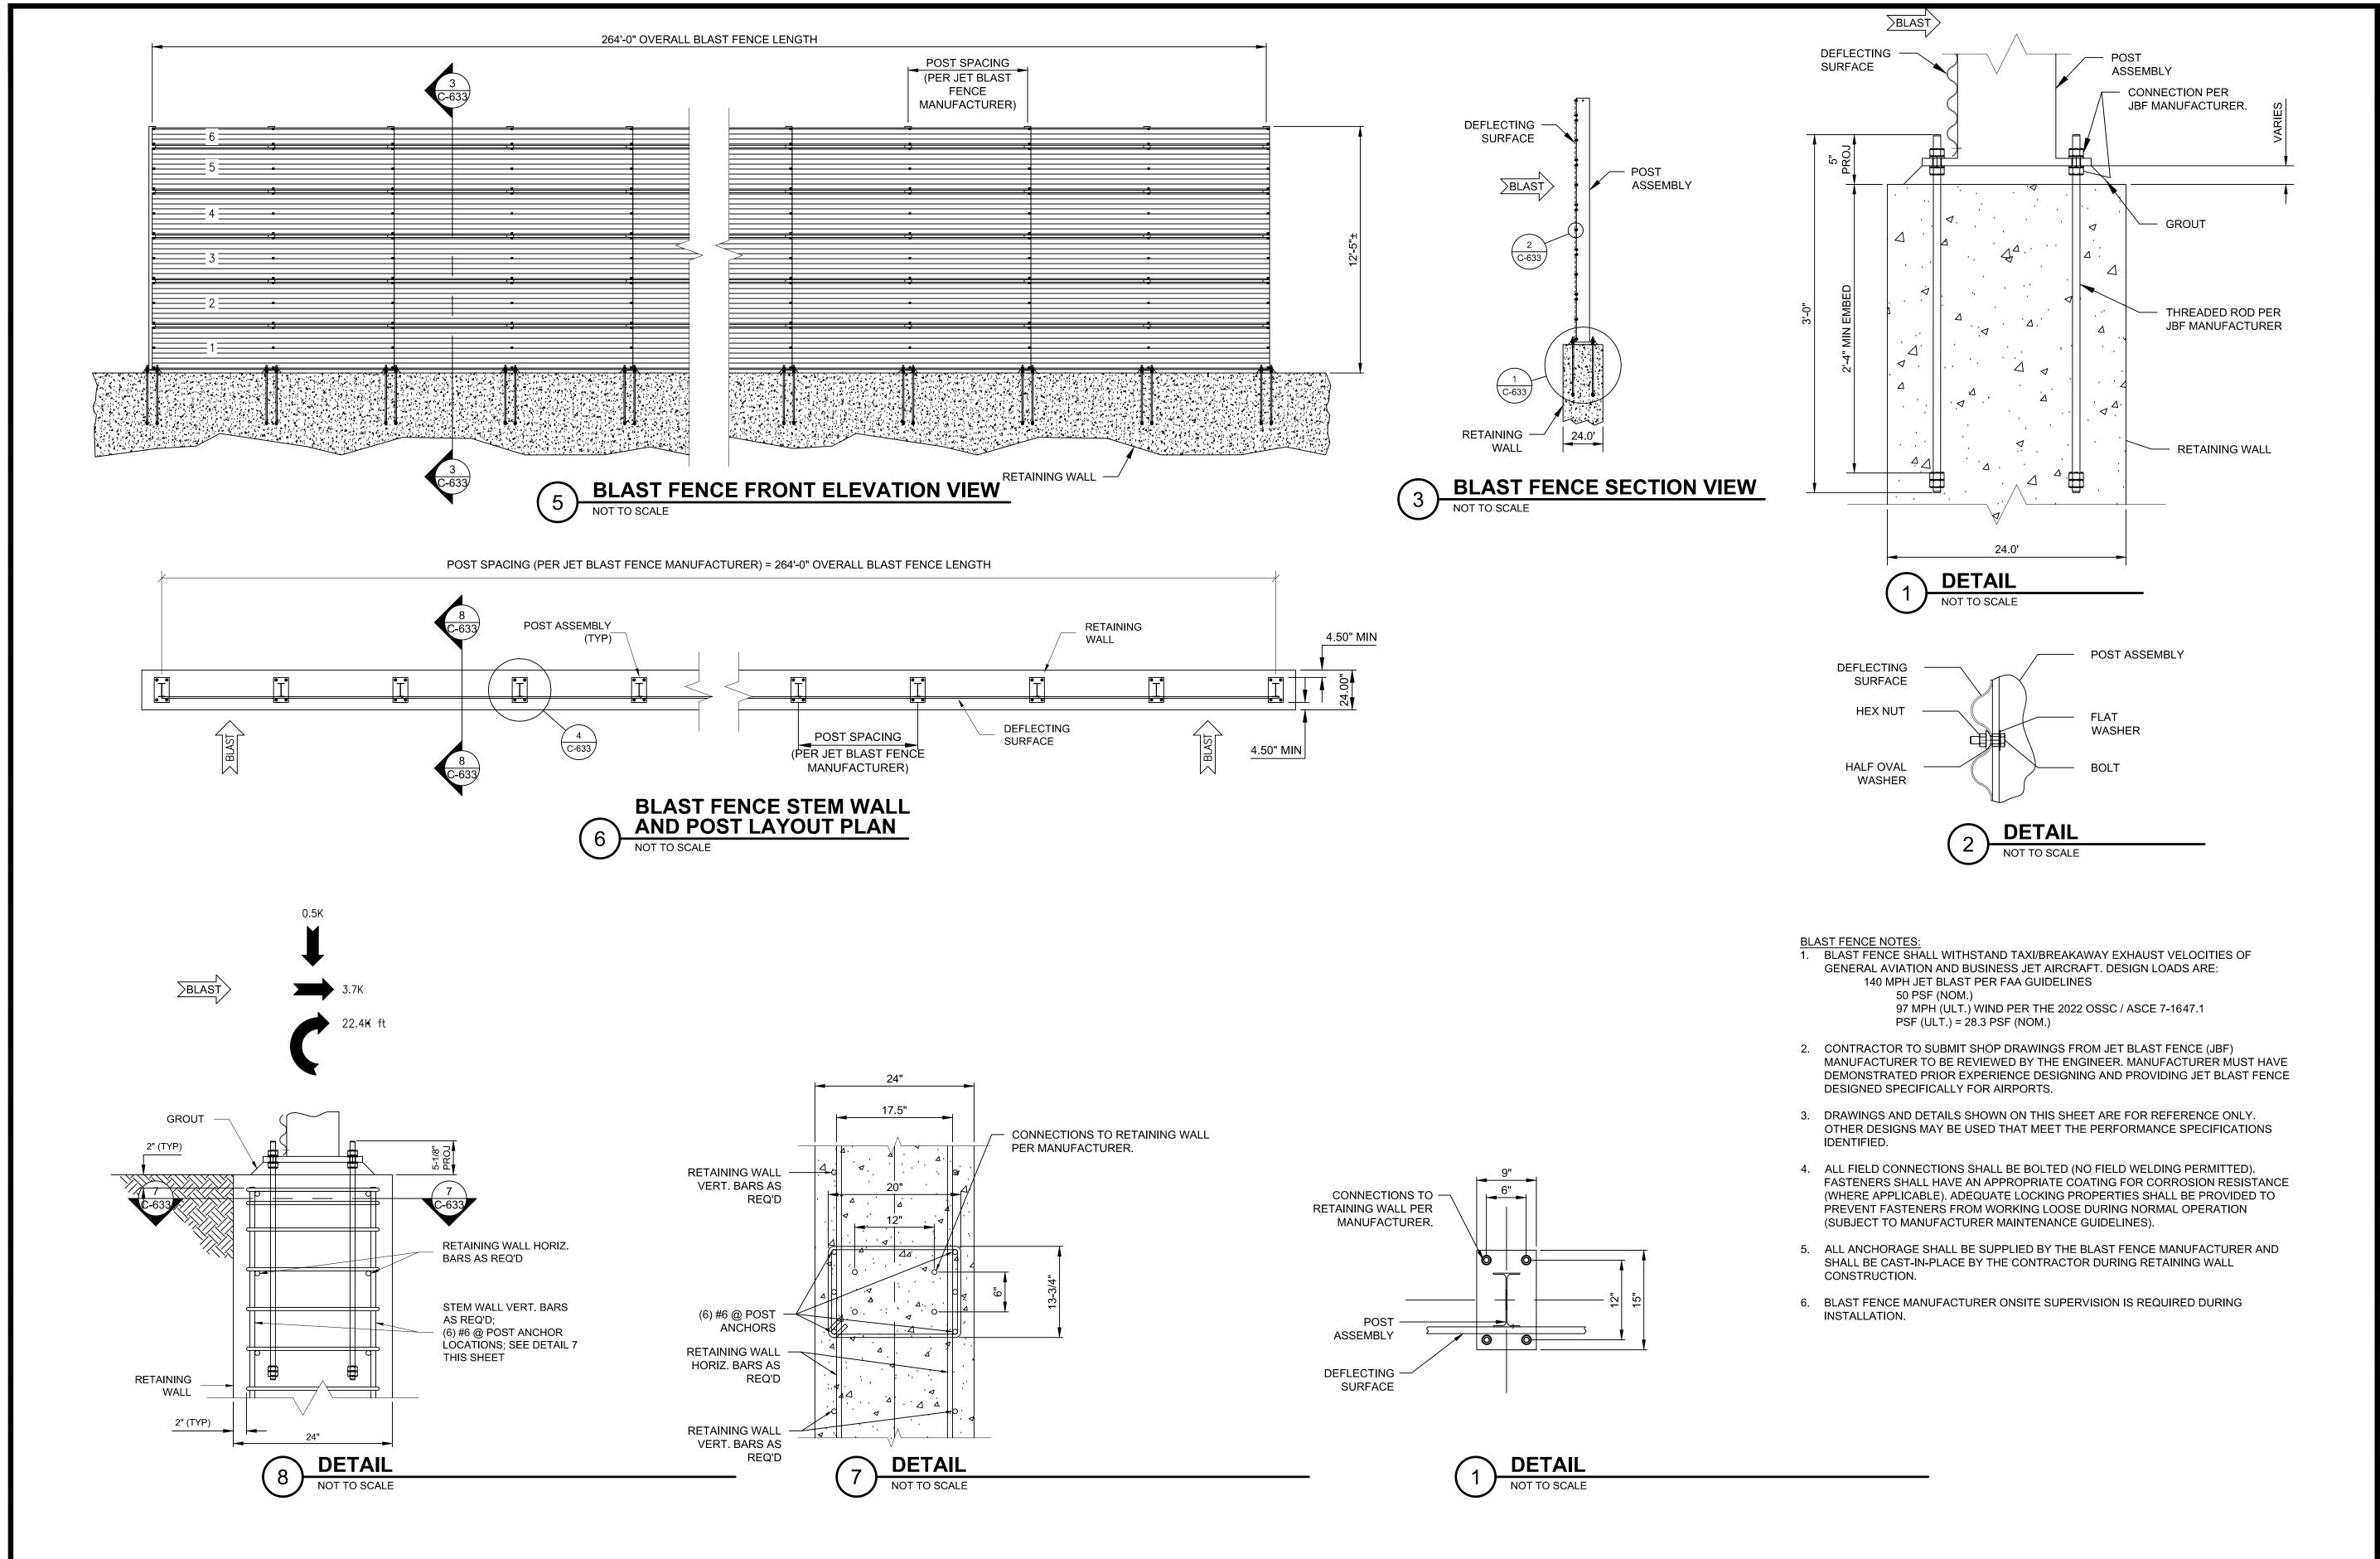


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DO NOT SCALE DRAWINGS SHEET CONTENTS SIDEWALK & CONCRETE ENTRANCE DETAILS

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SHEET NO. 26 of 40



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SHEET CONTENTS


JET BLAST

DEFLECTOR DETAILS


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SHEET NO. **27** of **40** 
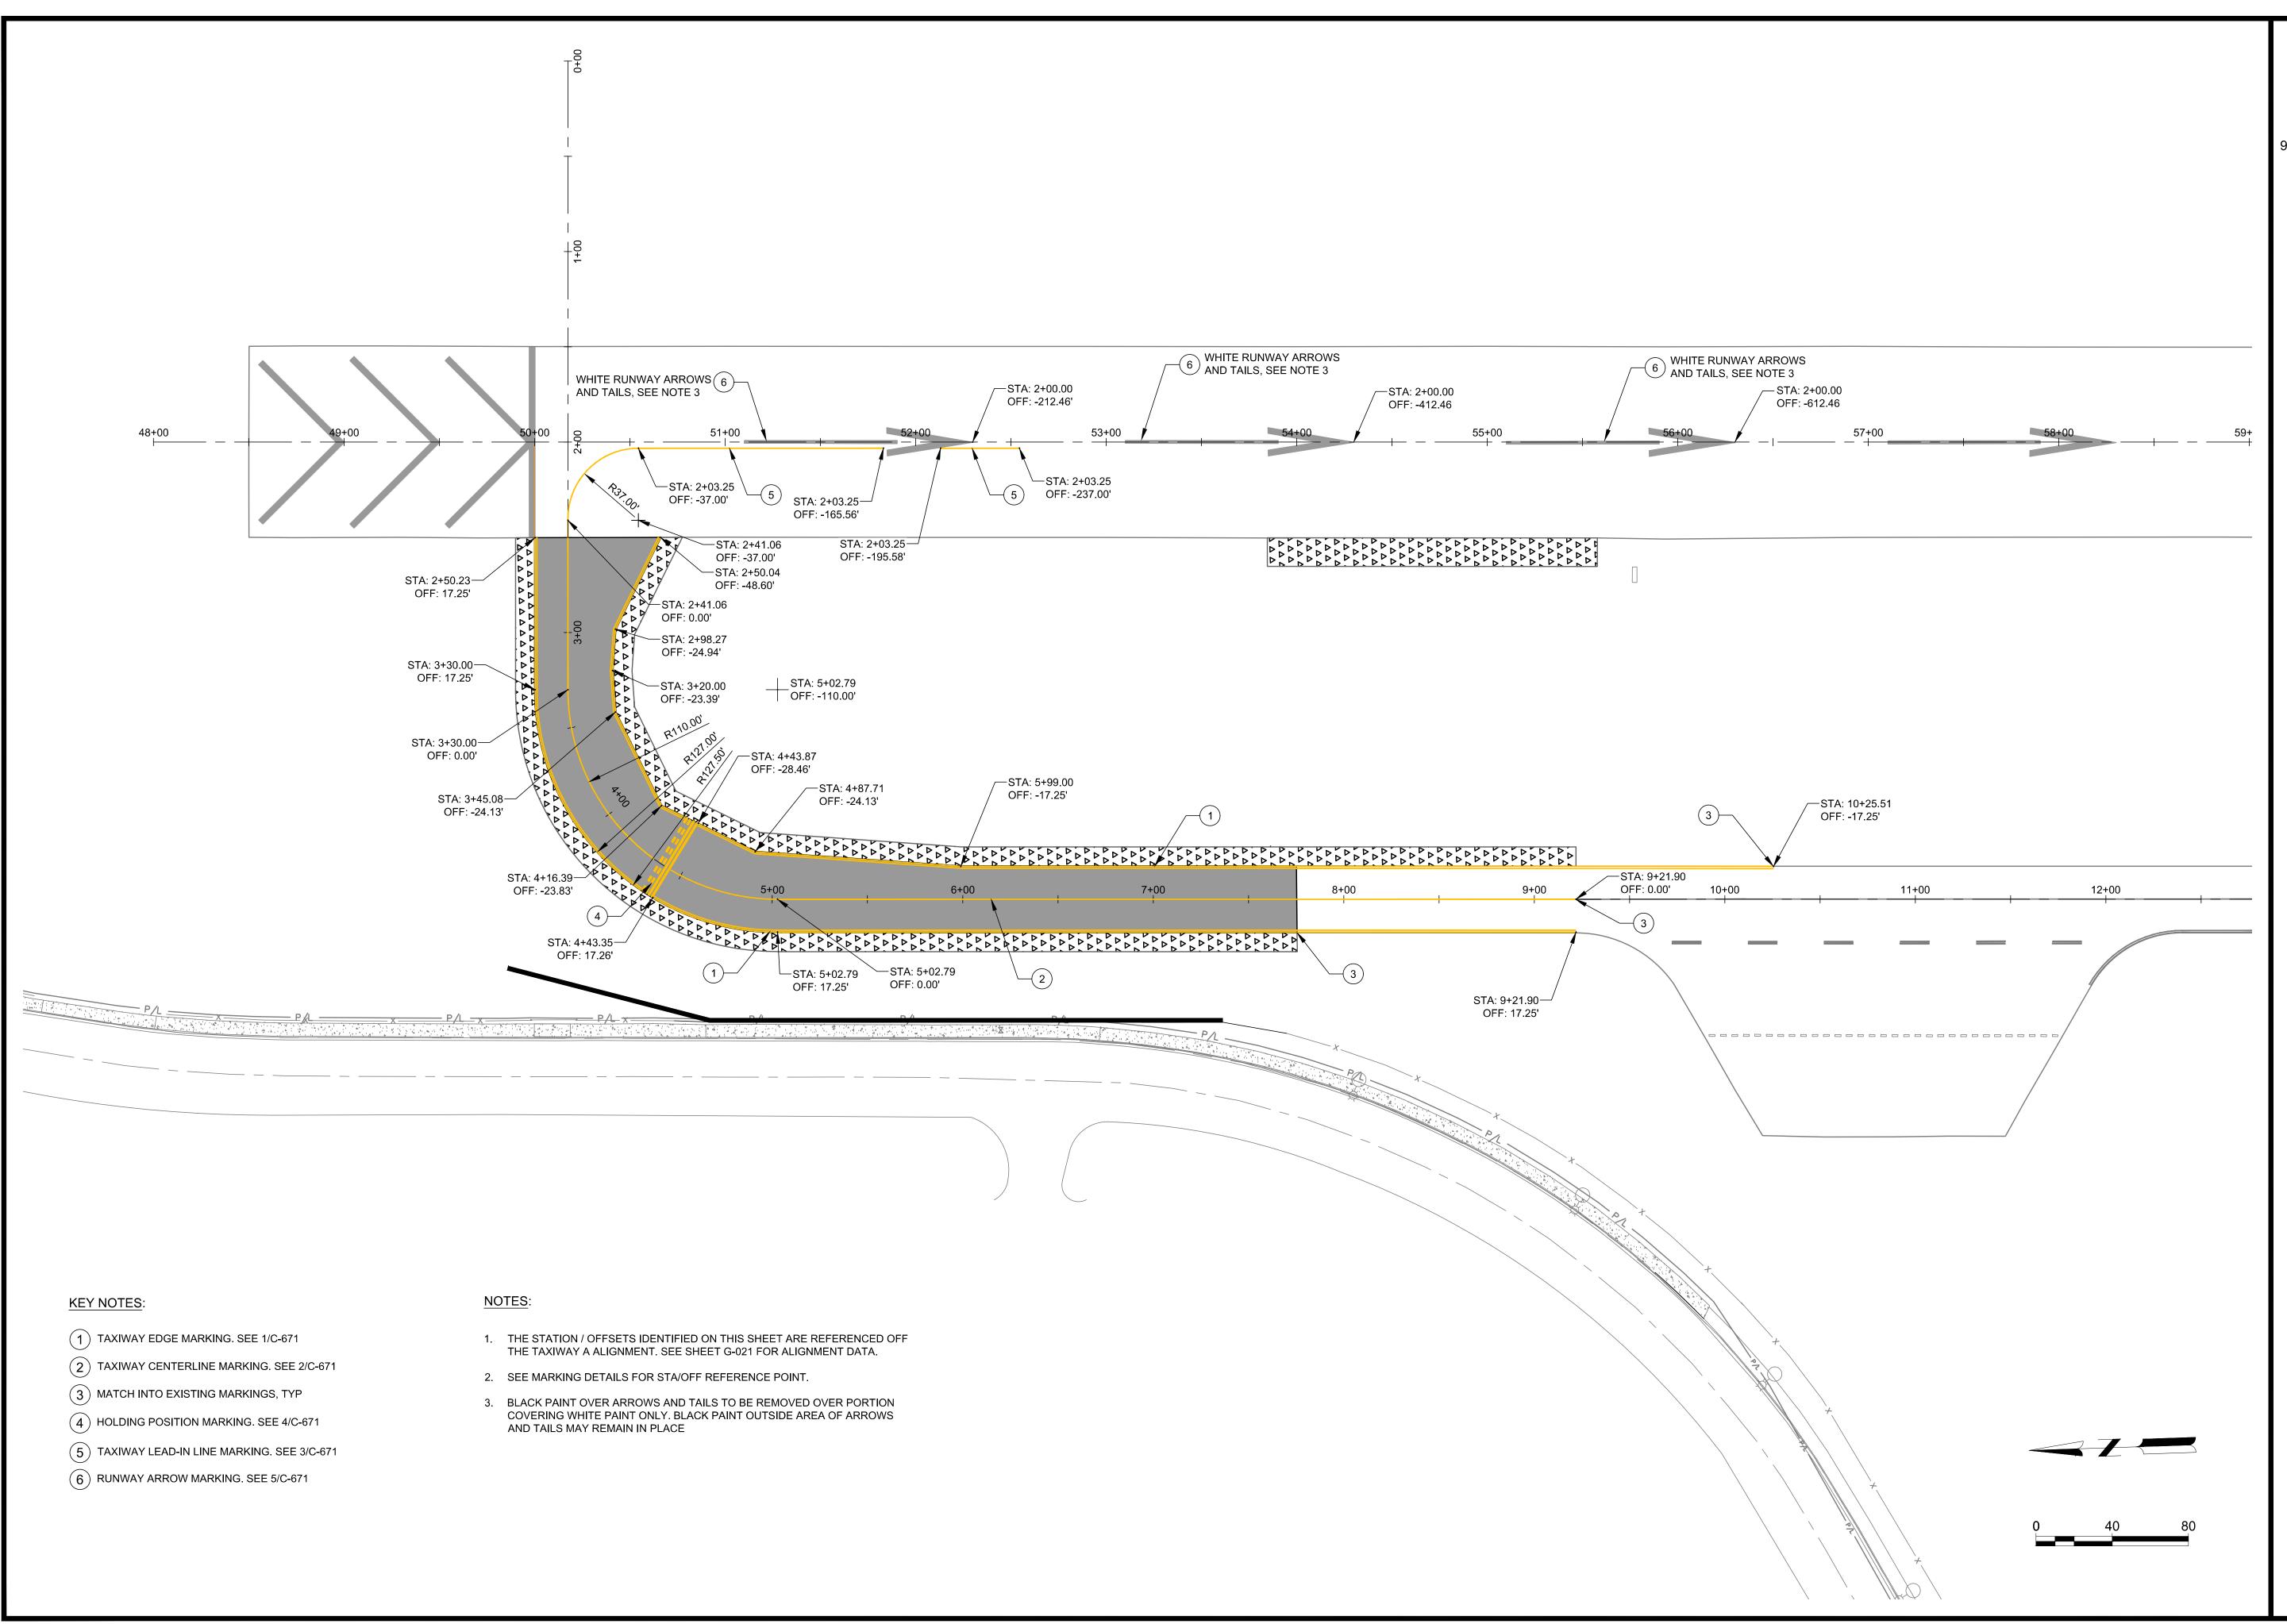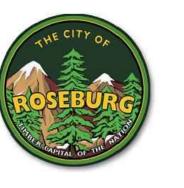
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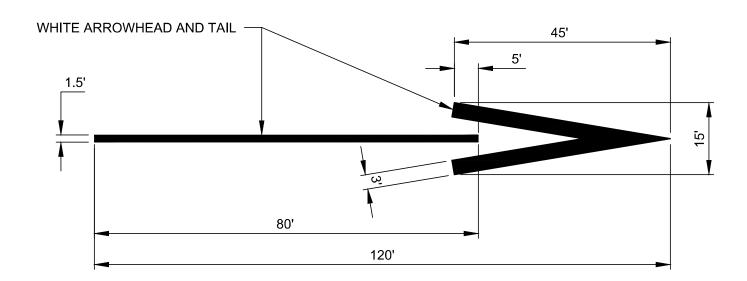
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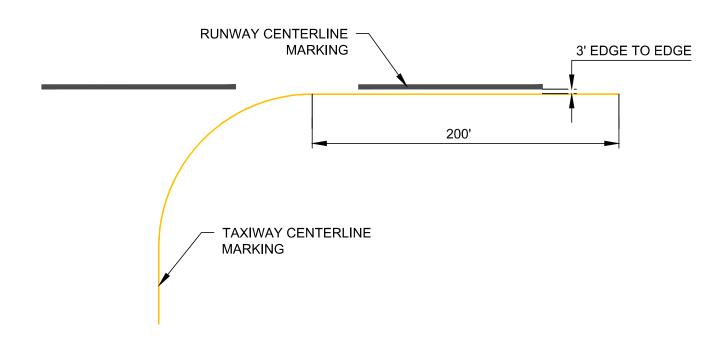
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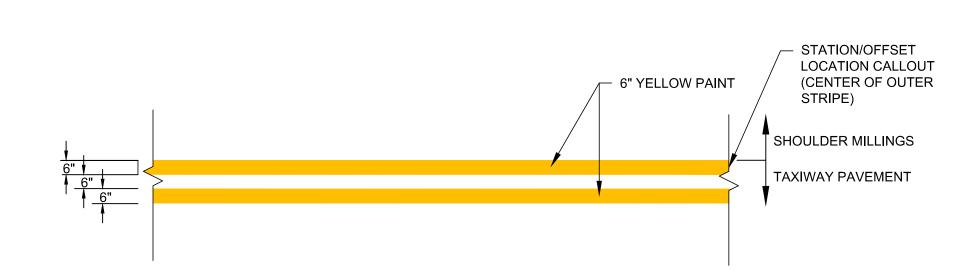
SHEET CONTENTS MARKING PLAN

SHEET NO. 28 of 40

PAINT TYPE	PAINT MAXIMUM APPLICATION RATE (FT <sup>2</sup> /GAL)	GLASS BEAD MINIMUM APPLICATION RATE (LBS/GAL)
YELLOW MARKING	115	7
INITIAL YELLOW MARKING	230	X
BLACK MARKING	115	X
WHITE MARKING	115	7



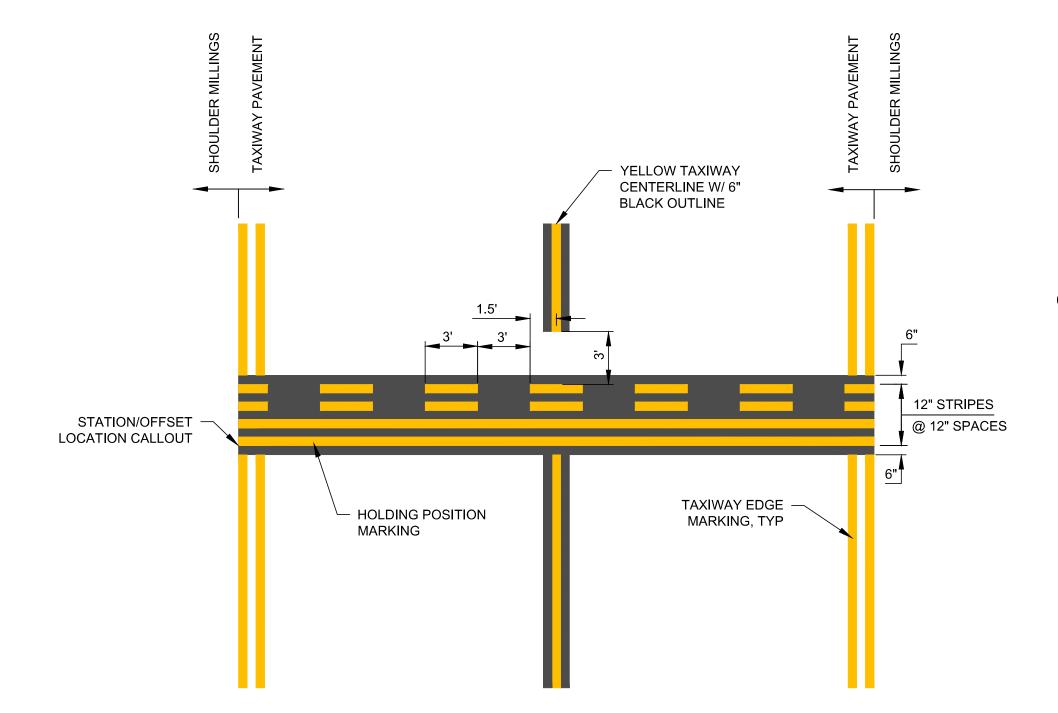




5 ARROW MARKING
NO SCALE

3 TAXIWAY LEAD-IN LINE
NOT TO SCALE







2 TAXIWAY CENTERLINE MARKING
NOT TO SCALE

4 HOLDING POSITION MARKING
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AIRPORT

ROSEBURG REGIONAL AI
TAXIWAY A EXTENSION
3896 NW STEWART PARKWAY
ROSEBURG, OR 97470

ISSUED FOR BID

BERGS 12/31/25

AIP NO.: 3-41-0054-030-2024 M&H NO.: 1821200-221217.01 DATE: APRIL 18, 2024 DESIGNED BY: MLF

DATE: APRIL 18, 202DESIGNED BY: MLF
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SHEET CONTENTS

MARKING DETAILS

SHEET NO. 29 of 40

C-671

RESULTS MUST ALSO BE SUBMITTED TO THE ENGINEER. SEE PROJECT SPECIFICATIONS FOR ADDITIONAL INFORMATION.

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NW STI EBURG,




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SHEET CONTENTS **ELECTRICAL** REMOVAL PLAN

SHEET NO. 30 of 40



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TAXIWAY 3896 NW STE ROSEBURG,
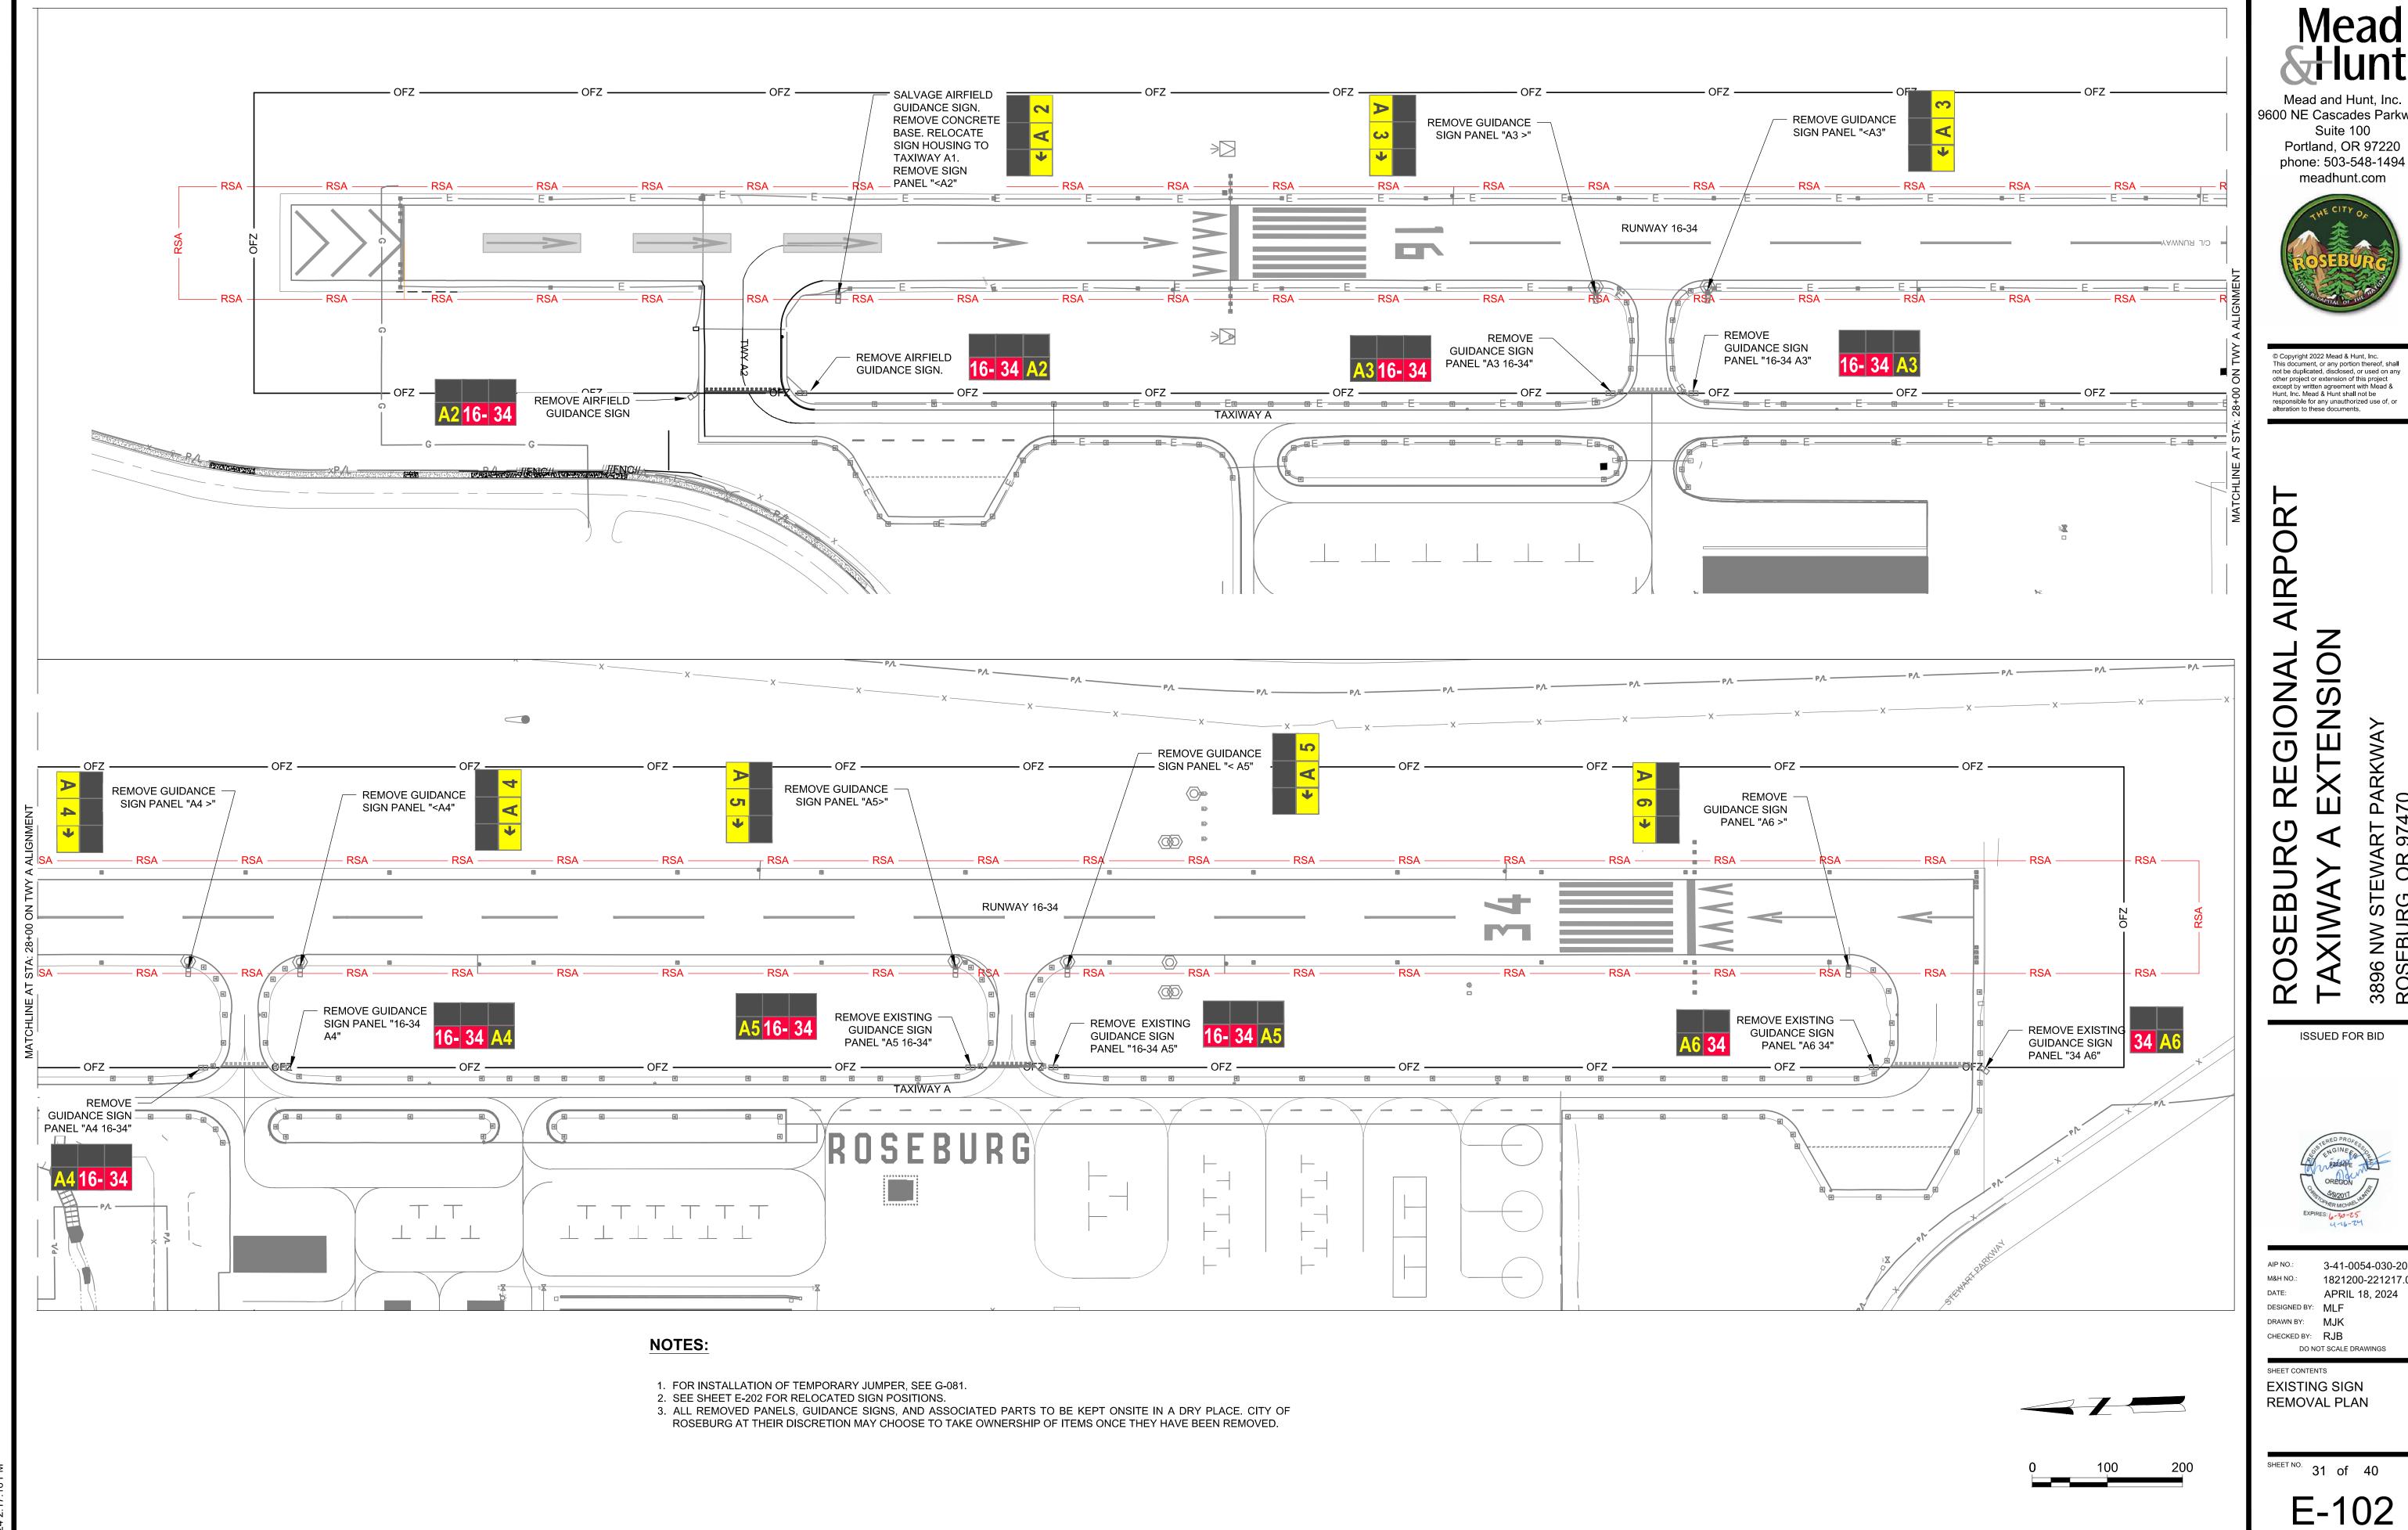
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SHEET CONTENTS **EXISTING SIGN** REMOVAL PLAN

SHEET NO. 31 of 40

	CIRCUIT CHART							
LABEL	NUMBER AND TYPE OF CABLE	CIRCUIT						
1	1 - 1/C, #8 5KV, L-824, TYPE C	TWY A						
2	2 - 1/C, #8 5KV, L-824, TYPE C	TWY A						
3	1 - 1/C, #8 5KV, L-824, TYPE C	RWY 16-34						
4	2 - 1/C, #8 5KV, L-824, TYPE C	RWY 16-34						
5	#6 COUNTERPOISE							
	NUMBER AND TYPE OF COND	UIT						
Α	1W-2" PVC CONDUIT							
В	1W-2" PVC CONDUIT, CONCRETE ENCAS	SED						
С	EXISTING CONDUIT							

#### LEGEND:

MEDIUM INTENSITY TAXIWAY EDGE LIGHT

MEDIUM INTENSITY RUNWAY EDGE LIGHT

E ELECTRICAL JUNCTION BOX

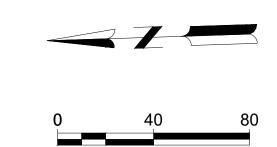
NEW ELECTRICAL CABLE AND CONDUIT

AIRFIELD GUIDANCE SIGN

## NOTES:

- 1. THE STATION / OFFSETS IDENTIFIED ON THIS SHEET ARE REFERENCED OFF THE TAXIWAY A ALIGNMENT.
- 2. THE STATION / OFFSETS IDENTIFIED FOR GUIDANCE SIGNS REFER TO THE CENTER OF THE EDGE NEAREST TO THE TAXIWAY PAVEMENT EDGE.
- 3. SEE PHASING PLAN FOR TEMPORARY JUMPER CABLE LOCATION. DETAIL 4 ON E-602.
- 4. CONTRACTOR SHALL PERMANENTLY LABEL EACH CIRCUIT INSIDE ELECTRICAL BASE CANS AND HANDHOLES.
- 5. ALL OFFSET DISTANCES FOR SIGNS ARE MEASURED TO THE EDGE OF SIGN NEAREST TO THE RUNWAY OR TAXIWAY EDGE
- 6. THE CONTRACTOR WILL BE REQUIRED TO PROMPTLY REPAIR CONSTRUCTION DAMAGED PAVEMENT ADJACENT TO PROJECT LIMITS.
- 7. THE CONTRACTOR WILL BE REQUIRED TO MEGGER TEST ALL EXISTING CIRCUITS BEFORE AND AFTER CONSTRUCTION TO ENSURE PROPER INSULATION AFTER INSTALLATION. MEGGER TESTS MUST BE WITNESSED BY ENGINEER, AND WRITTEN TEST RESULTS MUST BE ALSO SUBMITTED TO ENGINEER.
- 8. ANY LIGHTING EQUIPMENT, CIRCUITS, COUNTERPOISE, OR AIRPORT FACILITY DAMAGED AS A RESULT OF THIS PROJECT SHALL BE REPAIRED OR REPLACED AT THE CONTRACTOR'S EXPENSE AND TO THE SATISFACTION OF THE ENGINEER.
- 9. ALL ITEMS REMOVED AS PART OF THIS PROJECT SHALL BECOME THE PROPERTY OF THE CONTRACTOR AND REMOVED OFF OF AIRPORT PROPERTY UNLESS OTHERWISE NOTED.

- 10. THE EXISTING ELECTRICAL CABLE, DUCTS, SIGNS, LIGHTS, HANDHOLES, AND THE OTHER ELECTRICAL COMPONENTS ARE SHOWN BASED ON AS-BUILT DRAWINGS AND OTHER REFERENCES. THE LOCATIONS ARE ONLY APPROXIMATE. THE CONTRACTOR IS RESPONSIBLE TO LOCATE THE EXACT LOCATIONS PRIOR TO CONSTRUCTION AND AVOID EXISTING CABLES AND UTILITIES DURING CONSTRUCTION. THE CONTRACTOR MUST COORDINATE THEIR ACTIVITIES WITH THE FAA, AIRPORT AND/OR RESPECTIVE UTILITY COMPANY TO ENSURE THAT SERVICE IS NOT INTERRUPTED.
- 11. CONTRACTOR SHALL NOTIFY THE ENGINEER IMMEDIATELY IF THEY BELIEVE THERE IS A CONTRACTIBILITY CONFLICT BETWEEN SIGN AND LIGHT BASES. CONFLICTS SHALL BE RESOLVED ON A CASE-BY-CASE BASIS.
- 12. COUNTERPOISE TO BE INSTALLED PER DETAIL ON SHEET E-601. GROUND RODS SHOWN FOR REFERENCE AND SHALL BE INSTALLED AT LOCATIONS STATED IN FAA ITEM L-108 SPECIFICATION.



Meac

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DATE: APRIL 2024
DESIGNED BY: MLF
DRAWN BY: MJK

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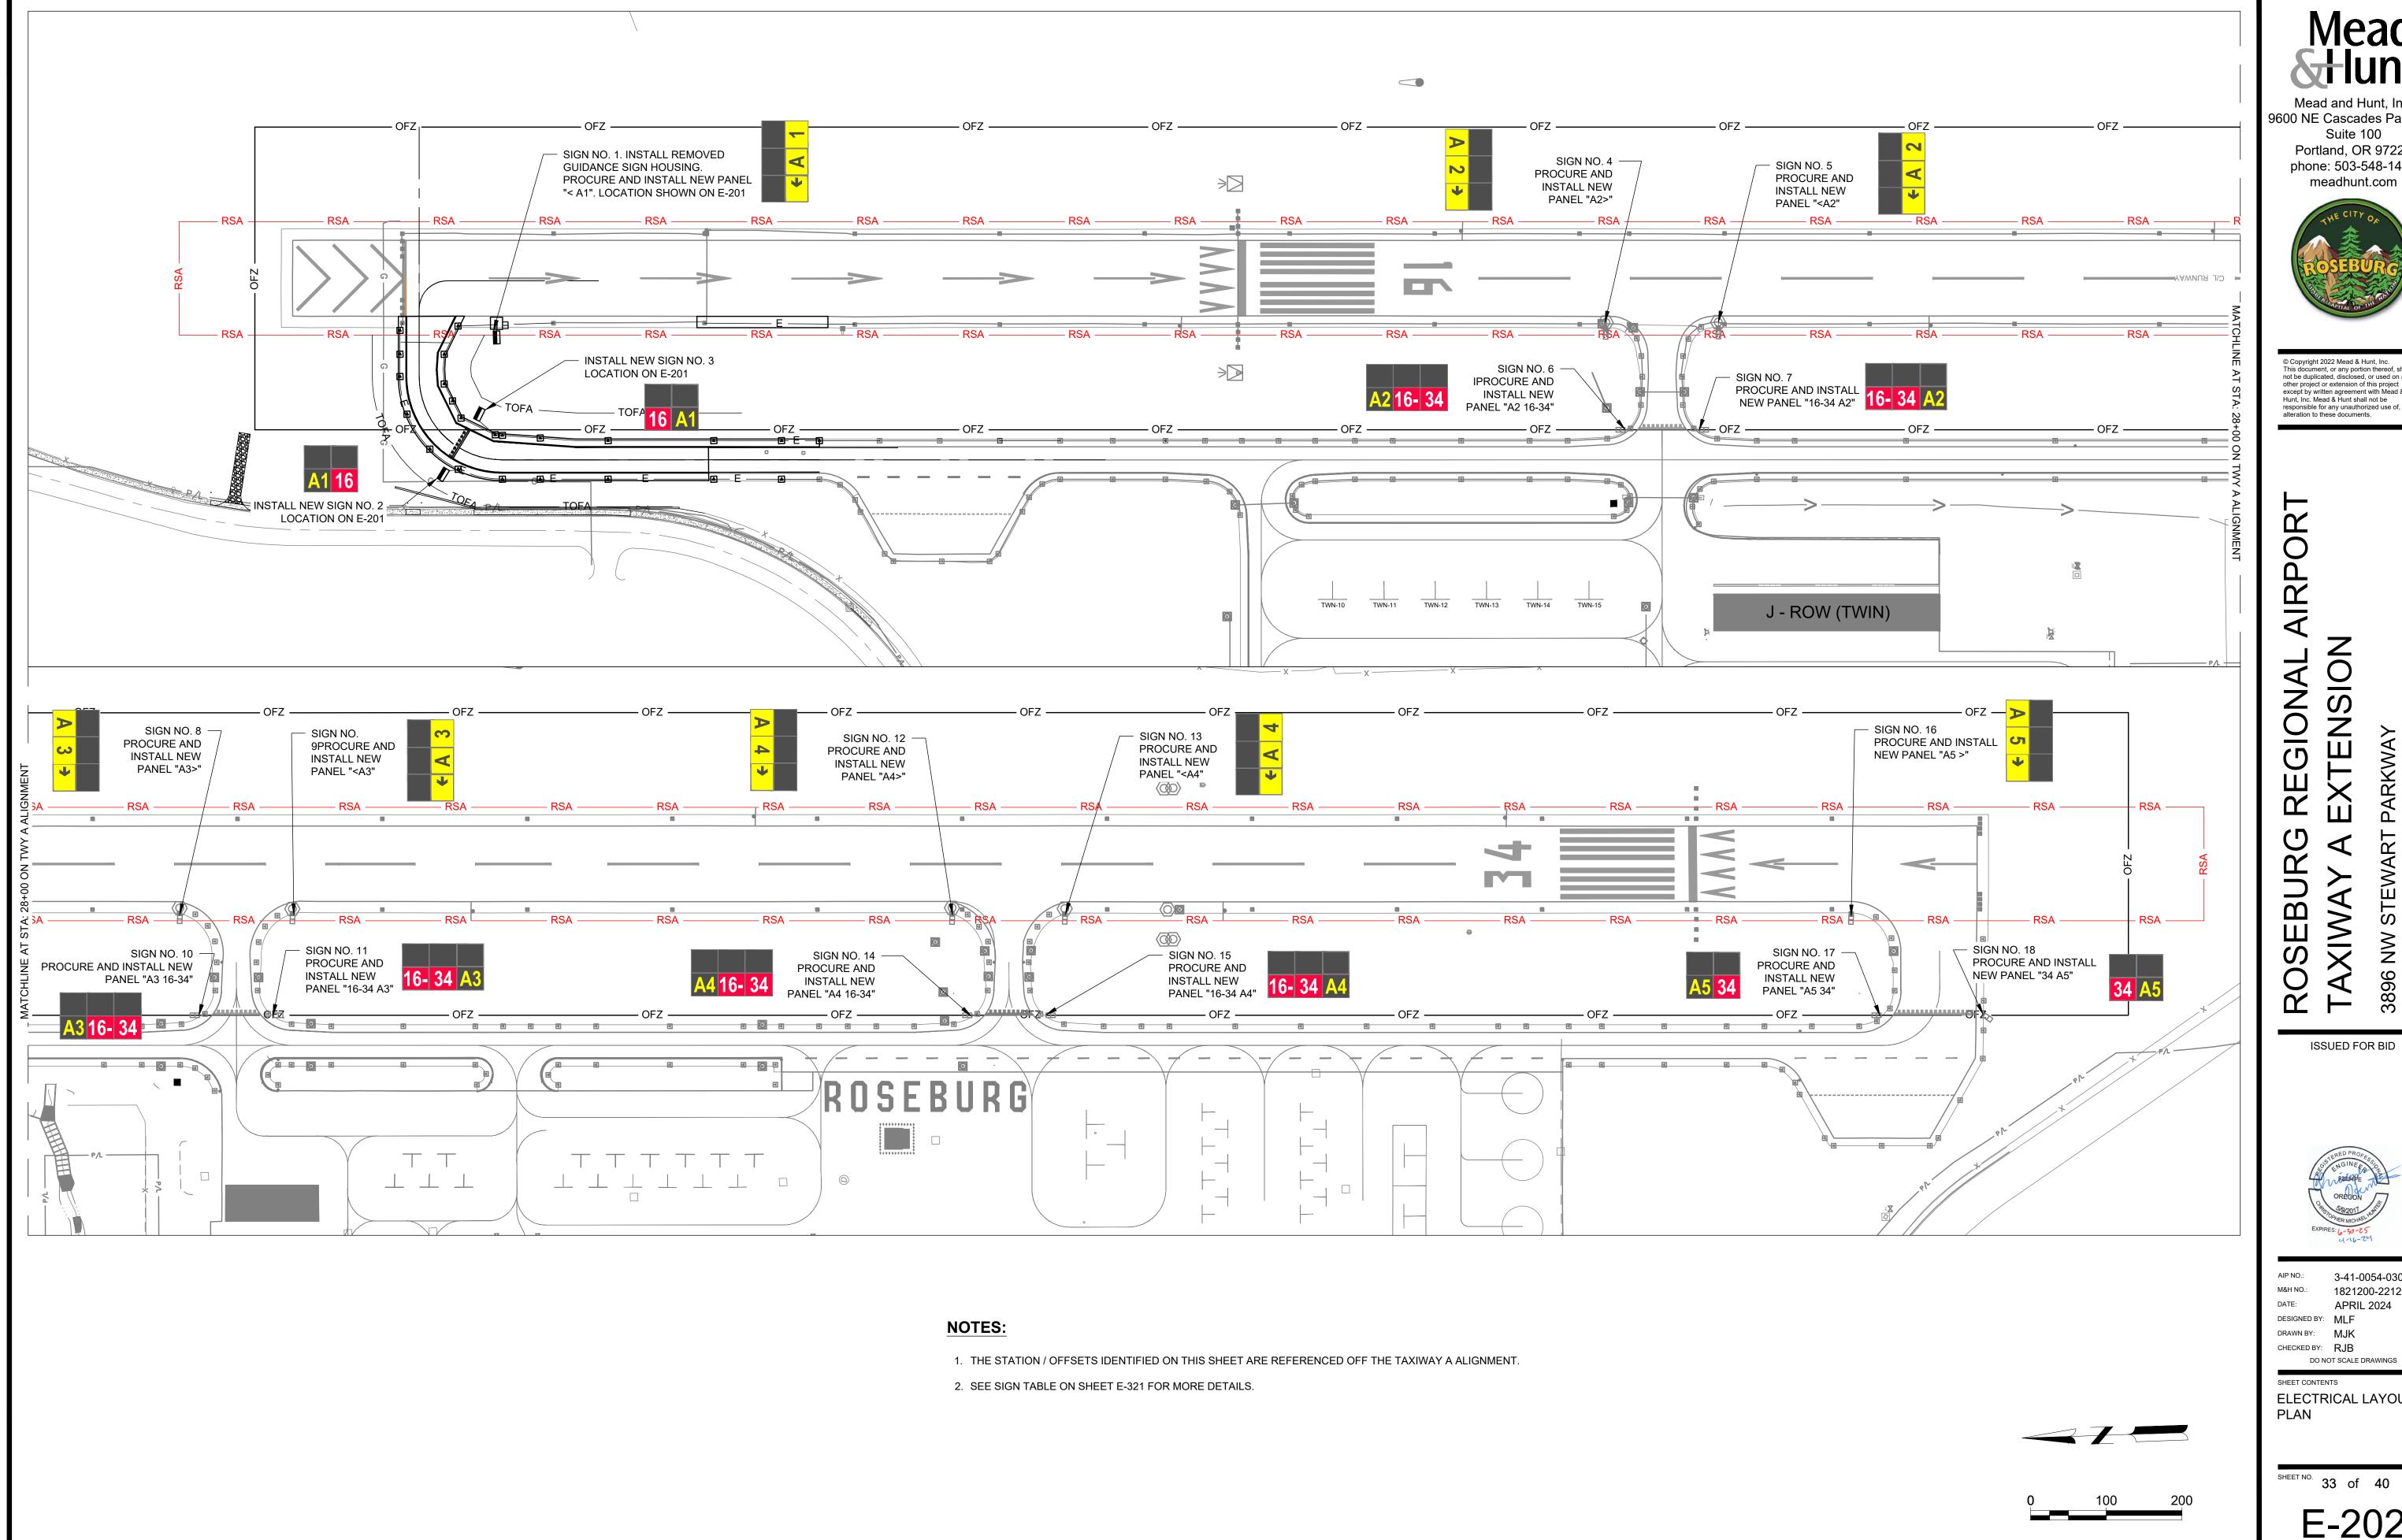
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SHEET CONTENTS

ELECTRICAL LAYOUT
PLAN

SHEET NO. 32 of 40



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SHEET CONTENTS ELECTRICAL LAYOUT

33 of 40

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ELECTRICAL DETAILS

SHEET NO. 34 of 40

E-321


**GUIDANCE SIGN SCHEDULE** SIDE A (PRIMARY SIDE) **SPECIFICATIONS** SIDE B REMARKS SIGN LOCATION NUMBER LEGEND 1 COLOR LEGEND 2 COLOR LEGEND 3 COLOR LEGEND 4 COLOR LEGEND 1 COLOR LEGEND 2 COLOR LEGEND 3 COLOR LEGEND 4 COLOR FAA TYPE SIZE | STYLE | CLASS | **RUNWAY 16-34** B/Y A1 BLANK BLANK L-858 INSTALL SALVAGED SIGN HOUSING ON NEW BASE. NEW PANEL SIDE A TAXIWAY A1 A1 Y/B16 W/RBLANK В BLANK В L-858 2 2 NEW SIGN ON NEW BASE TAXIWAY A BLANK Y/B2 **NEW SIGN ON NEW BASE** 3 В BLANK В 16 W/RA1 L-858 2 **RUNWAY 16-34** 4 BLANK BLANK В A2 B/Y B/Y L-858 2 2 NEW PANEL SIDE B В 5 **RUNWAY 16-34** B/Y B/Y 2 2 NEW PANEL SIDE A A2 BLANK В BLANK В L-858 -2 | 2 6 TAXIWAY A2 A2 Y/B16-W/R34 W/RBLANK В BLANK В BLANK L-858 NEW PANEL SIDE A 7 TAXIWAY A2 BLANK В BLANK В BLANK L-858 2 | 2 NEW PANEL SIDE B 16-W/RW/R Y/B34 A2 8 **RUNWAY 16-34** BLANK BLANK В B/Y B/Y L-858 2 2 NEW PANEL SIDE B В A3 \_ **RUNWAY 16-34** NEW PANEL SIDE A B/Y B/YBLANK В BLANK В L-858 2 | 2 9 Α3 10 TAXIWAY A3 W/RW/R BLANK В BLANK В BLANK В L-858 2 | 2 NEW PANEL SIDE A A3 Y/B | 16-34 BLANK 16-W/RW/RА3 Y/B2 | 2 NEW PANEL SIDE B 11 TAXIWAY A3 BLANK В BLANK В В 34 L-858 12 **RUNWAY 16-34** BLANK В BLANK В A4 B/YB/Y L-858 2 2 NEW PANEL SIDE B **RUNWAY 16-34** BLANK BLANK 13 B/Y B / Y Α4 2 | 2 L-858 NEW PANEL SIDE A 14 **TAXIWAY A4** BLANK A4 Y / B 16-W/R34 W/R BLANK В В BLANK 2 2 NEW PANEL SIDE A L-858 1 Y/B15 TAXIWAY A4 BLANK В BLANK В BLANK 16-W/R34 W/R 2 2 NEW PANEL SIDE B L-858 16 **RUNWAY 16-34** BLANK В BLANK В A5 B/Y B/Y L-858 2 NEW PANEL SIDE B TAXIWAY A5 NEW PANEL SIDE A 17 Α5 Y / B 34 W/RBLANK В BLANK В L-858 18 **TAXIWAY A5** BLANK В BLANK В L-858 2 | 2 NEW PANEL SIDE B 34 W/R A5 Y / B


#### **KEY TO SIGN SCHEDULE**

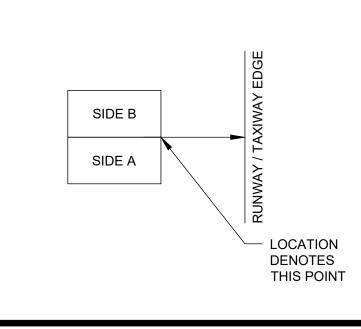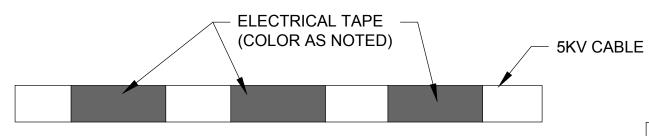- =BLACK LEGEND ON YELLOW BACKGROUND
- W<sub>B</sub> =WHITE LEGEND ON BLACK BACKGROUND
- Y<sub>B</sub> =YELLOW LEGEND ON BLACK BACKGROUND
- B/B =BLANK BLACK BACKGROUND, NO LETTERING
- W/R =WHITE LEGEND ON RED BACKGROUND

#### **SIGN LEGEND NOTES:**

- 1. THE SIGN SCHEDULE PROVIDES THE DESCRIPTIONS AND LEGENDS FOR THE ENTIRE SIGN REGARDLESS IF A SIGN IS EXISTING AND TO BE MODIFIED, RELOCATED, OR ALL NEW. REFER TO THE PLAN DRAWINGS AND THIS TABLE TO DETERMINE THE DISPOSITION FOR EACH SIGN.
- 2. "PRIMARY SIDE" (SIDE A) MEANS THE POWER LEG SIDE OF THE SIGN IS ON THE RIGHT AS YOU APPROACH THE SIGN ALONG A RUNWAY OR TAXIWAY CENTERLINE, AND THE SIGN IS ON THE LEFT. "SECONDARY SIDE" (SIDE B) IS THE OPPOSITE SIDE.
- 3. STATION AND OFFSETS LISTED IN THE SIGN LEGEND REFERENCE THE TAXIWAY A ALIGNMENT.






CIRCUIT NAME COLOR
RWY WHITE
TWY BLUE

NOTE: APPLY ELECTRICAL TAPE
MARKINGS ON EITHER SIDE OF A SPLICE
WITHIN A JUNCTION STRUCTURE AND AT A
MINIMUM OF 2 LOCATIONS WITHIN A
JUNCTION STRUCTURE (JUNCTION CAN
AND PULLBOXES).

# 2 CABLE CIRCUIT IDENTIFICATION MARKINGS NO SCALE

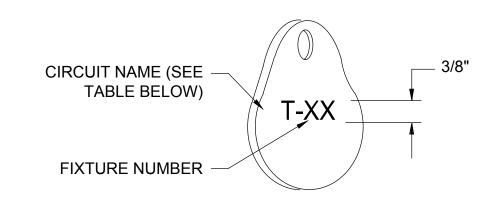


#### NOTES

- 1. SECURELY AFFIX NON-CORROSIVE NUMBERING TAG TO FIXTURE FACING RUNWAY/TAXIWAY WITH SET SCREW, WIRE TIE, OR METAL BAND, NUMBERS SHALL BE ENGRAVED FOR PERMANENT READABILITY. "T-" FOR TAXIWAY. "XX" REFERS TO LIGHT NUMBER. SEE TAXIWAY EDGE LIGHT LOCATION TABLE.
- CONTRACTOR SHALL VERIFY TAGS DO NOT MOVE EITHER TO BE UNREADABLE OR TO BE FATIGUED BY MOVING IN THE WIND.




#### **GENERAL NOTES**

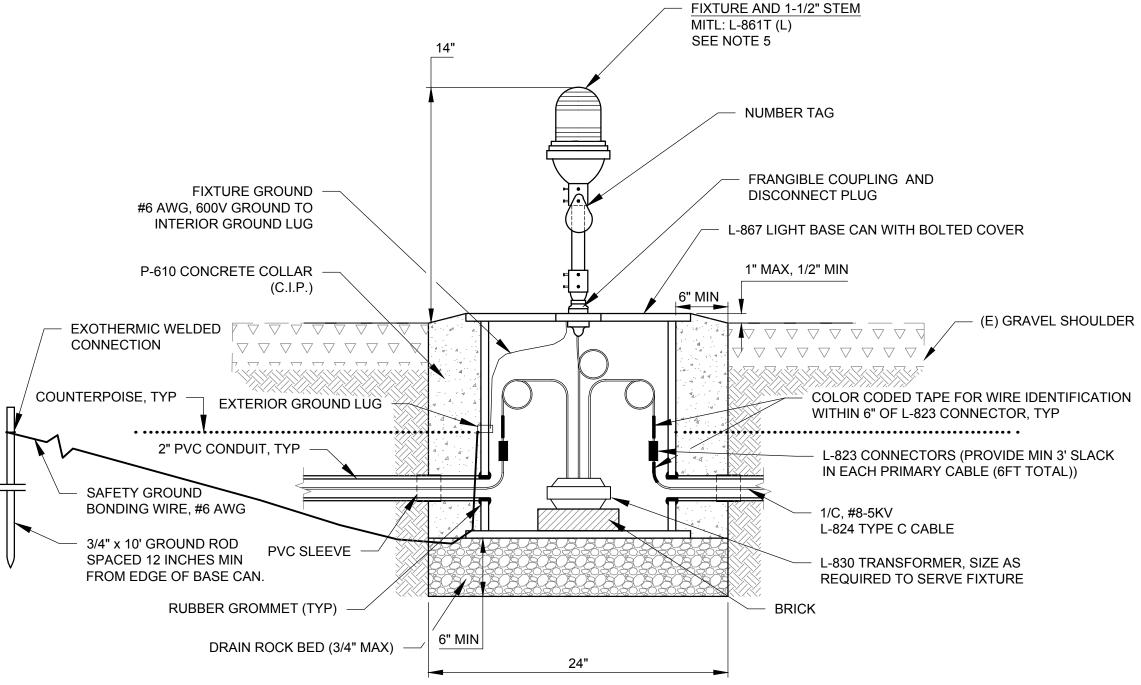- 1. SEE PLAN DRAWINGS FOR EDGE LIGHT AND NUMBERING TAG LOCATIONS. CONTRACTOR TO VERIFY FIXTURE TAG NUMBERS WITH THE AIRPORT.
- 2. NON-METALLIC COMPONENTS IN THE LIGHT FIXTURE STEMS AND BREAKABLE COUPLINGS ARE NOT PERMITTED. L-867 PLASTIC CANS ARE ACCEPTABLE, IF THE METAL THREADED FITTINGS ARE SET IN THE FLANGE DURING THE CASTING PROCESS AND THE CONSTANT CURRENT CIRCUIT IS NOT GROUNDED.
- 3. ALL HARDWARE SHALL BE STAINLESS STEEL. ALL MACHINE THREADED CONNECTIONS SHALL HAVE ANTI-SEIZING COMPOUND.



#### NOTES:

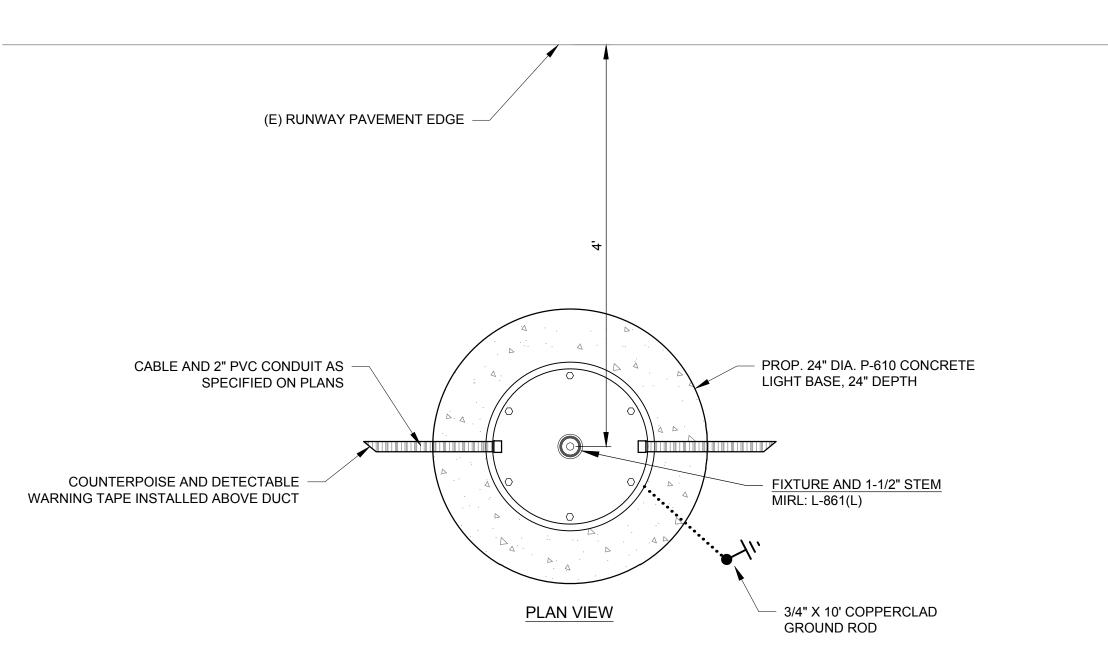- 1. LIGHTS AND BASES SHALL BE SET PLUMB AND HORIZONTALLY ALIGNED WITHIN ±1" OF TAXIWAY CENTERLINE.
- 2. PROVIDE 3 FT OF CABLE SLACK IN BASE CAN FOR EACH CABLE (6FT TOTAL).
- 3. SEE PLAN SET FOR ACTUAL NUMBER OF CABLES.
- 4. ALL HARDWARE SHALL BE STAINLESS STEEL. ALL MACHINE THREADED CONNECTIONS SHALL HAVE ANTI-SEIZING COMPOUND.
- 5. BLUE FOR TAXIWAY EDGE LIGHTS. RED/RED FOR TEMPORARY RELOCATED THRESHOLD LIGHTS.



1 ELEVATED EDGE LIGHT

NOT TO SCALE

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DESIGNED BY: MLF

DRAWN BY: MJK


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SHEET CONTENTS
ELECTRICAL DETAILS

SHEET NO. 35 of 40

FOR L-823 PLUG SPLICES AT TAXIWAY AND RUNWAY LIGHTS FIGURE A




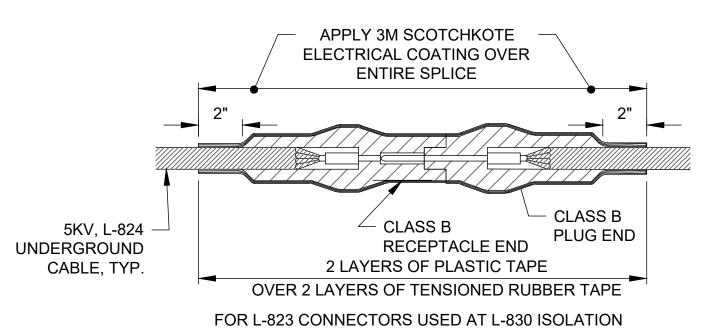1. L-823 SPLICE KITS SHALL BE "COMPLETE" OR "SUPER" KITS.


TRANSFORMER JUNCTION WITH 5KV LOOP CIRCUIT

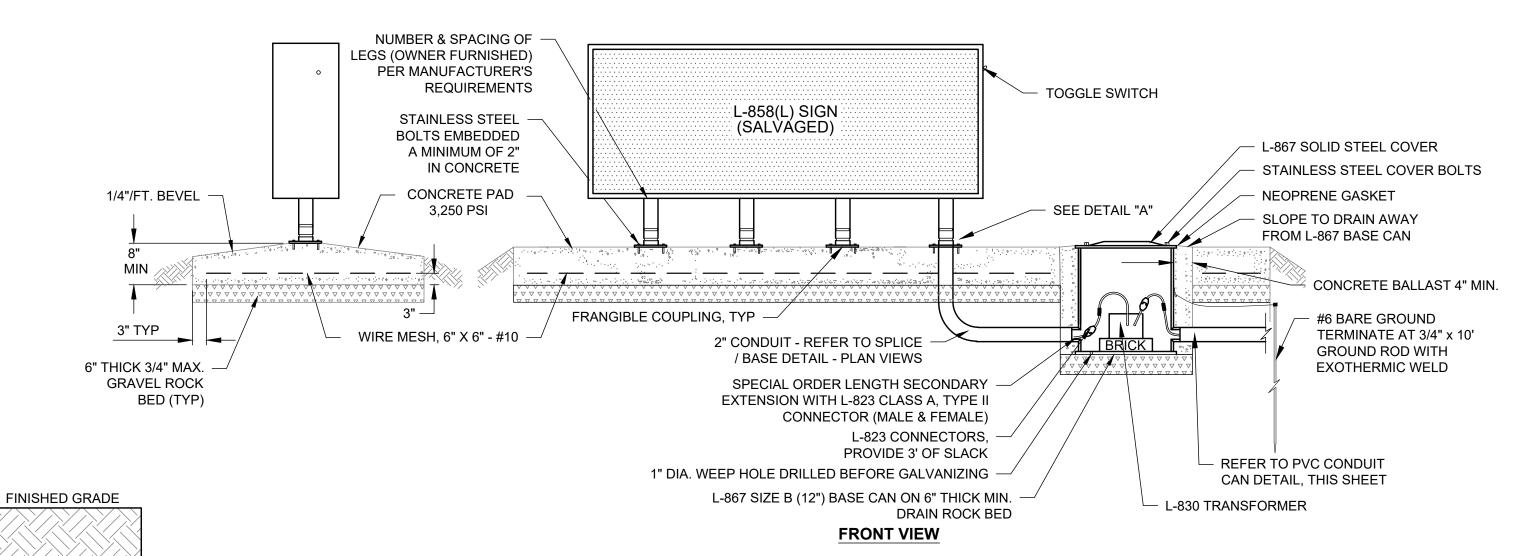FIGURE B






#### **SIDE VIEW**

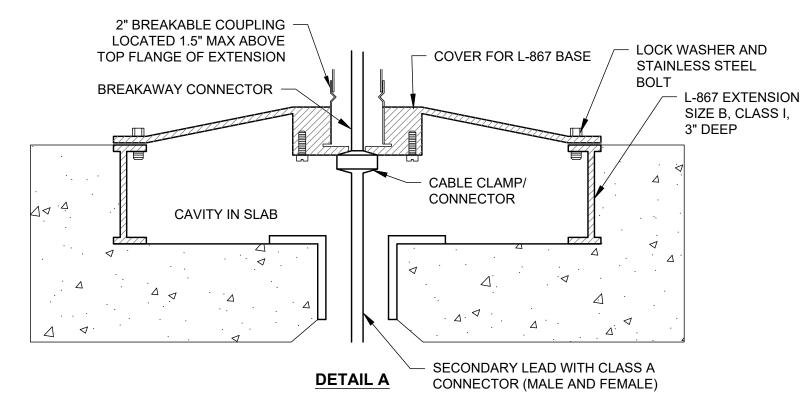

SIGN INSTALLATION NOTES:

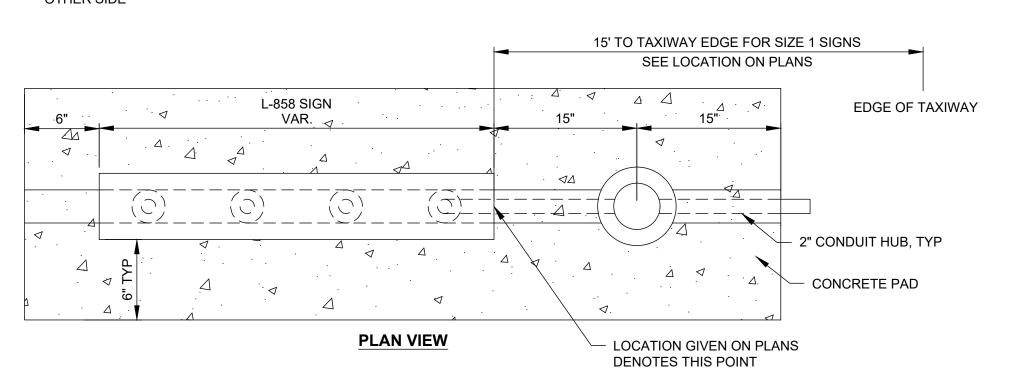- 1. FOLLOW MANUFACTURER'S RECOMMENDATION FOR L-823 CONNECTOR INSTALLATION.
- 2. COUPLING WEEP HOLES SHALL NOT DRAIN TO THE OUTSIDE OF THE L-867 BASE CAN OR LID.
- 3. PROVIDE ONE TETHER ON EACH END OF SIGN.
- 4. BOND SIGN METAL SURFACES TO LIGHT BASE GROUNDING LUG USING #6 BARE COPPER WIRE.
- 5. DIMENSION SIGN PAD PER PLAN VIEW.
- 6. ALL HARDWARE SHALL BE STAINLESS STEEL. ALL MACHINE THREADED CONNECTIONS SHALL HAVE ANTI-SEIZING COMPOUND.
- 7. WHEN WALKING TOWARDS THE SIGN ON THE CENTERLINE, AND THE SIGN IS ON THE LEFT, THAT IS SIDE A. SIDE B IS ON THE OTHER SIDE








3" MIN

2" SCH. 40 PVC

1. WHERE 2 OR MORE CONDUITS ARE INSTALLED IN THE SAME TRENCH, PROVIDE 3" MINIMUM SPACING HORIZONTAL BETWEEN CONDUIT OUTSIDE EDGES, AND NO LESS THAN 6" VERTICAL. SPACERS ARE REQUIRED AT 5' INTERVALS, PER L-110.

#### DIRECT BURY CONDUIT INSTALLATION NO SCALE

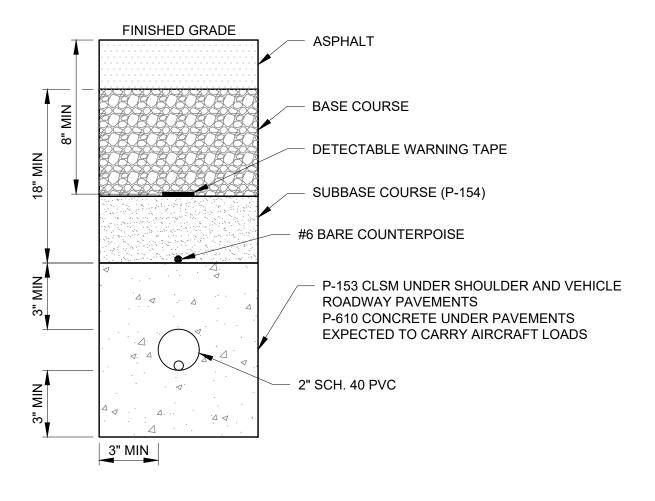

DETECTABLE WARNING TAPE

#6 BARE COUNTERPOISE

(SEE NOTES 2 & 3)

BACKFILL (L-110)

SAND (L-110)

#### NOTES:

- 1. COUNTERPOISE SHALL BE INSTALLED 3" MINIMUM ABOVE THE CONCRETE ENCASED CONDUIT FOR THE ENTIRE LENGTH OF CONDUIT INSTALLED.
- 2. WHERE 2 OR MORE CONDUITS ARE INSTALLED IN THE SAME TRENCH, PROVIDE 3" MINIMUM SPACING HORIZONTAL BETWEEN CONDUIT OUTSIDE EDGES, AND NO LESS THAN 6" VERTICAL. SPACERS ARE REQUIRED AT 5' INTERVALS, PER L-110.

CONCRETE ENCASED CONDUIT INSTALLATION

SHEET CONTENTS **ELECTRICAL DETAILS** 

3-41-0054-030-2024

1821200-221217.01

APRIL 2024

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36 of 40

DATE:

DESIGNED BY: MLF

DRAWN BY: MJK

CHECKED BY: RJB

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9600 NE Cascades Parkway

Suite 100

Portland, OR 97220

phone: 503-548-1494

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#### ABBREVIATIONS:

FND

FOS

F.P.

FTG

GALV.

A.B. ABC	ANCHOR BOLT AGGREGATE BASE COURSE	IBC INT	INTERNATIONAL BUILDING CODE INTERIOR
A.C.	ASPHALTIC CONCRETE	1141	INTERIOR
ACI	AMERICAN CONCRETE INSTITUTE	JST	JOIST
AISC	AMERICAN INSTITUTE OF STEEL CONSTRUCTION		
ALT	ALTERNATE	K.O.	KNOCK OUT
ARCH ASTM	ARCHITECT OR ARCHITECTURAL DRAWINGS	ı	ANCIE
ASTM	AMERICAN SOCIETY FOR TESTING AND MATERIALS	L LB	ANGLE POUND
BLDG	BUILDING	LL	LIVE LOAD
BLKG	BLOCKING	LOC	LOCATION
BM	BEAM	200	LOOATION
BOT	BOTTOM	MATL	MATERIAL
BRG	BEARING	MAX	MAXIMUM
		MFR	MANUFACTURER
CIP	CAST IN PLACE	MIN	MINIMUM
CJ	CONTROL JOINT	MISC	MISCELLANEOUS
CL	CENTER LINE	MOD	MODULAR
CLR	CLEAR		
CMU	CONCRETE MASONRY UNIT	N.I.C.	NOT IN CONTRACT
COL	COLUMN	NOM	NOMINAL
CONC	CONCRETE	NTS	NOT TO SCALE
CONST JT	CONSTRUCTION JOINT		
CONT.	CONTINUOUS	O.C.	ON CENTER
COORD.	COORDINATE	OSSC	OREGON STRUCTURAL SPECIALTIES CODE
CY	CUBIC YARD		
		P	PIPE
d OR db	DIAMETER OF BAR	PAF	POWDER ACTUATED FASTENER
DET	DETAIL	PL	PLATE
DIA	DIAMETER	PSF	POUNDS PER SQUARE FT.
DIAG	DIAGONAL	P.P.	PARTIAL PENETRATION
DIM	DIMENSION	REINF	DEINICODOINO OTEEI
DL	DEAD LOAD		REINFORCING STEEL
DWG	DRAWING	R.O.	ROUGH OPENING
EA	EACH	SQ.	SQUARE
ELEC	ELECTRICAL DRAWINGS	S.W.	SHEAR WALL
ELEV	ELEVATION		
ENCL	ENCLOSE (URE)	T&B	TOP & BOTTOM
ENGR	ENGINEER	TS	TUBE STEEL
EQ	EQUAL	\\/ OD \\/ =	MIDE ELANOE
E.S.	EACH SIDE	W OR WF	WIDE FLANGE
EXP	EXPANSION	WT.	WEIGHT
EXST OR (E)	EXISTING	W/	WITH
EXT	EXTERIOR		

FURNISHED BY OTHERS

FACE OF STRUCTURE

FULL PENETRATION

FOUNDATION

GAGE (GAUGE)

GALVANIZED

FOOTING

**GENERAL** 

- 1. THE CONTRACT STRUCTURAL DRAWINGS AND SPECIFICATIONS REPRESENT THE FINISHED STRUCTURE. THEY DO NOT INDICATE THE METHOD OF CONSTRUCTION. THE CONTRACTOR SHALL PROVIDE ALL MEASURES NECESSARY TO PROTECT THE STRUCTURE DURING CONSTRUCTION. SUCH MEASURES SHALL INCLUDE, BUT NOT BE LIMITED TO BRACING, SHORING FOR LOADS DUE TO CONSTRUCTION EQUIPMENT, ETC. OBSERVATION VISITS TO THE SITE BY THE STRUCTURAL ENGINEER SHALL NOT INCLUDE INSPECTION OF THE ABOVE ITEMS.
- 2. THE CONTRACTOR SHALL VERIFY DIMENSIONS AND ALL EXISTING CONDITIONS SHOWN ON THE DRAWINGS IN THE FIELD AND NOTIFY ENGINEER OF ANY DISCREPANCIES FOR CORRECTION OR VERIFICATION PRIOR TO CONSTRUCTION OF THE AFFECTED WORK. THE COST OF ADDITIONAL DESIGN WORK DUE TO ERRORS OR OMISSIONS IN CONSTRUCTION SHALL BE BORNE BY THE CONTRACTOR.
- 3. ESTABLISH AND VERIFY ALL OPENINGS AND INSERTS FOR MECHANICAL, ELECTRICAL AND PLUMBING WITH APPROPRIATE TRADES AND THE DRAWINGS.
- 4. PROVIDE ALL NECESSARY TEMPORARY BRACING, SHORING, GUYING OR OTHER MEANS TO AVOID EXCESSIVE STRESSES AND TO HOLD STRUCTURAL ELEMENTS IN PLACE DURING CONSTRUCTION.
- 5. DETAILS ON THE DRAWINGS ARE TYPICAL. VERIFY ALL DIMENSIONS.
- 6. DIMENSIONS ON THE STRUCTURAL DRAWINGS ARE EXACT WITH THE EXCEPTION OF MASONRY AND SAWN LUMBER DIMENSIONS WHICH ARE NOMINAL.
- 7. NOTES AND DETAILS ON DRAWINGS SHALL TAKE PRECEDENCE OVER GENERAL NOTES AND TYPICAL DETAILS. WHERE NO DETAILS ARE SHOWN, CONSTRUCTION SHALL CONFORM TO SIMILAR WORK ON THE PROJECT.
- 8. WHERE REFERENCE IS MADE TO VARIOUS TEST STANDARDS FOR MATERIALS, SUCH
- STANDARDS SHALL BE THE LATEST EDITION AND/OR ADDENDUM.
- 9. DRAWINGS AND SPECIFICATIONS ARE INSTRUMENTS OF SERVICE IN RESPECT TO THIS SPECIFIC PROJECT AND ARE NOT INTENDED OR REPRESENTED TO BE SUITABLE FOR REUSE ON EXTENSIONS OF THIS PROJECT OR ON ANY OTHER PROJECT .ANY REUSE WITHOUT WRITTEN VERIFICATION OR ADAPTATION BY ENGINEER WILL BE AT OWNER'S SOLE RISK AND WITHOUT LIABILITY OR LEGAL EXPOSURE TO ENGINEER. OWNER SHALL INDEMNIFY AND HOLD HARMLESS ENGINEER FROM ANY AND ALL CLAIMS, DAMAGES, LOSSES AND EXPENSES INCLUDING ATTORNEY'S FEES ARISING OUT OF OR RESULTING FROM UNAUTHORIZED REUSE.
- 10. NO CHANGES FROM THE APPROVED STRUCTURAL PLANS SHALL BE MADE IN THE FIELD UNLESS, PRIOR TO MAKING CHANGES, WRITTEN APPROVAL IS OBTAINED FROM THE ENGINEER. IF CHANGES ARE MADE WITHOUT WRITTEN APPROVAL SUCH CHANGES SHALL BE THE LEGAL AND FINANCIAL RESPONSIBILITY OF THE CONTRACTOR OR SUB-CONTRACTORS INVOLVED AND IT SHALL BE THEIR RESPONSIBILITY TO REPLACE OR REPAIR THE CONDITION AS DIRECTED BY THE ENGINEER.
- 11. ENGINEERING DESIGN PROVIDED BY OTHERS AND SUBMITTED FOR REVIEW SHALL BEAR THE SEAL AND SIGNATURE OF A PROFESSIONAL ENGINEER REGISTERED IN OREGON.
- 12. USE OF THESE PLANS BY THE CONTRACTOR CONSTITUTES ACCEPTANCE OF THESE NOTES AND CONDITIONS.
- 13. THE RETAINING WALL DESIGN IS BASED ON JET BLAST LOADS OF 50PSF. THE CONTRACTOR IS RESPONSIBLE FOR COORDINATION OF ANY REVISIONS REQUIRED.
- 14. THE SIZE, NUMBER, AND PLACEMENT OF ANCHOR BOLTS FOR THE BLAST FENCE IS TO BE DETERMINED BY THE BLAST FENCE MANUFACTURER. CONTRACTOR IS REQUIRED TO COORDINATE ANCHORAGE LOCATIONS WITH SUPPLEMENTAL WALL
- 15. CONTRACTOR IS TO PROVIDE FINAL BLAST FENCE DESIGN LOADS TO THE ENGINEER FOR REVIEW PRIOR TO WORK.

#### STRUCTURAL NOTES

- 16. 2022 OREGON STRUCTURAL SPECIALTIES CODE
- 17. ACI 318-19

**DESIGN LOADS** 

- 18. IMPACT LOAD TO BLAST DEFLECTOR PROVIDED BY BLAST DEFLECTORS, INC. (BDI)
- CONCRETE NOTES AND REINFORCING STEEL NOTES

MATERIAL PROPERTIES:

COMPRESSIVE STRENGTH, F'C = 4.5 KSI CONCRETE REINFORCEMENT, FY = 60 KSI (A615 GR 60)

- 19. FOOTING SUBGRADES SHALL BE CLEAN AND FREE OF DEBRIS, STANDING WATER, AND LOOSE SOIL.
- 20. ALL BAR LAPS SHALL COMPLY WITH ACI 318, CLASS "B" SPLICE CRITERIA.
- 21. LAP LENGTH SHALL BE SPECIFICALLY NOTED ON SHOP DRAWINGS WHERE MORE THAN ONE BAR MAKES UP A CONTINUOUS STRING.

#### **SCOPE OF SPECIAL INSPECTIONS**

THE FOLLOWING REQUIRES SPECIAL INSPECTION;

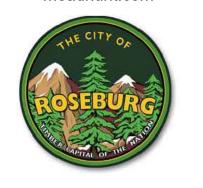
FREQUENCY **EXCAVATED SOIL** AFTER EXCAVATION

CAST IN PLACE CONCRETE CONTINUOUS DURING PLACEMENT, SAMPLES SHALL BE TESTED FOR SLUMP, AIR CONTENT, TEMPERATURE AND COMPRESSIVE STRENGTH PER CURRENT ASTM STANDARDS.

AFTER PLACEMENT REINFORCING STEEL

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<u>S</u> Ш AXIWA SEB

ISSUED FOR BID

NW STEEBURG,

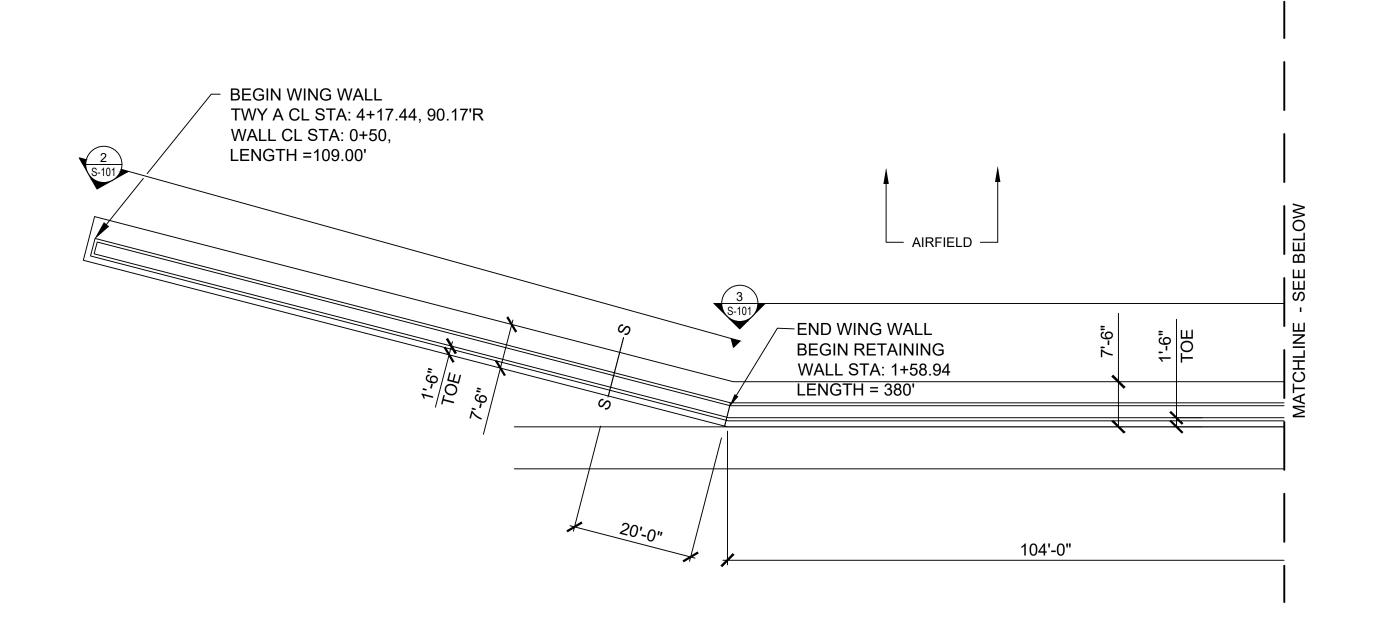


3-41-0054-030-2024 1821200-221217.01 DATE: APRIL 2024 DESIGNED BY: MLF

DRAWN BY: MJK CHECKED BY: RJB DO NOT SCALE DRAWINGS

SHEET CONTENTS GENERAL RETAINING WALL STRUCTURAL NOTES

SHEET NO. **37** of **40** 



<u>LEGEND</u>

S——S STEPPED FOOTING LOCATION, SEE 5/S-201

EXPANSION JOINT, SEE 7/S-201

CONTROL JOINT, SEE 8/S-201

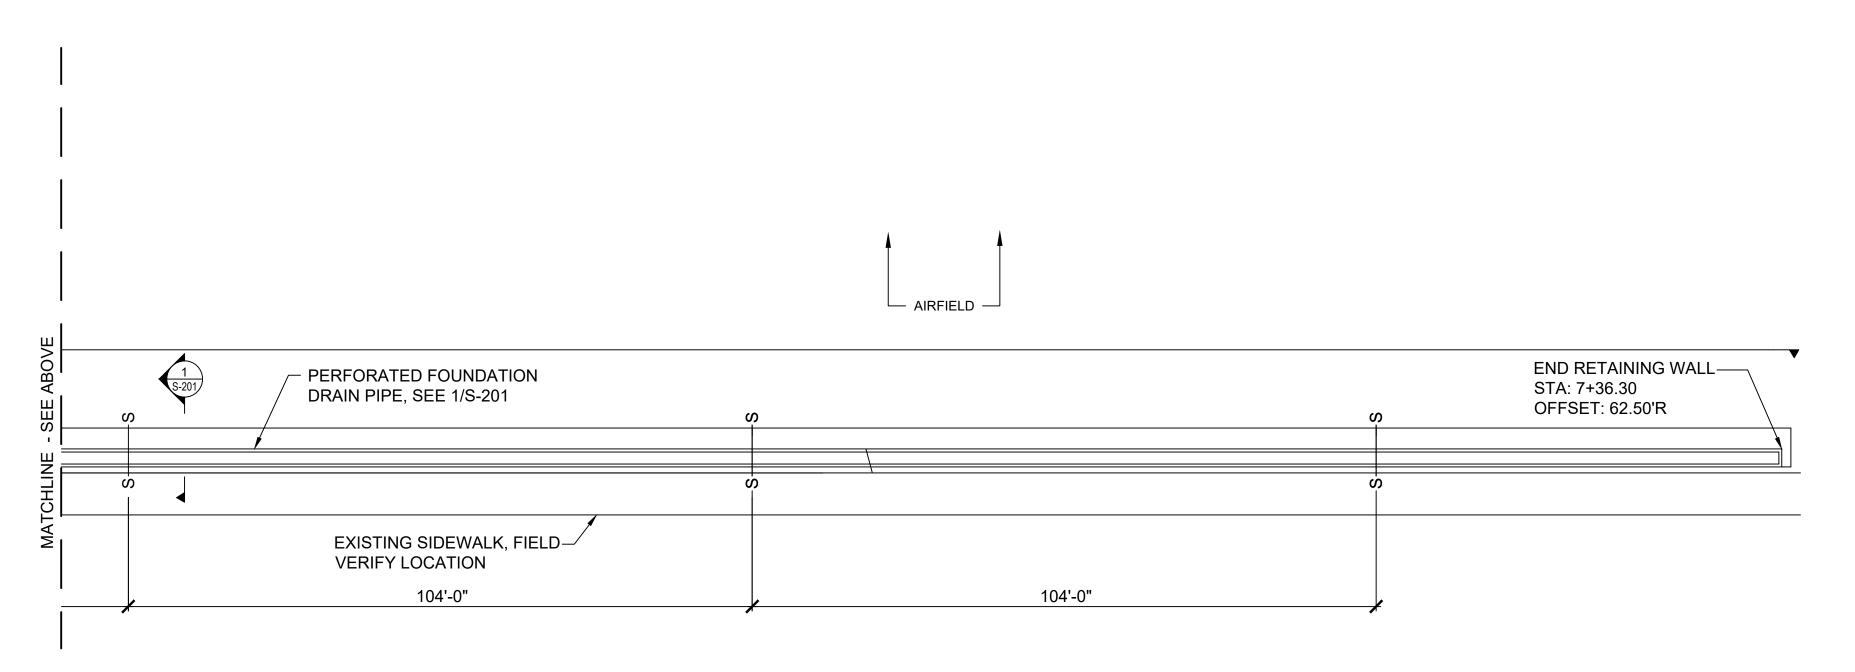
6/S-201

1. SEE S-201 FOR TYPICAL CONCRETE DETAILS.

2. WHERE FIBER OPTICS LINE IS **ENCOUNTERED PROVIDE SPLIT** STEEL PIPE ENCASEMENT PER

3. STATIONING AND OFFSET ARE AT FRONT OF WALL. COORDINATE **DIMENSIONS WITH C-101** 


WING WALL AND RETAINING WALL PLAN S-101 SCALE: 1/16" = 1'-0"



WING WALL AND RETAINING WALL PLAN S-101 SCALE: 1/16" = 1'-0"

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AIRPOR XTENSION REGIONAL TAXIWAY ROSEBI 3896 NW STE ROSEBURG,
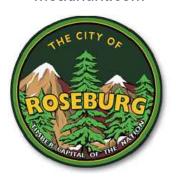
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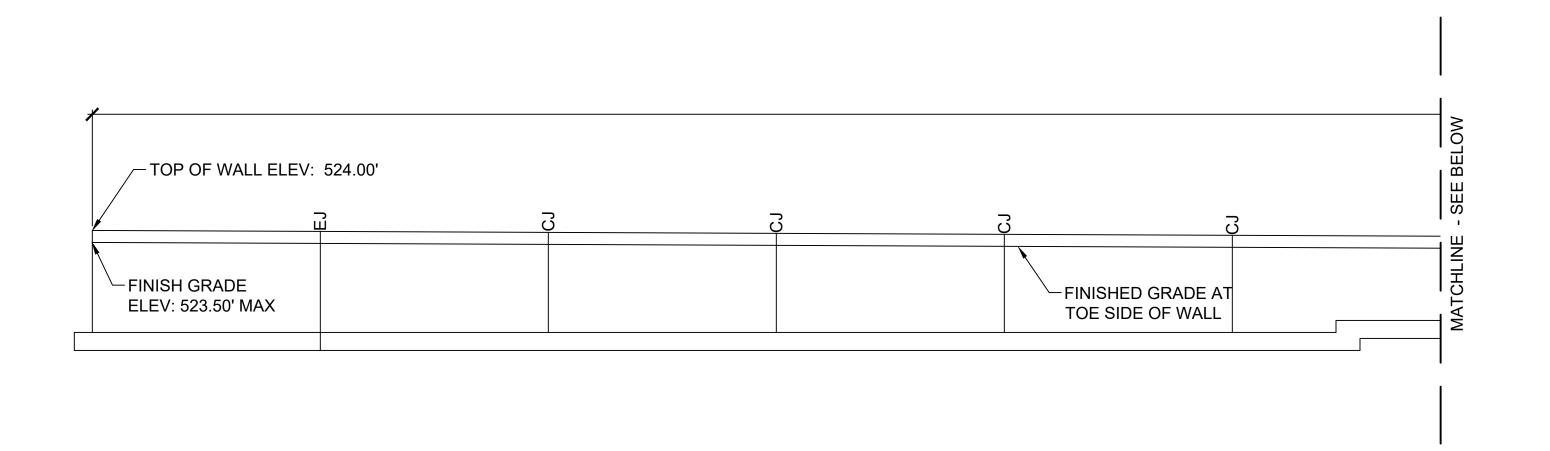
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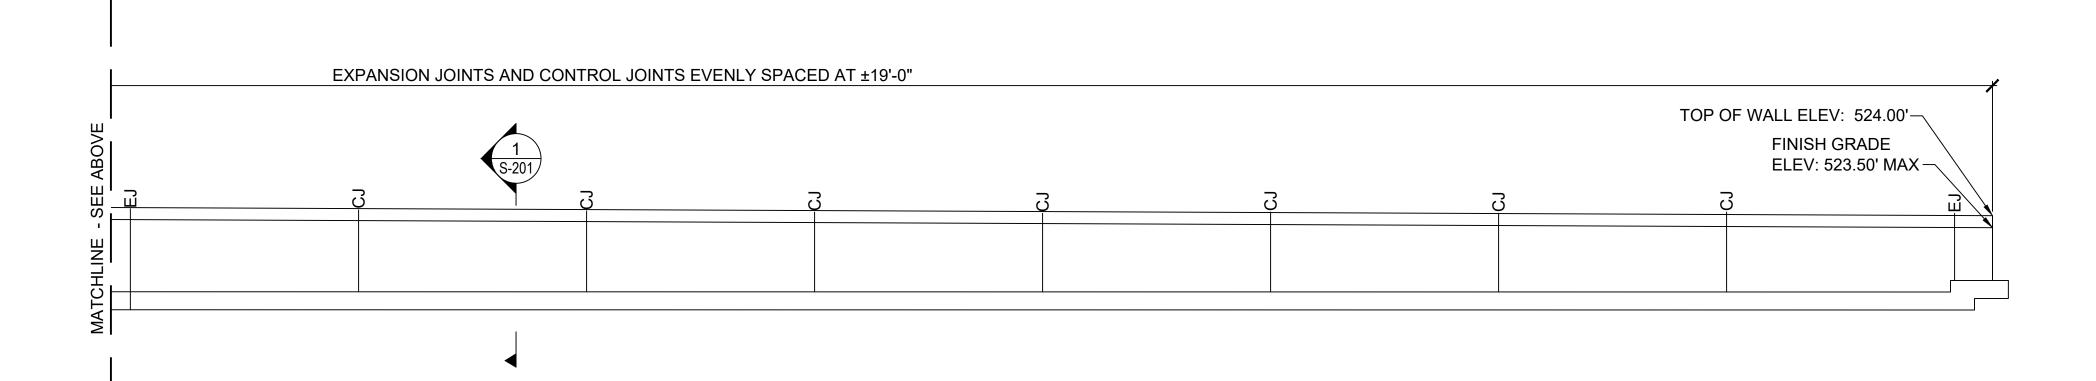
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SHEET CONTENTS **RETAINING WALL** PLAN & ELEVATIONS

SHEET NO. 38 of 40

S-101





RETAINING WALL - AIRFIELD SIDE

S-101 SCALE: 1/8" = 1'-0"

Mead Unt

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# ROSEBURG REGIONAL AIRPORT TAXIWAY A EXTENSION 3896 NW STEWART PARKWAY ROSEBURG, OR 97470

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AIP NO.: 3-41-0054-030-2024

M&H NO.: 1821200-221217.01

DATE: APRIL 2024

DESIGNED BY: MLF

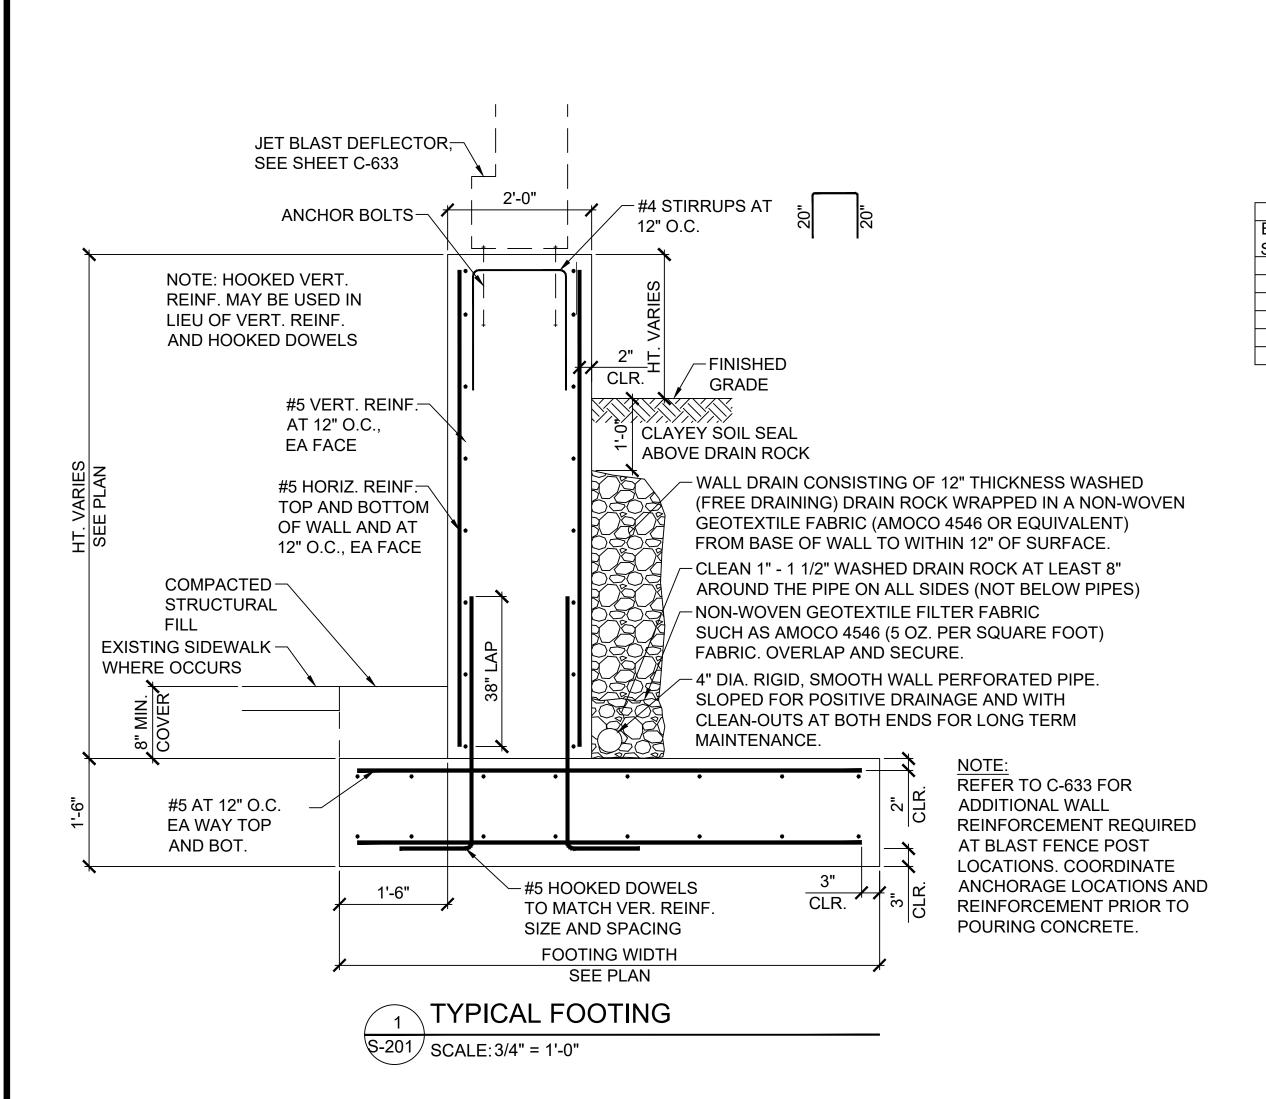
DRAWN BY: MJK

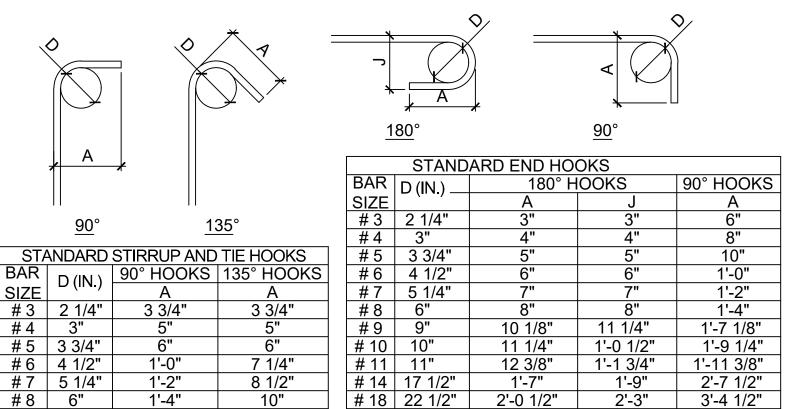
DRAWN BY: MJK
CHECKED BY: RJB
DO NOT SCALE DRAWINGS

RETAINING WALL
PLAN & ELEVATIONS

SHEET NO. 39 of 40


S-102







#### REINFORCING BAR BENDS

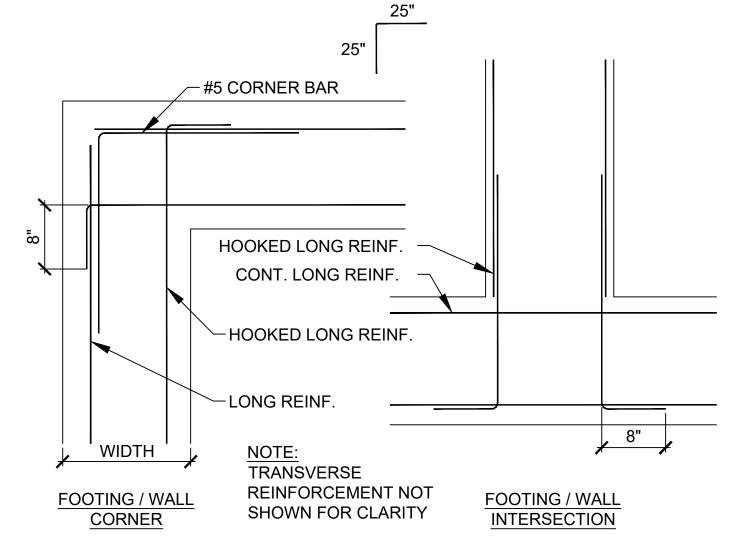\$-201 | SCALE: 1 1/2" = 1'-0"



TYPICAL FOOTING AND WALL REINF. \$-201 | SCALE: 1" = 1'-0"

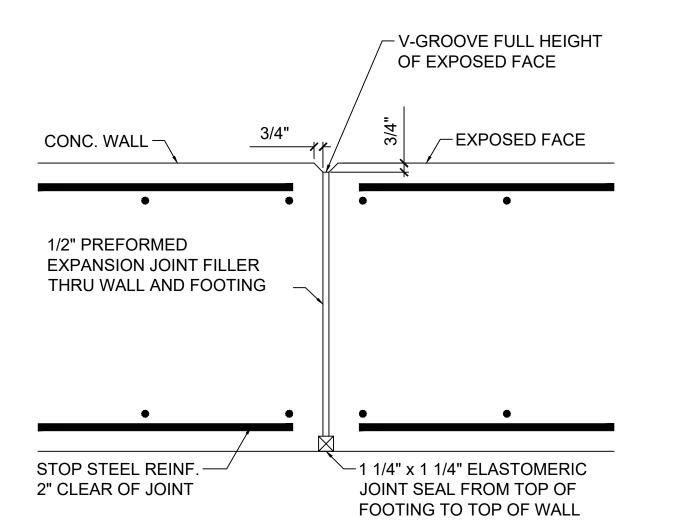

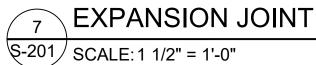


MINIMUM REINFORCING	BAR LAP SPLICE L	.ENGTH		
	LENGTH			
#3	23"			
#4	31"			
#5	38"			
#6	46"			
#7	67"			
#8	76"			
#9	86"			
#10	95"			
#11	104"			
MINIMUM REINFORCING	BAR LAP SPLICE LI	ENGTH		
CONDITION		COVER		
CONCRETE CAST ON EAR	RTH	3"		
CONC. EXPOSED TO EAR	TH OR WEATHER			
#6 OR LARGER		2"		
#5 OR SMALLER		1 1/2"		
CONC. NOT EXPOSED TO EARTH OR WEATHER, SLABS, WALLS, OR JOISTS				
· · · · · · · · · · · · · · · · · · ·	5, 01( 3013 13	1 1/0"		
#14 OR #18		1 1/2"		
#11 OR SMALLER		3/4"		
BEAMS OR COLUMNS		1 1/2"		

NOTE: SEE DRAWINGS FOR OTHER SPECIFIC COVER REQUIREMENTS

TYPICAL LAP SPLICE AND COVER

\$-201 | SCALE: 1" = 1'-0"

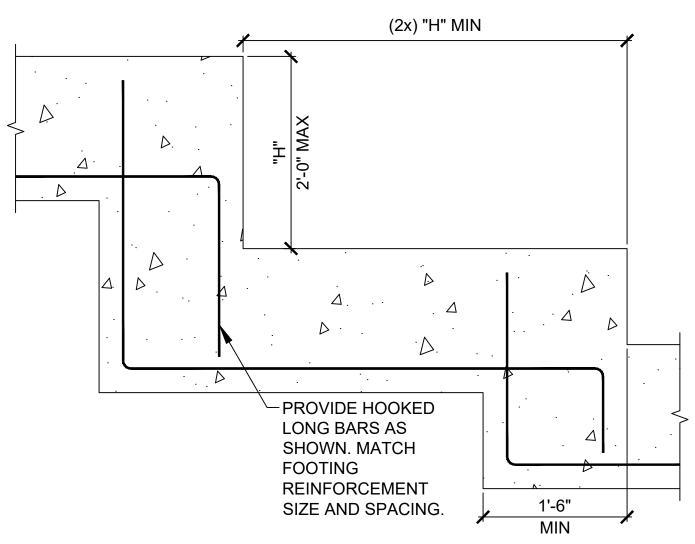

TYPICAL STEPPED FOOTING REINF. S-201 | SCALE: 1" = 1'-0"


─ V-GROOVE FULL HEIGHT OF EXPOSED FACE, ACROSS TOP AND 1'-0" DOWN BACK FACE 3/4" CONC. WALL -STOP STEEL REINF. 3/4" PLYWOOD, EXTEND 2" CLEAR OF JOINT FROM TOP OF FOOTING TO 1'-0" BELOW TOP OF WALL

8 CONTROL JOINT - CJ S-201 | SCALE: 1 1/2" = 1'-0"

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AIRP TENSION GION AXIWA 3896 NW STE ROSEBURG, OSEB

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SHEET CONTENTS RETAINING WALL STRUCTURAL DETAILS

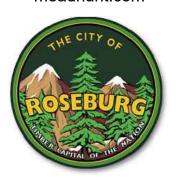SHEET NO. 40 of 40

S-201