

LINCOLN STREET CURB RAMP IMPROVEMENTS

PROJECT NO. 21PW01 PH 1

FEBRUARY 2021

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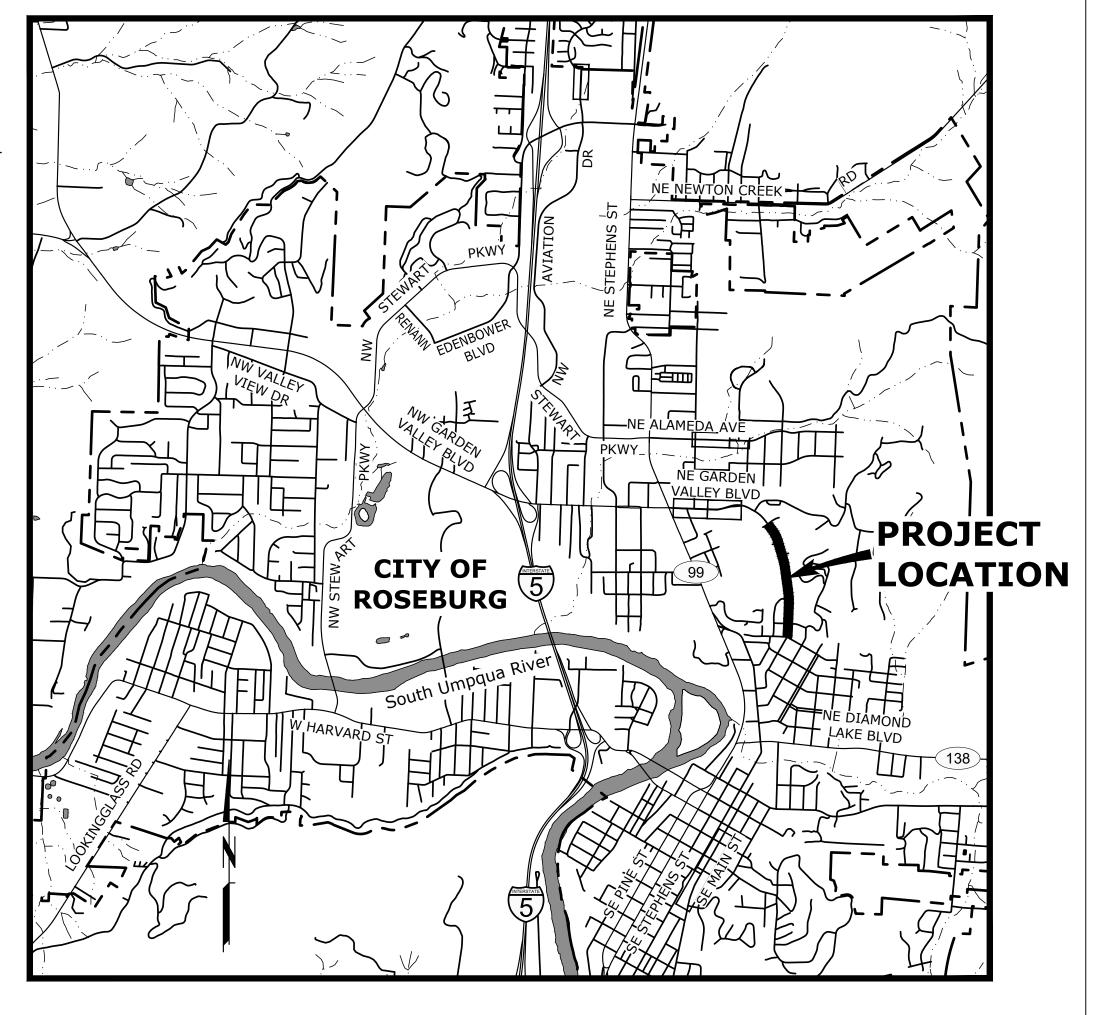
CONCRETE INLET BASE TYPE CG-3

CONCRETE INLET TOP, OPTION 1 TYPE CG-3 MISCELLANEOUS DRAINAGE STRUCTURES SIPHON BOX, INLET CAP, & INLET ADJUSTMENT **RD700 CURB LINE SIDEWALKS** SIDEWALK JOINTS AND TRANSITION PANELS **RD755** CURB RAMP LAYOUT OPTIONS SMALL RADII CURB RAMP LAYOUT OPTIONS LARGE RADII SIGN INSTALLATION DETAILS TM500 PAVEMENT MARKING STANDARD DETAIL BLOCKS TM502 PAVEMENT MARKING STANDARD DETAIL BLOCKS PAVEMENT MARKING STANDARD DETAIL BLOCKS TM503 INTERSECTION PAVEMENT MARKINGS (CROSSWALK, STOP BAR & BIKE LANE STENCIL) TM530 TM677 SIGN MOUNTS TABLES, ABRUPT EDGE, AND PCMS DETAILS TM800 TM810 TEMPORARY PAVEMENT MARKING TEMPORARY BARRICADES TM820 TM821 TEMPORARY SIGN SUPPORTS TM841 INTERSECTION WORK ZONE DETAILS TM844 TEMPORARY PEDESTRIAN ACCESS ROUTING 2-LANE, 2-WAY ROADWAYS TM850

ATTENTION: OREGON LAW REQUIRES THE CONTRACTOR TO FOLLOW THE RULES ADOPTED BY THE OREGON UTILITY NOTIFICATION CENTER. THOSE RULES ARE SET FORTH IN OAR 952-001-0010 THROUGH OAR 952-001-0090. THE CONTRACTOR MAY OBTAIN COPIES OF THE RULES BY CALLING THE UTILITY NOTIFICATION CENTER. (NOTE: THE TELEPHONE NUMBER FOR THE OREGON UTILITY NOTIFICATION CENTER IS 503-246-6699.)




ENGINEERING 5500 MEADOWS RD. #250 | LAKE OSWEGO, OR 97035 | LAKE OSWEGO, OR 97035 | 503.419.2130



VICINITY MAP

SCALE: 1"=2,000'

NO. DATE BY	REVISION	SCALE	DESIGNED: J. JENKINS	ERED PROFES	CE	NITI IDV		900 SE DOUGLAS AVE.		BBREVI <i>A</i>
SINUCIURE UK FACILITY								-		
STRUCTURE OR FACILITY	S/W							SQ SQ FT	SQUARE SQUARE FOOT	
LANDSCAPE SIDEWALK		* * * * * * * * * * *			GRVL GV	GRAVEL GATE VALVE		SPL SPR	SPOOL SANITARY POINT REPAIR	
EDGE OF PAVEMENT/AC		 			GALV GR	GALVANIZED GRADE		SLP SPECS	SLOPE SPECIFICATIONS	
	· · · · · · · · · · · · · · · · · · ·				G	GAS		SDMH SHT(S)	STORM DRAIN MANHOLE SHEET(S)	
WATER METER WATER VALVE	\otimes				FT FTG	FEET/FOOT FITTING		SCHED SD	SCHEDULE STORM DRAIN	
WATER METER					FM FO	FORCE MAIN FIBER OPTIC		SB	SOUTHBOUND	
UTILITY BOX UTILITY POLE	——————————————————————————————————————				FL FLG	FLANGE(D)		RT R/W	RIGHT OF WAY	
UTILITY BOX	(T)				FIN GR	FINISHED GRAI FLOW LINE		RET RT	RETAINING RIGHT	
TREE CONTFEROUS TREE DECIDUOUS	Minist Committee				FD FH	FLOOR DRAIN FIRE HYDRANT		REQ'D RESTR	REQUIRED RESTRAIN(ED)	
TREE CONIFEROUS	WWW.				FAB	FABRICATE		REHAB REINF	REHABILITATE/REHABILITATION REINFORCE(D)(ING)(MENT)	
TELEPHONE BOOTH	ТВ				EXIST EG	EXISTING EXISTING GRAI	DE	RD RDCR	ROAD/ROOF DRAIN REDUCER	
SURVEY MONUMENT	<i>(</i>)				ESC ESMT	EASEMENT	MENTATION CONTROL	R&R RCP	REMOVE AND REPAIR REINFORCED CONCRETE PIPE	
STRIPING NOTES, SEE STRIPING DETAIL SHEET D2	$X \longrightarrow X$				EQ EQUIP	EQUAL EQUIPMENT	MENITATION CONTROL	R	RADIUS	
SIGNAL POLE					EOP	EDGE OF PAVE	MENT	PW	PUBLIC WORKS	
SIGN	-0-				EL ELEC/E	ELEVATION ELECTRICAL		PVC PVMT	POLYVINYL CHLORIDE PAVEMENT	
PEDESTRIAN/BIKE POLE					EA EB	EACH EASTBOUND		PT PV	POINT OF TANGENCY PLUG VALVE	
MANHOLE					DWY	DRIVEWAY		PS PSI	PUMP STATION POUNDS PER SQUARE INCH	
MAILBOX		6			DR DWG	DRIVE DRAWING		PRESS PROP	PRESSURE PROPOSED	
LIGHT POST	\$				DI DIA	DUCTILE IRON DIAMETER		P/L PL	PROPERTY LINE PLACE	
JUNCTION BOX					DBH DET(S)	DIAMETER AT E DETAIL(S)		PIVC PK	POINT OF INTERSECTION ON VERTICAL CURVE PARKING	
IRON ROD					D	DRAIN		PERM PI	PERMANENT POINT OF INTERSECTION	
GUY WIRE	\leftarrow				CHKV CY	CHECK VALVE CUBIC YARD		PE PERF	PLAIN END PERFORATED	
GAS VALVE					СТ	CRUSHED ROCI	N.	PCVC	PORTABLE CHANGEABLE MESSAGE SIGN POINT OF CURVATURE ON VERTICAL CURVE	
GAS METER					CP CPLG CR	COUPLING		PCC PCMS	PORTLAND CEMENT CONCRETE	
FIRE HYDRANT ASSEMBLY	Q				COR CP	CITY OF ROSEE CONCRETE PIPE		P PC	POWER POINT OF CURVE	
CLEAN-OUT	\circ	•			COORD COP	COORDINATE COPPER		OVHD	OVERHEAD LINE	•
CATCH BASIN/FIELD INLET					CONN CONST	CONNECTION CONSTRUCT/CO	ONSTRUCTION	OD ODOT	OUTSIDE DIAMETER OREGON DEPARTMENT OF TRANSPORTATION	W/IN W/O
BOLLARD					COMM CONC	COMMUNICATION CONCRETE	OND	OC	ON CENTER	WZ W/
BENCHMARK					СО	CLEANOUT	ONC	NTS	NOT TO SCALE	WM
WATERLINE	10"W				CLSM CND		LOW STRENGTH MATERIAL	NO NOM	NUMBER NOMINAL	W WB
TRAFFIC SIGNAL CABLE/CONDUIT	— — — TR— — —				CL CLR	CLASS CLEAR		NB	NORTHBOUND	VCP
TELEPHONE/TELEMETRY					CIPP CG	CURED IN PLAC CURB/GUTTER		MON(S) MUTCD	MONUMENT(S) MANUAL OF UNIFORM TRAFFIC CONTROL DEVICES	
STORM DRAIN	8"SD				CDF CI	CONTROLLED D CAST IRON		MIN MJ	MINIMUM MECHANICAL JOINT	USDOT
SANITARY SEWER LINE	8"SS				CB CCTV	CATCH BASIN CLOSED CIRCU		MH(S) MHMAC	MANHOLE(S) MINOR HOT MIX ASPHALT CONCRETE	TYP
RIGHT-OF-WAY					C/L	CENTER LINE		MAX MFR(S)	MANUFACTURER('S)	TV
RAILING	0-0-0-0-0-0-0-0-0-0-0-0-0-0-0-				BETW	BETWEEN		MATL(S)	MATERIAL(S) MAXIMUM	THK THRU
GAS	4"G				BEDG BM BTM	BENCHMARK BOTTOM		MAINT	MAINTAIN	TCP TEMP
FENCE	XXX				BFILL BLDG	BACKFILL BUILDING		LS LT	LONG SLEEVE LEFT	TBM TCM
ELECTRICITY	— — — E— — —				AWWA		TER WORK ASSOCIATION	LN LP	LANE LOW PRESSURE	TB TBD
EDGE OF GRAVEL					ASSY ARV	ASSEMBLY AIR RELEASE V		LAT LF	LATERAL LINEAR FEET	T/TEL
EASEMENT/PROPERTY LINE					APPVD APWA		BLIC WORKS ASSOCIATION	IR	IRON ROD	STPR S/W
DRAINAGE DITCH					ANSI APPROX	APPROXIMATE(ΓΙΟΝΑL STANDARDS INSTITU (LY)	INSTL	INVERT ELEVATION INSTALL	STD STL
CURB					AL	ALUMINUM	FIONAL STANDARDS INSTITU	ID TE IE	IDENTIFICATION/INSIDE DIAMETER	STA
CULVERT	>				ADWF AGG		WEATHER FLOW	HP	HIGH PRESSURE	SST
CHAIN LINK FENCE					AC ACP	ASPHALTIC CO		HORIZ HWY	HORIZONTAL HIGHWAY	SSCO SSMH
CENTERLINE					@ ABAN	AT ABANDON(ED)		HMAC HDPE	HOT MIX ASPHALT CONCRETE HIGH DENSITY POLYETHELENE	SS SSC
	<u>EXISTING</u>	<u>PROPOSED</u>								
LEGEND					I ADDKE	/IATIONS				

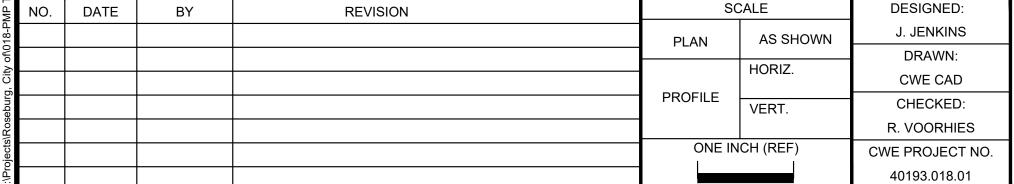





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ROSEBURG, OR 97470

CITY PROJECT #: 21PW01 PH 1 **CITY PROJECT MANAGER RICK CASTLE**

LEGEND & ABBREVIATIONS

SANITARY SEWER

STAINLESS STEEL

STORM POINT REPAIR

TEMPORARY BENCH MARK

TRAFFIC CONTROL PLAN

THICK/THICKNESS

TRANSPORTATION

VITRIFIED CLAY PIPE

VERTICAL(LY)

WESTBOUND

WATER METER **WORK ZONE**

TRAFFIC CONTROL MEASURES

UNITED STATES DEPARTMENT OF

STREET

STATION

STEEL

STANDARD

SIDEWALK

TELEPHONE

TEMPORARY

THROUGH

TYPICAL

WATER

WITH WITHIN

WITHOUT

TELEVISION

THRUST BLOCK TO BE DETERMINED

STAINLESS STEEL CLAMPS

SANITARY SEWER CLEANOUT

SANITARY SEWER MANHOLE

G-02

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LINCOLN STREET CURB RAMP IMPROVEMENTS **FEBRUARY 2021**

3. IT SHALL BE THE RESPONSIBILITY OF THE CONTRACTOR TO VERIFY ALL UTILITY LOCATIONS PRIOR TO CONSTRUCTION AND ARRANGE FOR THE RELOCATION OF ANY UTILITIES IN CONFLICT WITH THE PROPOSED CONSTRUCTION. THE LOCATIONS, DEPTH AND DESCRIPTION OF EXISTING UTILITIES SHOWN WERE COMPILED FROM AVAILABLE RECORDS. THE ENGINEER OR UTILITY COMPANIES DO NOT GUARANTEE THE ACCURACY OR THE COMPLETENESS OF SUCH RECORDS. ADDITIONAL UTILITIES, OTHER THAN THOSE SHOWN, MAY EXIST WITHIN THE WORK AREA.

4. OREGON LAW REQUIRES THAT THE RULES ADOPTED BY OREGON UTILITY NOTIFICATION CENTER BE FOLLOWED. THOSE RULES ARE SET FORTH IN OAR 952-001-0010 THROUGH OAR 952-001-0090. YOU MAY OBTAIN COPIES OF THE RULES BY CALLING THE CENTER OR ACCESSING VIA INTERNET AT WWW.CALLBEFOREYOUDIG.ORG. CALL BEFORE YOU DIG - 811.

5. THE CONTRACTOR SHALL MAKE PROVISIONS TO KEEP ALL EXISTING UTILITIES IN SERVICE AND PROTECT THEM DURING CONSTRUCTION. CONTRACTOR SHALL IMMEDIATELY REPAIR OR REPLACE ANY DAMAGED UTILITIES USING MATERIALS AND METHODS APPROVED BY THE UTILITY OWNER. NO SERVICE INTERRUPTIONS SHALL BE PERMITTED WITHOUT PRIOR WRITTEN AGREEMENT WITH THE UTILITY PROVIDER.

6. CONTRACTOR SHALL NOTIFY THE ENGINEER AND THE CITY OF ROSEBURG 48 HOURS IN ADVANCE OF STARTING CONSTRUCTION AND 24 HOURS BEFORE RESUMING WORK AFTER SHUTDOWNS, EXCEPT FOR NORMAL RESUMPTION OF WORK FOLLOWING SATURDAYS, SUNDAYS, OR HOLIDAYS.

7. CONTRACTOR SHALL REMOVE AND DISPOSE OF CONCRETE, ASPHALT CEMENT, TOPSOIL, AND OTHER MATERIAL IN THE WORK LIMITS AND WHERE INDICATED ON THE PLANS. MATERIAL SHALL BE DISPOSED OF IN SUCH A MANNER AS TO MEET ALL APPLICABLE REGULATIONS. CONTRACTOR SHALL ENSURE RECIPIENTS OF FILL MATERIALS REMOVED OFFSITE ARE PERMITTED TO RECEIVE SAID MATERIALS REGARDLESS OF THE RECEIVING JURISDICTION.

8. LIMIT HOURS OF CONSTRUCTION TO BETWEEN 7:00 AM TO 6:00 PM, MONDAY THROUGH FRIDAY. CONSTRUCTION IN ALL PROJECT AREAS IS PROHIBITED ON SATURDAYS, SUNDAYS AND HOLIDAYS, AS STATED IN SECTION 220.40(E) OF THE SPECIAL PROVISIONS. SEE SECTION 00220 OF THE SPECIAL PROVISIONS FOR ALLOWABLE LANE CLOSURES.

9. THE CONTRACTOR SHALL KEEP AN APPROVED SET OF PLANS ON THE PROJECT SITE AT ALL TIMES.

10. IT IS THE CONTRACTOR'S RESPONSIBILITY TO VISIT THE SITE AND VERIFY ALL EXISTING CONDITIONS BEFORE THE START OF WORK. THE CONTRACTOR SHALL TAKE ALL NECESSARY FIELD MEASUREMENTS AND OTHERWISE VERIFY ALL DIMENSIONS AND EXISTING CONSTRUCTION CONDITIONS INDICATED AND/OR SHOWN ON THE PLANS. SHOULD ANY ERROR OR INCONSISTENCY EXIST, THE CONTRACTOR SHALL NOT PROCEED WITH THE WORK AFFECTED UNTIL REPORTED TO THE ENGINEER FOR CLARIFICATION OR CORRECTION.

11. ANY INSPECTION BY THE CITY, COUNTY, STATE, FEDERAL AGENCY OR ENGINEER SHALL NOT, IN ANY WAY, RELIEVE THE CONTRACTOR FROM ANY OBLIGATION TO PERFORM THE WORK IN COMPLIANCE WITH THE APPLICABLE CODES, REGULATIONS, CITY STANDARDS AND PROJECT CONTRACT DOCUMENTS.

12. CONTRACTOR SHALL COORDINATE ALL IMPROVEMENT LIMITS WITH THE ENGINEER ONSITE PRIOR TO BEGINNING WORK, NO PAYMENT WILL BE MADE FOR EXTRA WORK THAT IS CONSTRUCTED BEYOND THE APPROVED CONSTRUCTION LIMITS.

13. AT THE END OF EACH WORK DAY, THE CONTRACTOR SHALL CLEAN UP THE PROJECT AREA AND LEAVE IT IN A NEAT AND SECURED MANNER. UPON COMPLETION OF THE PROJECT, THE CONTRACTOR SHALL LEAVE THE PROJECT AREA FREE FROM ALL DEBRIS AND UNUSED MATERIALS.

14. PROPERTY LINES SHOWN ON PLAN SHEETS ARE APPROXIMATE AND FOR GENERAL DELINEATION PURPOSES ONLY AND ARE NOT MEANT TO REPRESENT THE ACTUAL PROPERTY BOUNDARIES.

15. THE CONTRACTOR SHALL BE SOLELY RESPONSIBLE FOR COMPLYING WITH ALL CONSTRUCTION SAFETY, HEALTH AND OTHER RULES AND REGULATIONS FROM OSHA, DEQ, STATE, AND LOCAL REGULATING AGENCIES FOR SAFETY AND INSTALLATION OF THE WORK INCLUDING, BUT NOT LIMITED TO, SHORING, BRACING, ERECTION/INSTALLATION, FALL PROTECTION, GUARDRAILS, ETC.

16. REPLACE CURBS, SIDEWALKS, AND/OR DRIVEWAY APRONS THAT ARE DAMAGED AS A RESULT OF CONSTRUCTION OPERATIONS. REPLACE FULL SECTIONS TO THE NEAREST EXISTING CONSTRUCTION JOINT. REPLACEMENT WILL BE CONSIDERED INCIDENTAL TO THE WORK.

17. ALL CONSTRUCTION SURVEY AND STAKING REQUIRED FOR THE PROJECT SHALL BE PROVIDED BY THE CONTRACTOR. THE CONTRACTOR SHALL DEVELOP AND MAKE ALL DETAIL SURVEYS NECESSARY FOR LAYOUT AND CONSTRUCTION INCLUDING EXACT COMPONENT LOCATION (SUCH AS EXISTING STRIPING, SYMBOLS, DETECTOR LOOPS, ETC), WORKING POINTS, LINES, AND ELEVATIONS. PRIOR TO CONSTRUCTION, THE FIELD LAYOUT SHALL BE REVIEWED BY THE ENGINEER. THE CONTRACTOR SHOULD ASSUME THAT ALL SURVEY STAKING IS TO BE COMPLETED USING INFORMATION CONTAINED IN THE PLANS AND SPECIFICATIONS OR FROM EXISTING ONSITE FEATURES. INFORMATION OR CLARIFICATION BY THE ENGINEER MAY BE AVAILABLE UPON REQUEST, BUT IS NOT GUARANTEED.

18. THE CONTRACTOR SHALL HAVE THE RESPONSIBILITY TO CAREFULLY PRESERVE BENCHMARKS, REFERENCE POINTS AND STAKES, AND IN THE CASE OF DESTRUCTION THEREOF BY THE CONTRACTOR RESULTING FROM ITS NEGLIGENCE, THE CONTRACTOR SHALL BE CHARGED WITH THE EXPENSE AND DAMAGE RESULTING THEREFORE AND SHALL BE RESPONSIBLE FOR ANY MISTAKES THAT MAY BE CAUSED BY THE UNNECESSARY LOSS OR DISTURBANCE OF SUCH MARKS, REFERENCE POINTS AND STAKES.

19. CONTRACTOR IS RESPONSIBLE FOR SURVEYING AND REPLACING ALL MONUMENTS DISTURBED BY PAVING OR CONCRETE WORK PURSUANT TO ORS 209.150, AND FOR PREPARING AND FILING A RECORD OF SURVEY TO THE COUNTY SURVEYOR'S OFFICE PURSUANT TO ORS 209.250.

20. COORDINATE WITH OTHER CONTRACTORS WITHIN THE PROJECT LIMITS COMPLETING WORK. IF APPLICABLE, SEE THE GENERAL CONDITIONS OF THE SPECIFICATIONS FOR CONTACT INFORMATION.

21. PROTECT FRESHLY POURED CONCRETE CURBS AND SIDEWALK FROM VANDALISM OR OTHER DAMAGE FOR A MINIMUM OF TWENTY-FOUR (24) HOURS OR UNTIL CURED ENOUGH TO SUPPORT TYPICAL USE, WHICHEVER IS LONGER. ANY CURB OR SIDEWALK DAMAGED BY VANDALISM OR OTHER CAUSES SHALL BE REPLACED AT NO COST TO THE CITY.

22. CONTRACTOR SHALL RESTORE ALL DISTURBED LANDSCAPING AND IRRIGATION. PLACE TOPSOIL, AGGREGATE, AND/OR BARK MULCH WHERE SHOWN.

23. FURNISH AND PLACE DOWELS TO JOIN NEW CONCRETE WALKS, CURBS AND DRIVEWAYS TO EXISTING CONCRETE AS DIRECTED.

24. LIMIT THE TIME ANY ADA RAMP IS CLOSED TO 10 CALENDAR DAYS.

EROSION CONTROL NOTES

1. ALL EROSION AND SEDIMENT CONTROL MEASURES ARE TO BE PLACED PRIOR TO ANY DISTURBANCE CAUSED BY GRADING AND SHALL CONFORM TO THE REQUIREMENTS OF STATE AND FEDERAL REGULATIONS AND TO THE SPECIFIC REQUIREMENTS CONTAINED IN THE SPECIFICATIONS.

2. EXISTING INLETS AND CATCH BASINS THAT MAY RECEIVE RUNOFF FROM THE PROJECT AREA ARE TO BE PROTECTED PRIOR TO CONSTRUCTION. ALL INLETS AND CATCH BASINS ARE TO BE PROTECTED IN ACCORDANCE WITH ODOT/APWA STANDARDS FOR EROSION AND SEDIMENT CONTROL.

3. IN THE EVENT OF ANY EROSION CONTROL MEASURE FAILURE, IMMEDIATE ACTION SHALL BE TAKEN TO REPAIR, REPLACE, OR CONSTRUCT ADDITIONAL MEASURES AS REQUIRED TO ENSURE ADEQUATE EROSION CONTROL PROTECTION.

4. ALL EROSION CONTROL MEASURES SHALL BE INSPECTED REGULARLY, PARTICULARLY DURING AND AFTER STORM EVENTS, TO ENSURE ADEQUATE PERFORMANCE. MAINTENANCE AND INSPECTION LOGS SHALL REMAIN ON SITE AND SHALL BE AVAILABLE TO THE CITY OF ROSEBURG UPON REQUEST.

5. ALL PESTICIDES, PETROLEUM PRODUCTS, CHEMICALS OR OTHER POTENTIAL POLLUTANTS SHALL BE ADMINISTERED RESPONSIBLY WITH DISPOSAL AND SPILLS HANDLED IN ACCORDANCE WITH ALL LOCAL STATE AND FEDERAL REQUIREMENTS.

PAVING NOTES

1. TRIM VEGETATION AS NEEDED PRIOR TO PAVING TO ENSURE ALL VEGETATION IS CLEAR OF PAVING OPERATIONS.

2. ALL EDGES REMAINING AFTER COLD PLANE PAVEMENT REMOVAL, IF APPLICABLE, SHALL BE VERTICAL TO ACCEPT THE SUCCEEDING FULL DEPTH ASPHALT LIFT

3. ALL JOINTS BETWEEN NEW ASPHALTIC CONCRETE AND EXISTING OR NEW ASPHALTIC CONCRETE AND CONCRETE SHALL BE TACKED AND SAND SEALED.

4. PROVIDE MINOR ADJUSTMENTS IN GRADE OF NEW A.C. AS REQUIRED TO FACILITATE DRAINAGE INTO STORM DRAINAGE FACILITIES. NO PONDING SHALL OCCUR BETWEEN CATCH BASINS FOLLOWING CONSTRUCTION.

5. THE MAXIMUM EXPOSURE AT DRIVEWAYS SHALL BE 3/4-INCH.

6. WHERE PAVEMENT IS TO BE REPLACED TO MATCH EXISTING GRADE ADJACENT TO EXISTING CURB CONTRACTOR SHALL MARK EXISTING CURB FLOW LINE WITH PAINT PRIOR TO A.C. SURFACING REMOVAL.

7. COORDINATE WITH CITY STAFF FOR IN-GROUND VALVE, MANHOLE OR VAULT ADJUSTMENT OF FRANCHISE UTILITY ASSETS.

TRAFFIC CONTROL NOTES

1. TRAFFIC CONTROL/DETOUR PLANS SHALL BE PREPARED BY THE CONTRACTOR. THE DRAFT CONCEPT TRAFFIC CONTROL PLAN MUST BE APPROVED BY THE CITY PRIOR TO THE PRE-CONSTRUCTION CONFERENCE. THIS PLAN DOES NOT RELIEVE THE CONTRACTOR FROM SUBMITTING DETAILED TRAFFIC CONTROL PLANS AS REQUIRED DURING CONSTRUCTION.

2. THE CONTRACTOR SHALL PROVIDE TEMPORARY PROTECTION AND DIRECTION OF TRAFFIC IN ACCORDANCE WITH THE MANUAL OF UNIFORM TRAFFIC CONTROL DEVICES, ODOT STANDARD DRAWINGS, ODOT STANDARD SPECIFICATIONS, AND CONTRACT SPECIAL PROVISIONS.

3. USE TEMPORARY PAVEMENT MARKERS, BARRIERS, BARRICADES, AND SIGNS AS REQUIRED TO SAFELY DETOUR PEDESTRIAN AND VEHICULAR TRAFFIC AROUND CONSTRUCTION. LABEL TYPE AND LOCATION FOR ALL ITEMS ON TRAFFIC CONTROL PLANS.

4. APPROPRIATE METHODS OF PEDESTRIAN AND VEHICULAR TRAFFIC CONTROL, INCLUDING FLAGGERS, SHALL BE EMPLOYED BY THE CONTRACTOR TO THE EXTENT DEEMED NECESSARY BY THE TRAFFIC CONTROL SUPERVISOR AND AS APPROVED BY THE CITY AND THE ENGINEER TO PROTECT WORKERS OR THIRD PARTIES AND SAFELY ACCOMMODATE TRAFFIC THROUGH THE WORK ZONE.

5. THE CONTRACTOR SHALL COORDINATE ACCESS TO DRIVEWAYS WITH PROPERTY OWNERS. ACCESS TO ROADWAY APPROACHES WITHIN THE PROJECT LIMITS SHALL BE MAINTAINED AT ALL TIMES. TRAFFIC PLATES SHALL BE USED, AND SECURED IN A MANNER ACCEPTABLE TO THE CITY, ACROSS ALL TRENCHES BLOCKING DRIVEWAYS TO PROVIDE ACCESS AT ALL TIMES. AT NO TIME SHALL CONTRACTORS DETAIN OR DELAY EMERGENCY VEHICLES.

6. THE CONTRACTOR SHALL COORDINATE ACCESS FOR SERVICES INCLUDING, BUT NOT LIMITED TO, MAIL DELIVERY, TRASH PICKUP, SCHOOL TRANSPORTATION, AND ANY OTHER SPECIAL TRANSPORTATION SERVICES THAT EXIST WITHIN THE PROJECT AREA.

7. EXISTING SIGNS THAT CONFLICT WITH CONSTRUCTION SIGNING SHALL BE COVERED OR REMOVED DURING CONSTRUCTION AND REPLACED AFTER CONSTRUCTION.

8. PROVIDE ACP WEDGES FOR LONGITUDINAL AND TRANSVERSE JOINTS ACCORDING TO 00620.40(d), 00744.44 AND 00744.45.


9. THE CONTRACTOR SHALL PROVIDE SAFE, STABLE, AND ACCESSIBLE ACCESS TO ALL DRIVEWAY AND PEDESTRIAN PATHS CONNECTING TO FRONT DOORS AT ALL TIMES. TEMPORARY INTERRUPTIONS IN ACCESS SHALL BE COORDINATED BY THE CONTRACTOR WITH THE PROPERTY OWNER OR OCCUPANT AS REQUIRED.

10. CONTRACTOR SHALL FURNISH PORTABLE CHANGEABLE MESSAGE SIGN AT WORK ZONES ON ARTERIAL ROADS IN ACCORDANCE WITH THE SPECIFICATIONS.


11. COLD PLANE PAVEMENT REMOVAL, IF APPLICABLE, SHALL BE COMPLETED ON THE SAME SHIFT AS THE PERMANENT ASPHALT PAVEMENT WEARING COURSE.



SCALE **DESIGNED:** REVISION DATE BY J. JENKINS AS SHOWN PLAN DRAWN: HORIZ. CWE CAD **PROFILE** CHECKED: VERT. R. VOORHIES ONE INCH (REF) CWE PROJECT NO. 40193.018.01

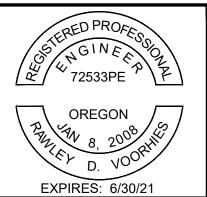



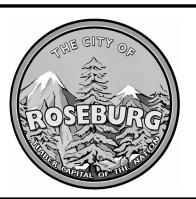

900 SE DOUGLAS AVE. **ROSEBURG, OR 97470**


CITY PROJECT #: 21PW01 PH 1 **CITY PROJECT MANAGER** RICK CASTLE


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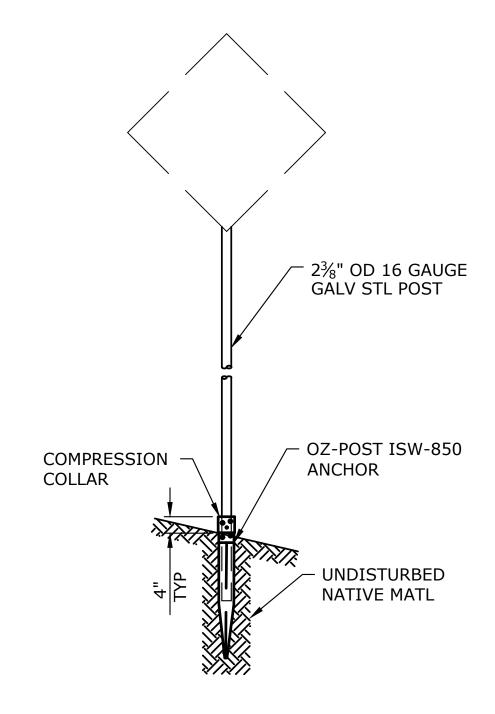
LINCOLN STREET CURB RAMP IMPROVEMENTS **FEBRUARY 2021**

SHEET NO.

G-03



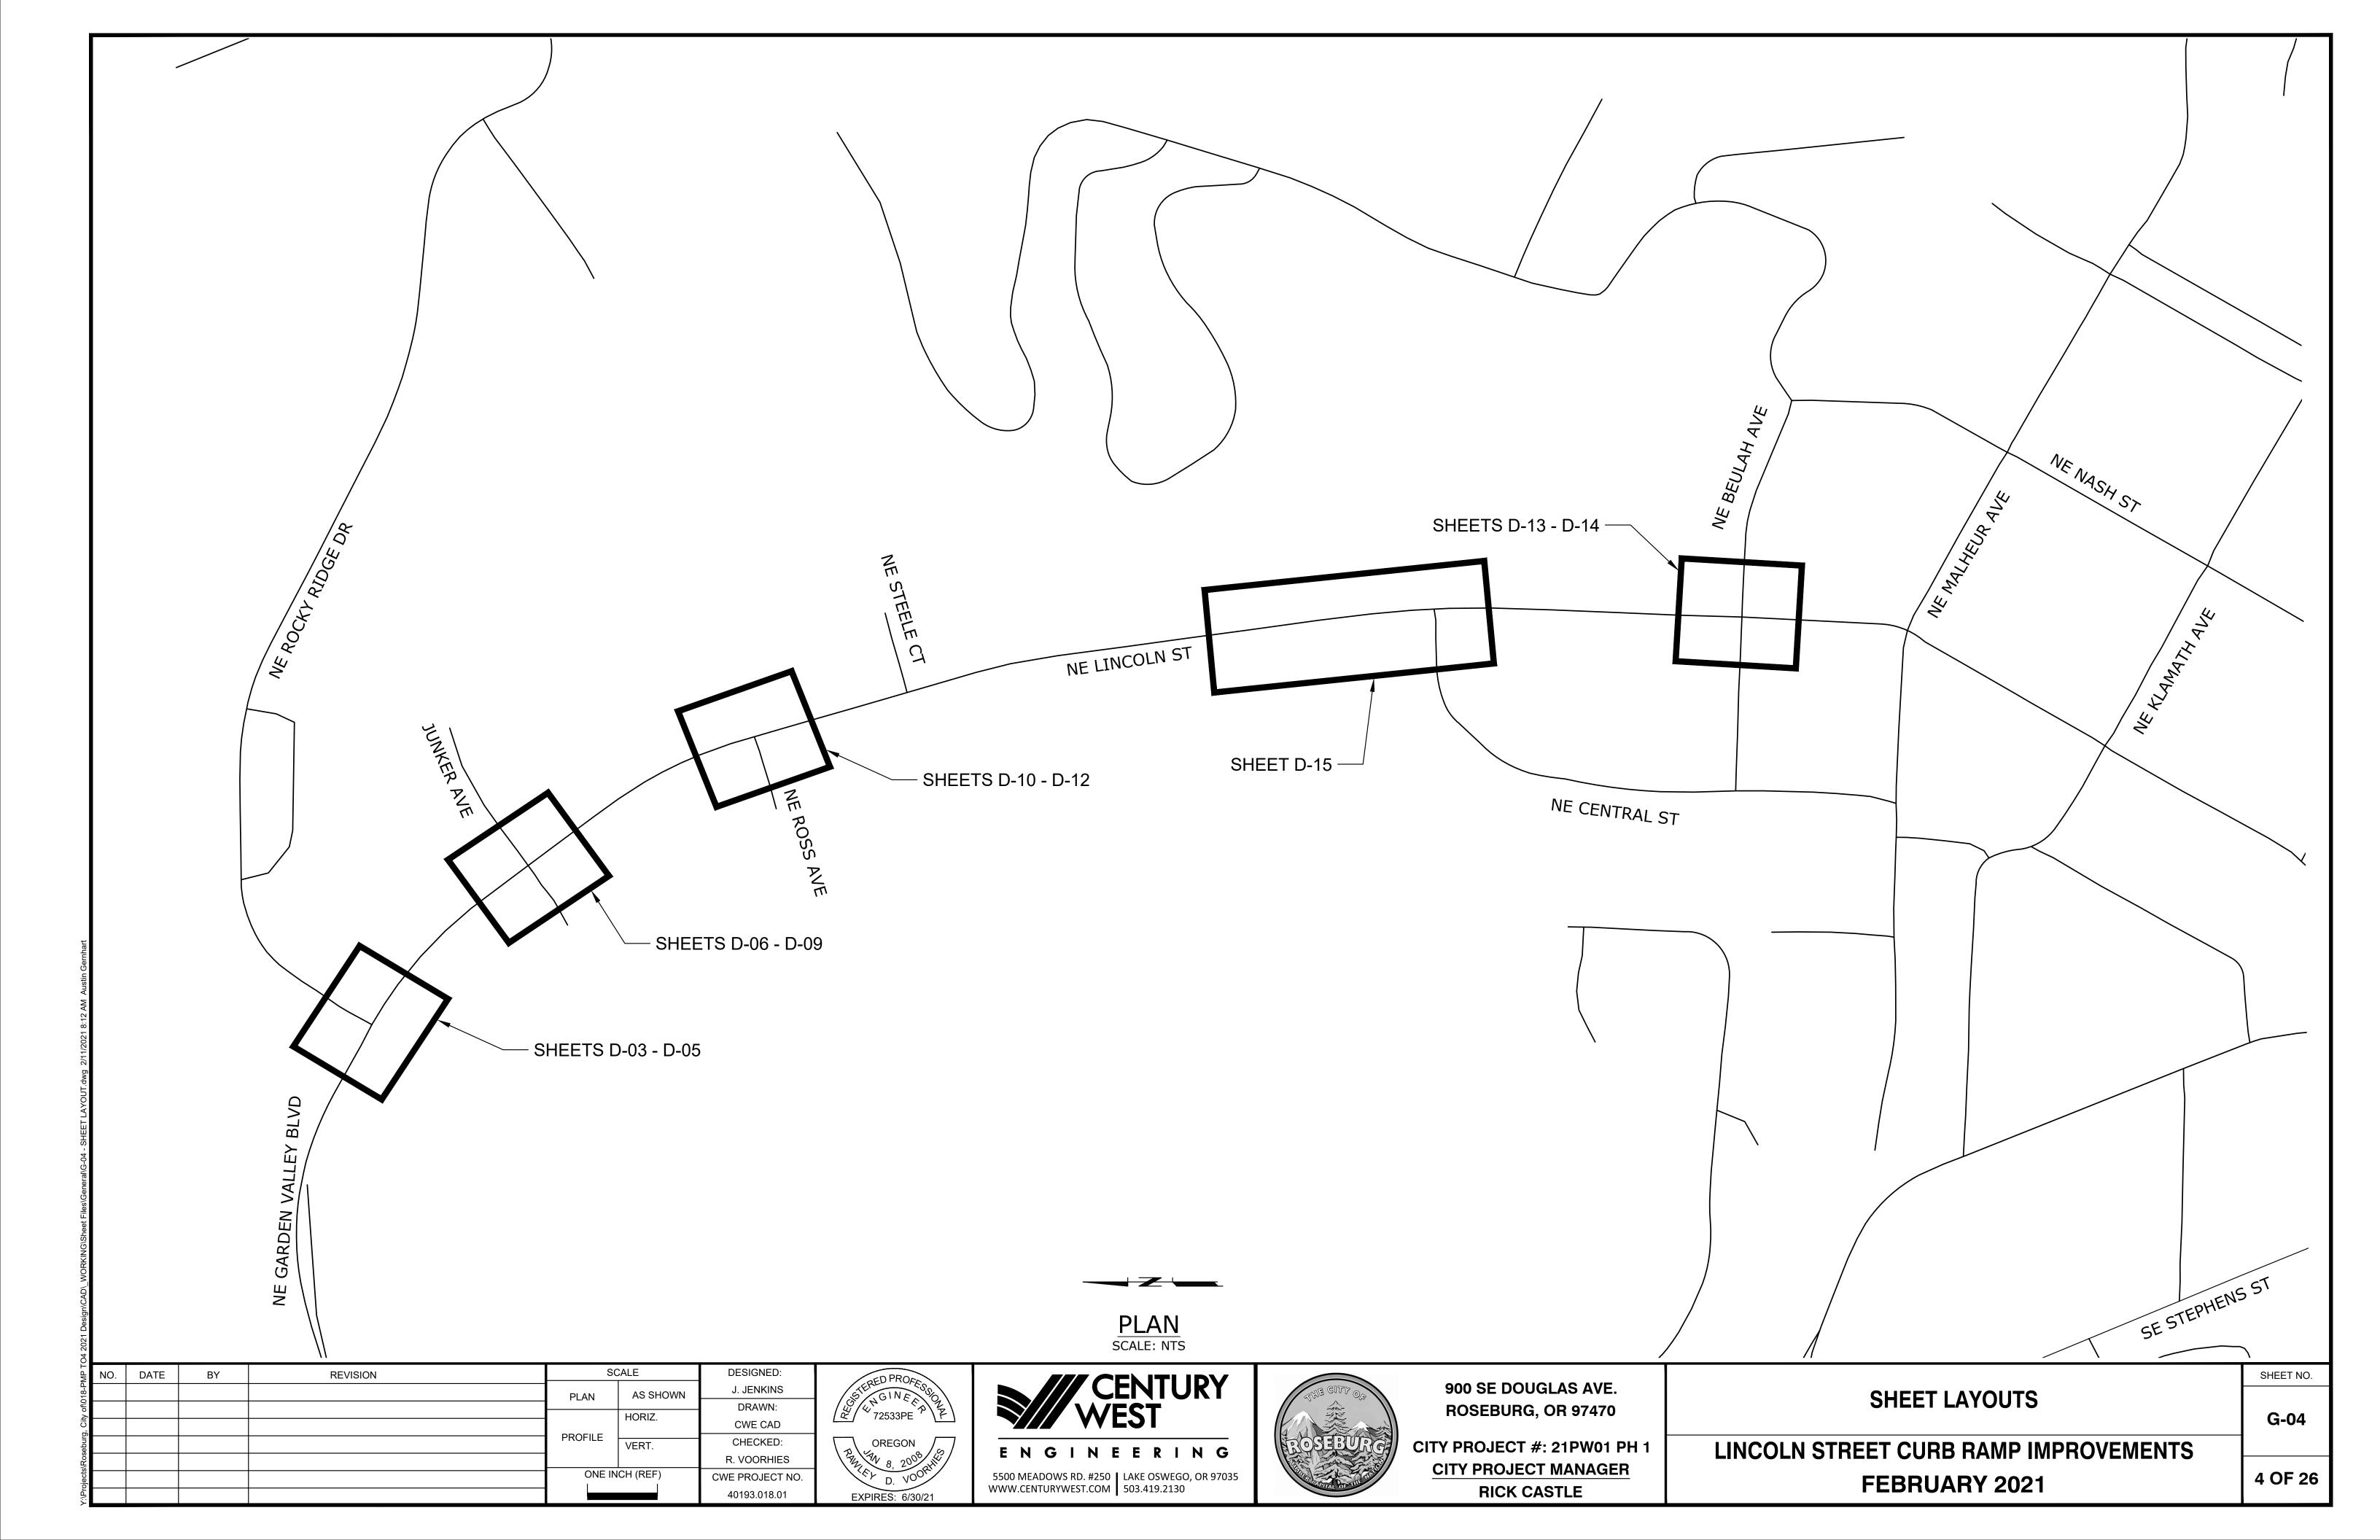

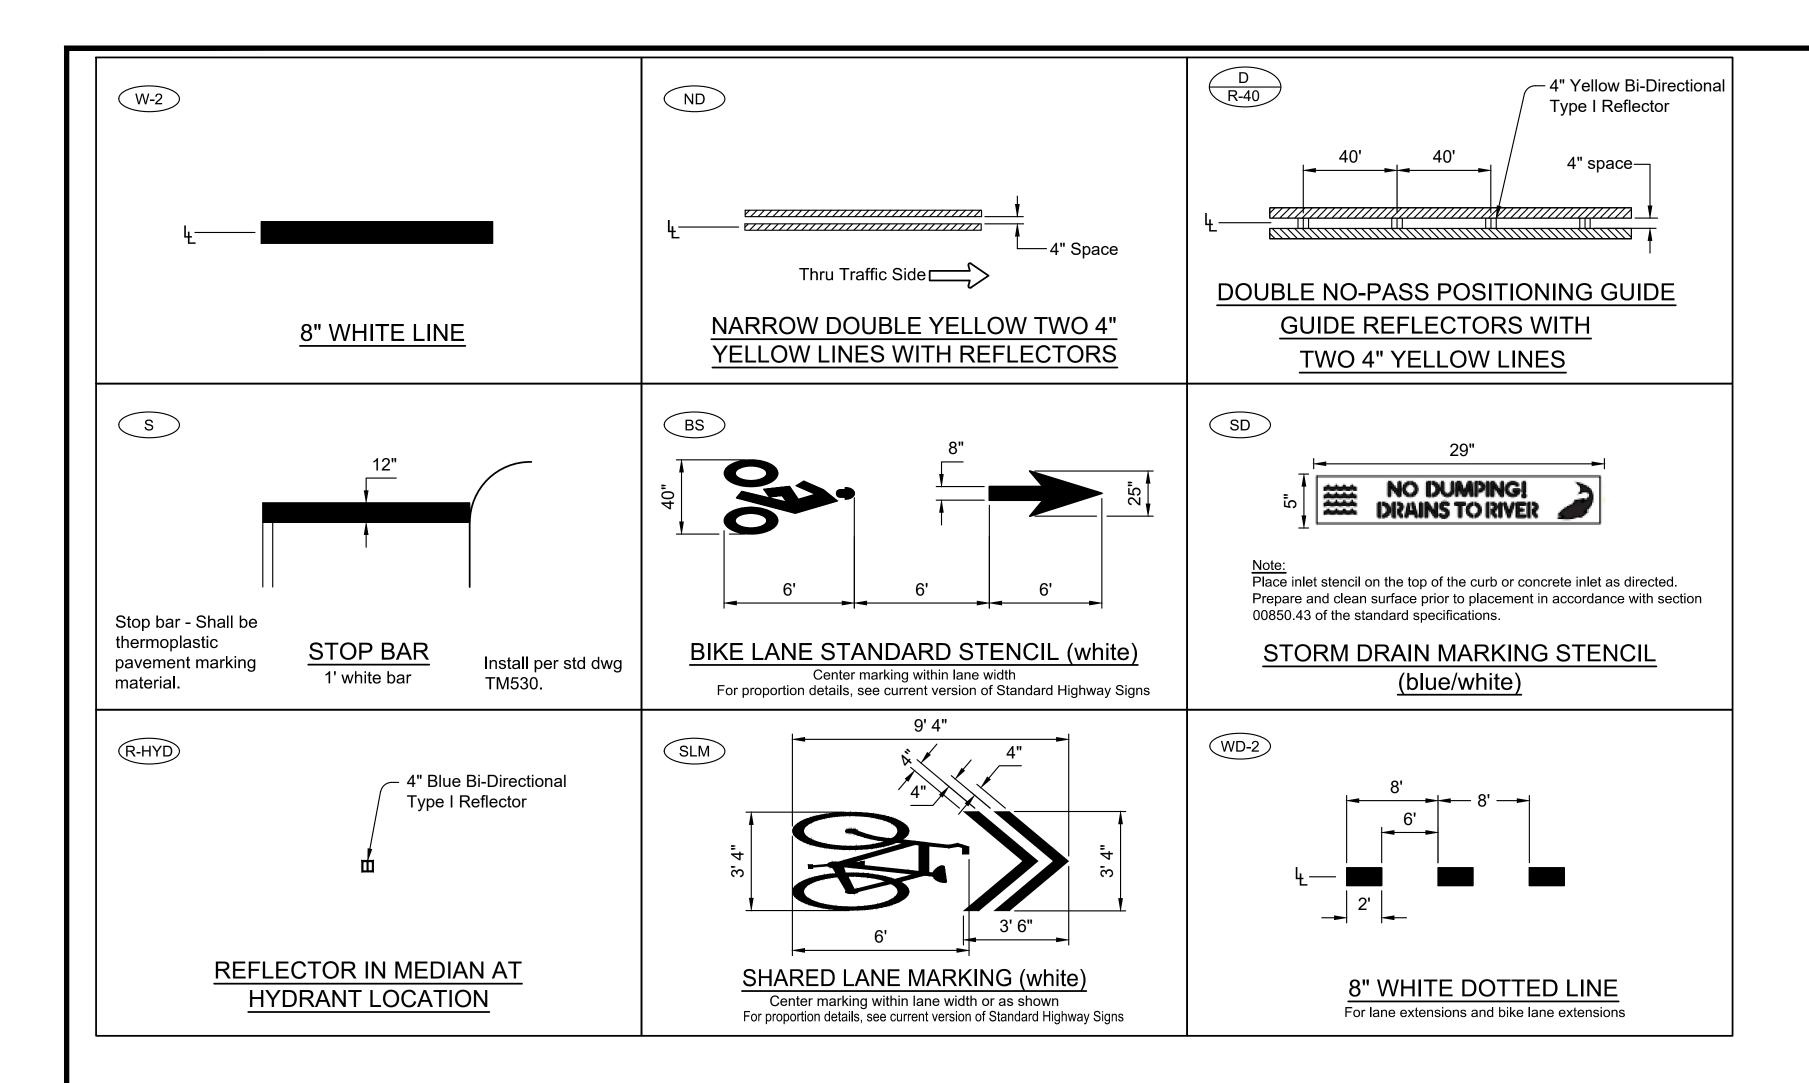



"BIKE LANE ENDS" SIGN (3)

SIGN SUPPORT SCALE: NTS

NOTES:

- 1. INSTALL ANCHOR AND POST PER MANUFACTURER'S RECOMMENDATION.
- 2. FOR HORIZONTAL AND VERTICAL CLEARANCES OF PERMANENT SIGNS, REFER TO ODOT STANDARD DRAWING TM200. COORDINATE FINAL LOCATION WITH ENGINEER IN FIELD.

\D-01,

3. ATTACH SIGNS PER ODOT STANDARD DRAWING TM677.



SCALE: NTS

R3-17 30x24


R3-17bP

30x12

30x12

AHEAD

"BIKE LANE AHEAD" SIGN SCALE: NTS

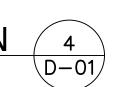

STRIPING AND SIGNING NOTES


1. ALL SIGNING AND PAVEMENT MARKING MATERIAL AND WORKMANSHIP SHALL CONFORM TO THE REQUIREMENTS AND SPECIFICATIONS OF THE MANUAL ON UNIFORM TRAFFIC CONTROL DEVICES (MUTCD), AND 2018 APWA STANDARD SPECIFICATIONS.

2. LOCATIONS SHOWN FOR EXISTING SIGNS AND PAVEMENT MARKINGS ARE APPROXIMATE. CONTRACTOR SHALL REPLACE EXISTING PAVEMENT MARKINGS WITH SAME SIZE, STYLE AND LOCATION, UNLESS OTHERWISE SPECIFIED. ALL TRAFFIC SIGN POSITIONS AND PAVEMENT MARKINGS LAYOUT SHALL BE REVIEWED IN THE FIELD BY THE ENGINEER PRIOR TO INSTALLATION.


- 3. ALL LONGITUDINAL STRIPING SHALL BE PAINT. TRANSVERSE PAVEMENT MARKINGS, INCLUDING CROSSWALKS, STOP BARS, BIKE SYMBOLS, ARROWS, AND STORM INLET MARKINGS, SHALL BE PREFORMED THERMOPLASTIC AS SHOWN AND SPECIFIED. CONTRACTOR IS RESPONSIBLE FOR LAYOUT AND STAKING OF ALL TRANSVERSE PAVEMENT MARKINGS.
- 4. CONTRACTOR SHALL FIELD VERIFY AND DOCUMENT ALL EXISTING STRIPING BY SURVEYING, OR OTHER APPROVED METHOD, PRIOR TO CONSTRUCTION OF IMPROVEMENTS. RESTRIPE TO MATCH EXISTING LAYOUT UNLESS OTHERWISE INDICATED ON THE PLANS.
- 5. TEMPORARY FLEXIBLE PAVEMENT MARKERS ARE ALLOWED PRIOR TO STRIPING FOR A MAXIMUM PERIOD OF 14 CALENDAR DAYS.
- 6. CONTRACTOR SHALL OBTAIN CITY APPROVAL OF STRIPING LAYOUT 24 HOURS BEFORE STRIPING.
- 7. LANE DIMENSIONS SHALL BE MEASURED FROM CENTER OF STRIPE OR FROM EDGE OF PAVEMENT OR CURB TO CENTER OF STRIPE.

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5500 MEADOWS RD. #250 | LAKE OSWEGO, OR 97035 | WWW.CENTURYWEST.COM | 503.419.2130

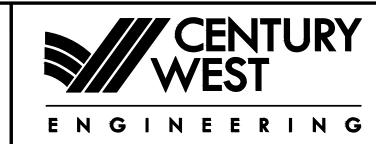

900 SE DOUGLAS AVE. **ROSEBURG, OR 97470**

CITY PROJECT #: 21PW01 PH 1 CITY PROJECT MANAGER **RICK CASTLE**

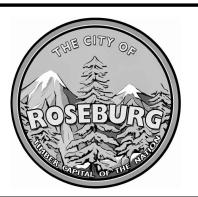
SIGNING & STRIPING DETAILS

LINCOLN STREET CURB RAMP IMPROVEMENTS **FEBRUARY 2021**

5 OF 26


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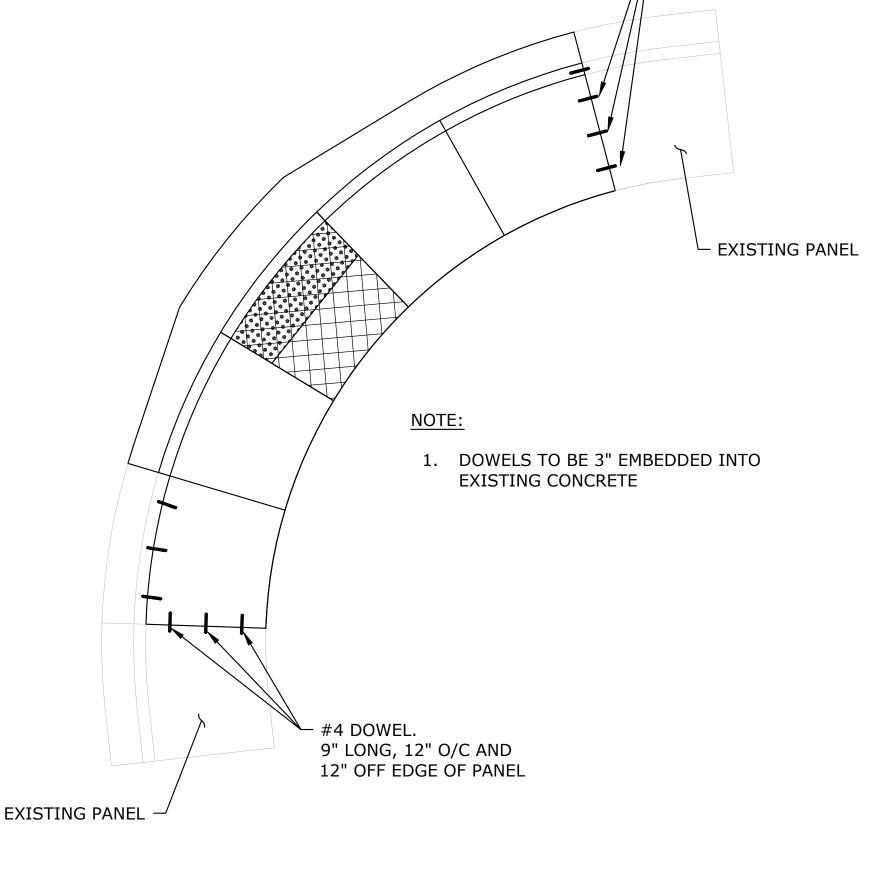
D-01

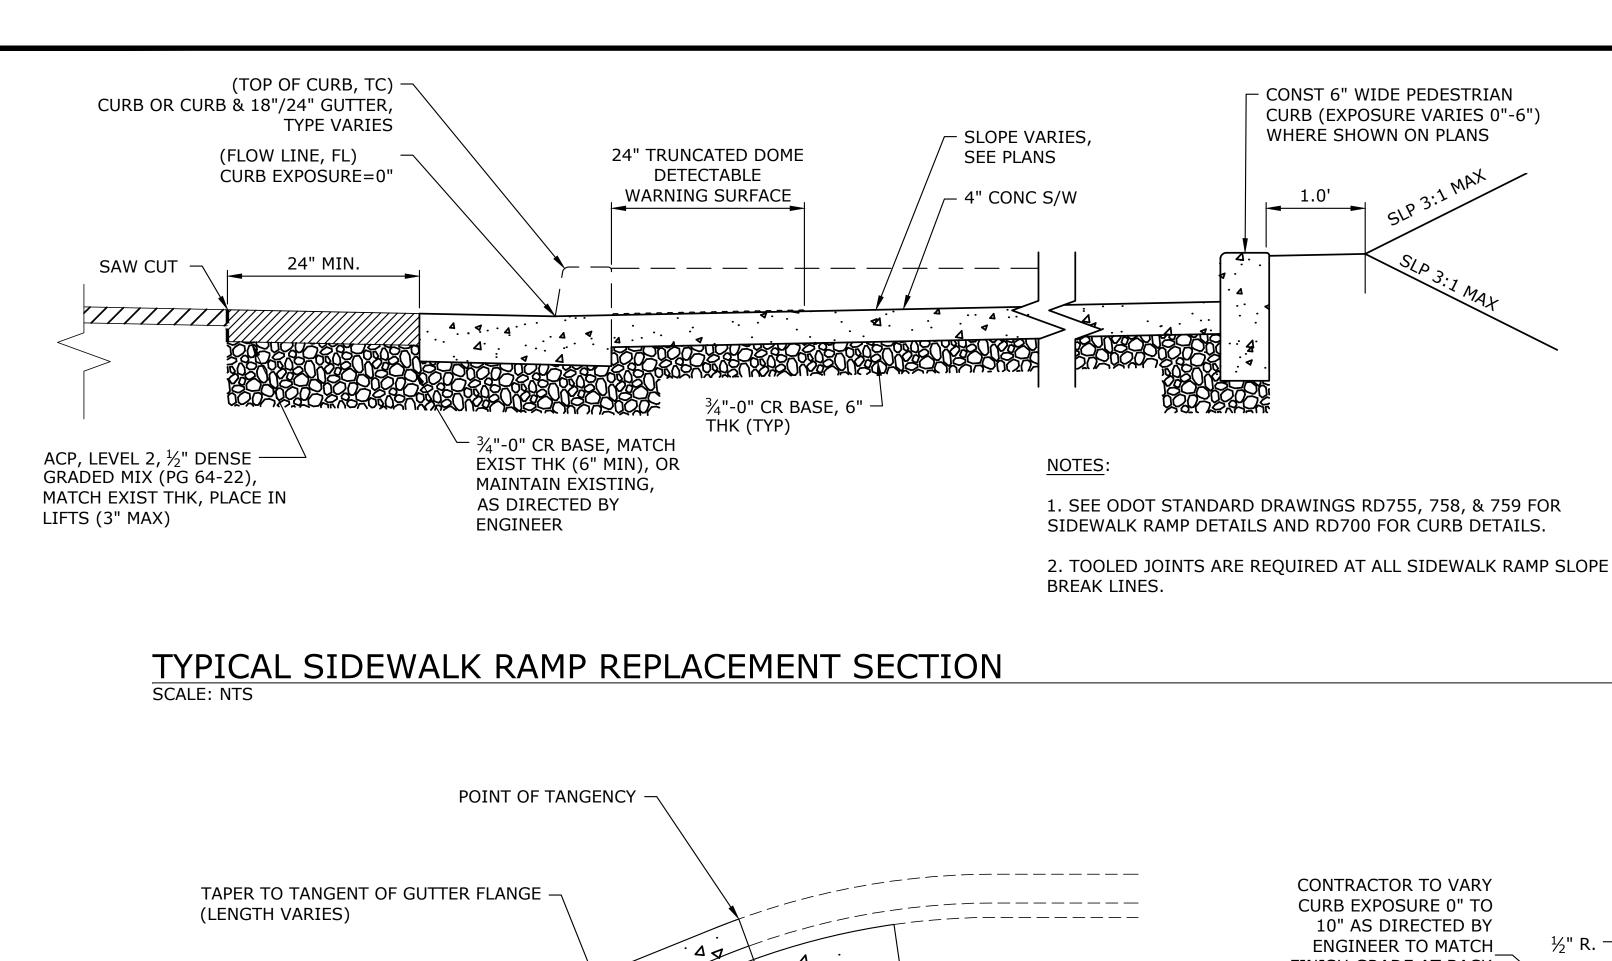

SIDEWALK RAMP GENERAL NOTES

- 1. CONTRACTOR SHALL BE RESPONSIBLE FOR MEETING ALL AMERICANS WITH DISABILITIES (ADA) REQUIREMENTS AS DEFINED BY THE PUBLIC RIGHTS-OF-WAY ACCESSIBILITY GUIDELINES (PROWAG). DETAILS AND DIMENSIONS SHOWN ARE APPROXIMATE ONLY AND INTENDED AS A GUIDE FOR INITIAL LAYOUT PURPOSES ONLY AND ARE NOT COMPLETE. CONTRACTOR SHALL TAKE ALL NECESSARY FIELD MEASUREMENTS AND OTHERWISE VERIFY ALL DIMENSIONS TO MEET ADA REQUIREMENTS. SHOULD ANY ERROR OR INCONSISTENCY EXIST, THE CONTRACTOR SHALL NOT PROCEED WITH THE WORK AFFECTED UNTIL REPORTED TO THE ENGINEER FOR CLARIFICATION OR CORRECTION.
- 2. COMPLETE SIDEWALK CONSTRUCTION PRIOR TO FINAL PAVING OF STREET.
- 3. ALL SURVEY AND STAKING NECESSARY FOR CONSTRUCTION SHALL BE PROVIDED BY THE CONTRACTOR. THE CONTRACTOR SHALL DEVELOP AND MAKE ALL DETAIL SURVEYS NECESSARY FOR LAYOUT AND CONSTRUCTION. COMPLETE ALL SURVEY STAKING AS NEEDED USING INFORMATION CONTAINED IN THE PLANS AND ADJUSTED AS NECESSARY TO MEET ADA REQUIREMENTS. ADDITIONAL INFORMATION OR CLARIFICATION BY THE ENGINEER MAY BE AVAILABLE UPON REQUEST, BUT IS NOT GUARANTEED. SURVEYED FIELD LAYOUT SHALL BE REVIEWED BY THE ENGINEER PRIOR TO DEMOLITION AND AGAIN PRIOR TO CONCRETE PLACEMENT.
- 4. THE MAXIMUM CLOSURE TIME FOR ANY SINGLE CURB RAMP SHALL BE 10 CALENDAR DAYS. SUBMIT TRAFFIC CONTROL PLAN AND PEDESTRIAN DETOUR PLAN FOR RAMP CLOSURES. PLAN SHALL INCLUDE, BUT IS NOT LIMITED TO, WORK AREA PROTECTION, SIDEWALK CLOSURES AND DETOURS.



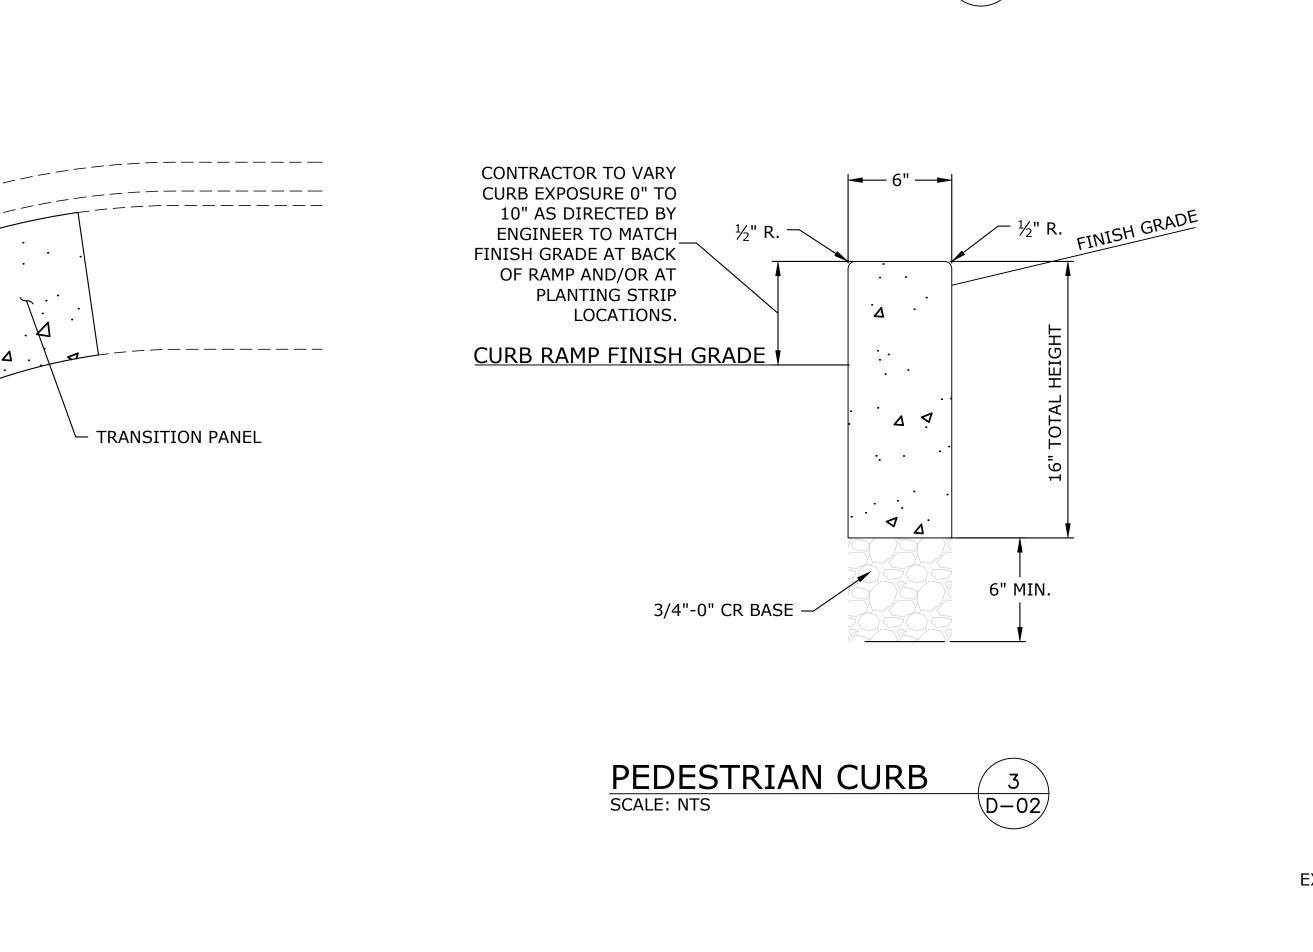



2' GUTTER AT CURB RAMP LANDING/THROAT

- TRANSITION PANEL

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2' WIDE GUTTER FLANGE AT CURB

RAMP LANDING/THROAT

POINT OF TANGENCY


EXISTING CURB AND -

GUTTER





D-02

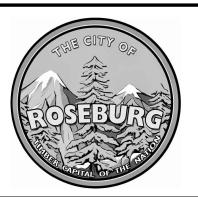

900 SE DOUGLAS AVE. ROSEBURG, OR 97470

CITY PROJECT #: 21PW01 PH 1

CITY PROJECT MANAGER

RICK CASTLE

DETAILS


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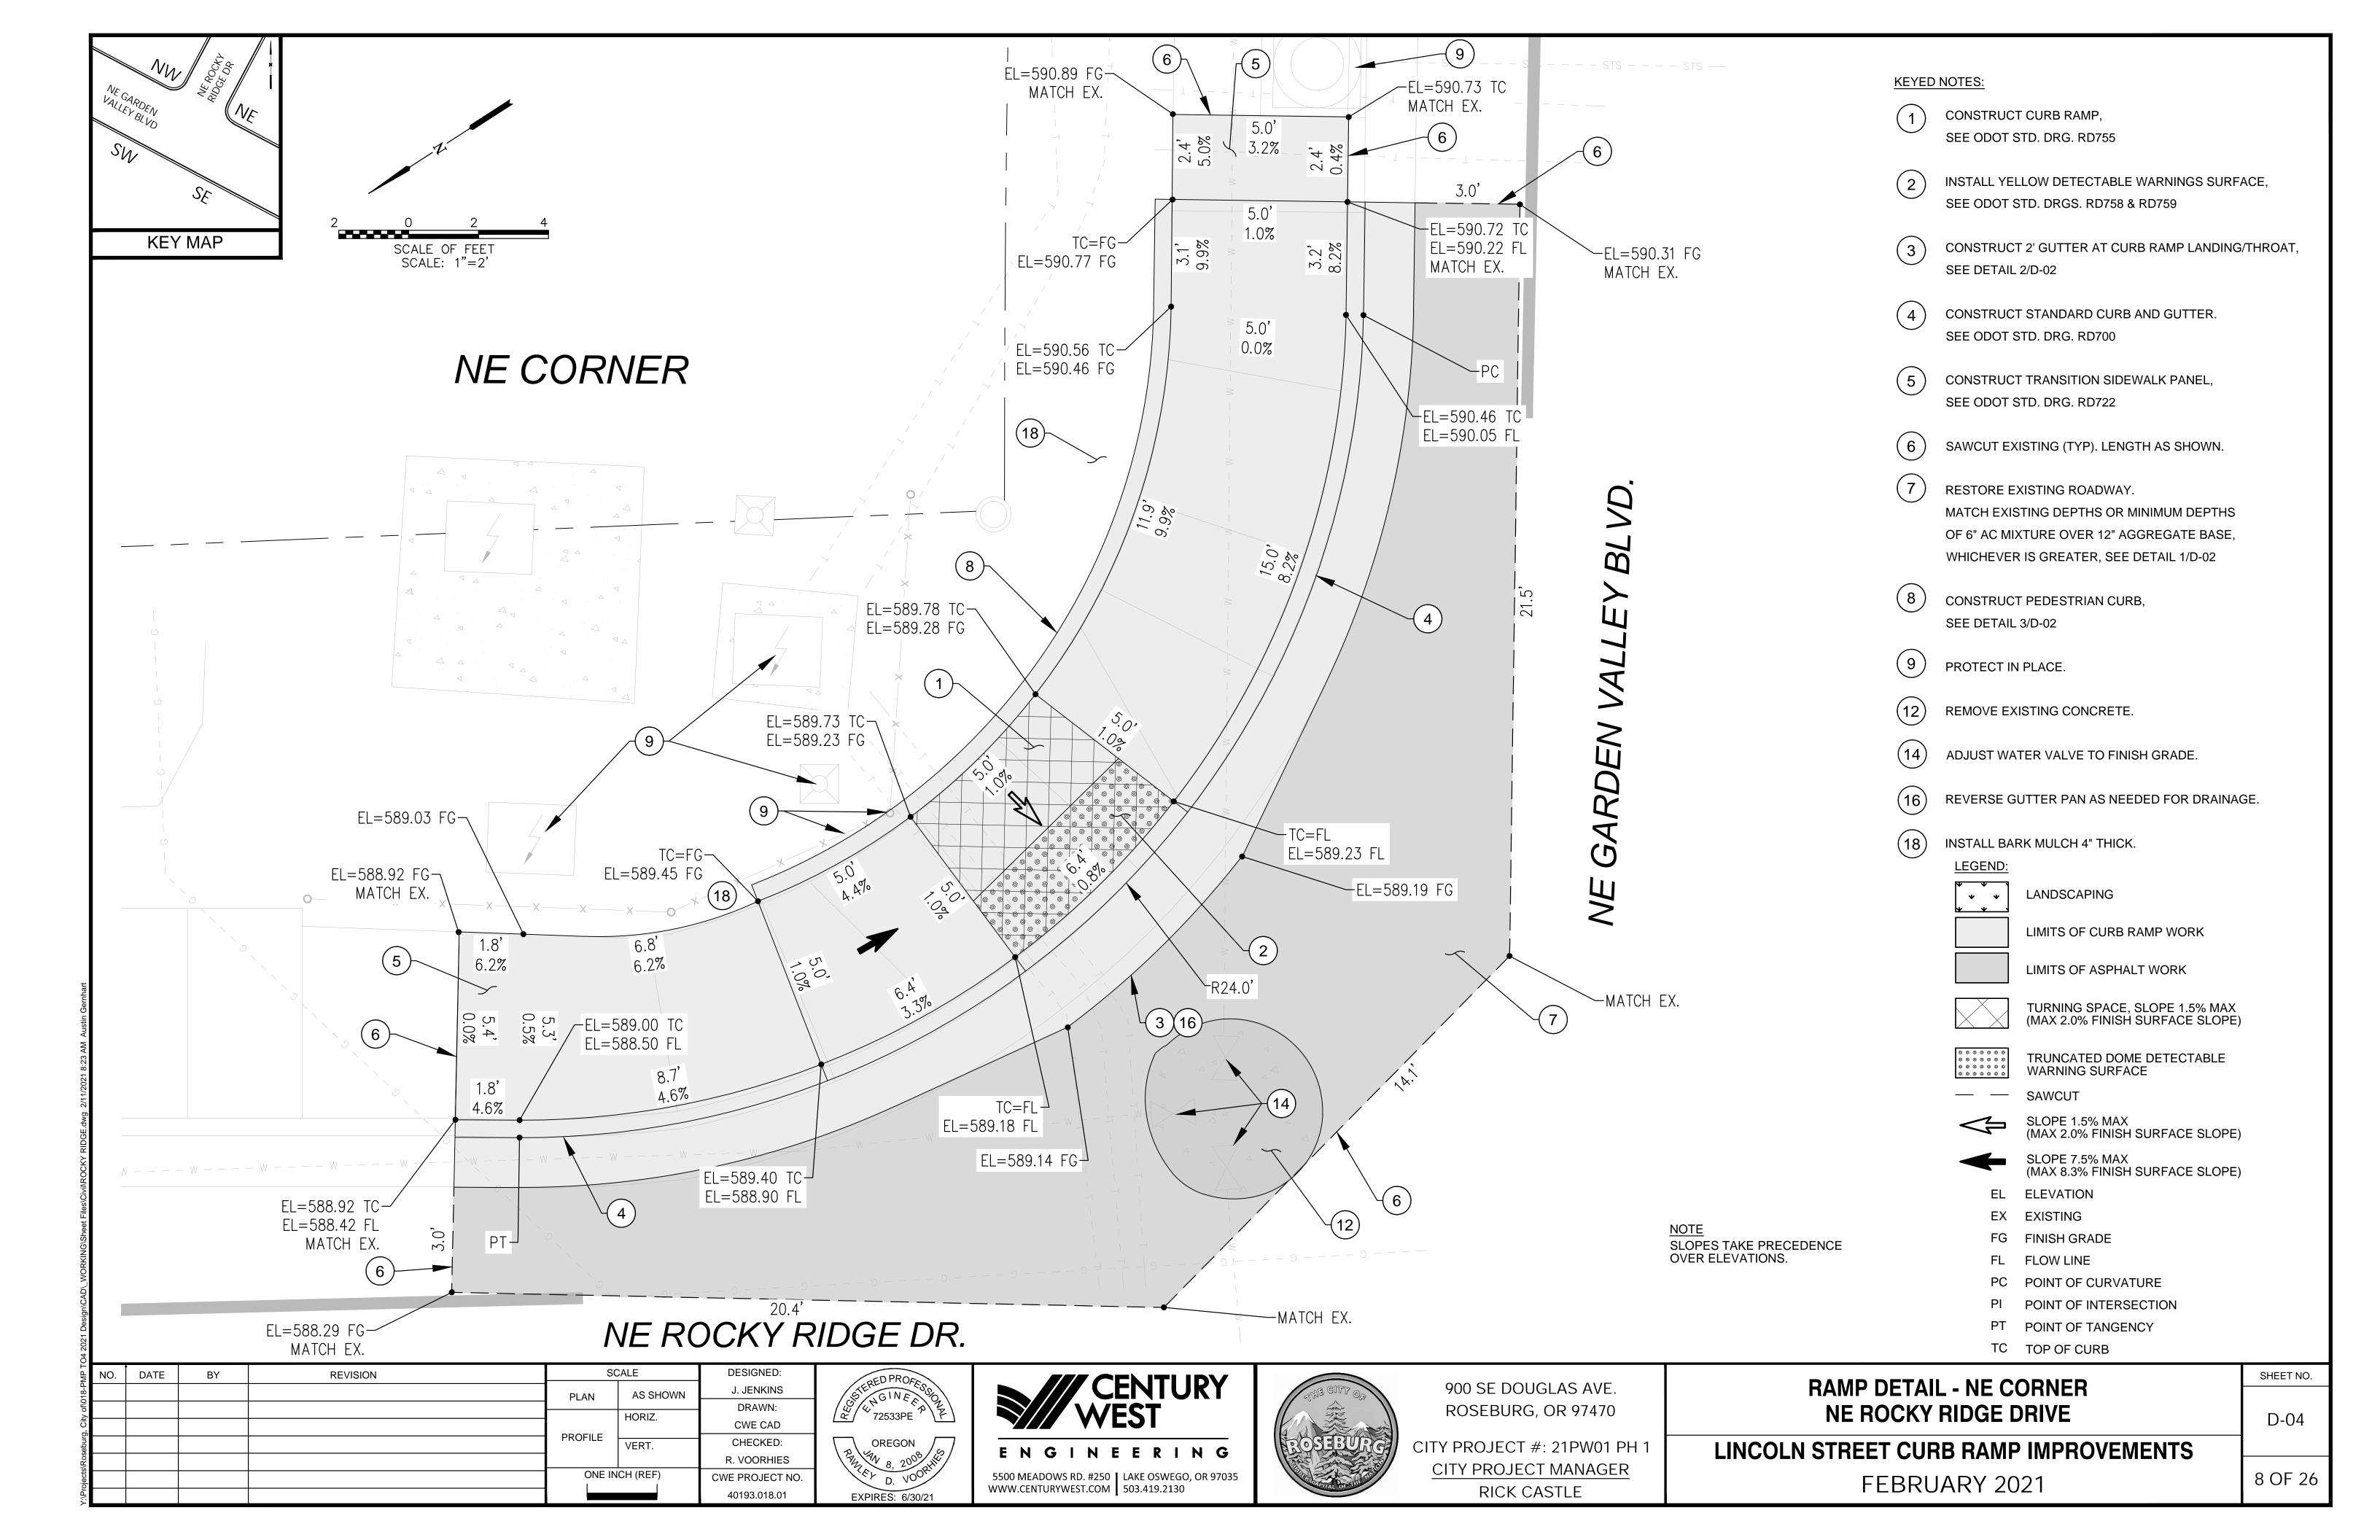
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9" LONG, 12" O/C AND
12" OFF EDGE OF PANEL


LINCOLN STREET CURB RAMP IMPROVEMENTS
FEBRUARY 2021


6 OF 26


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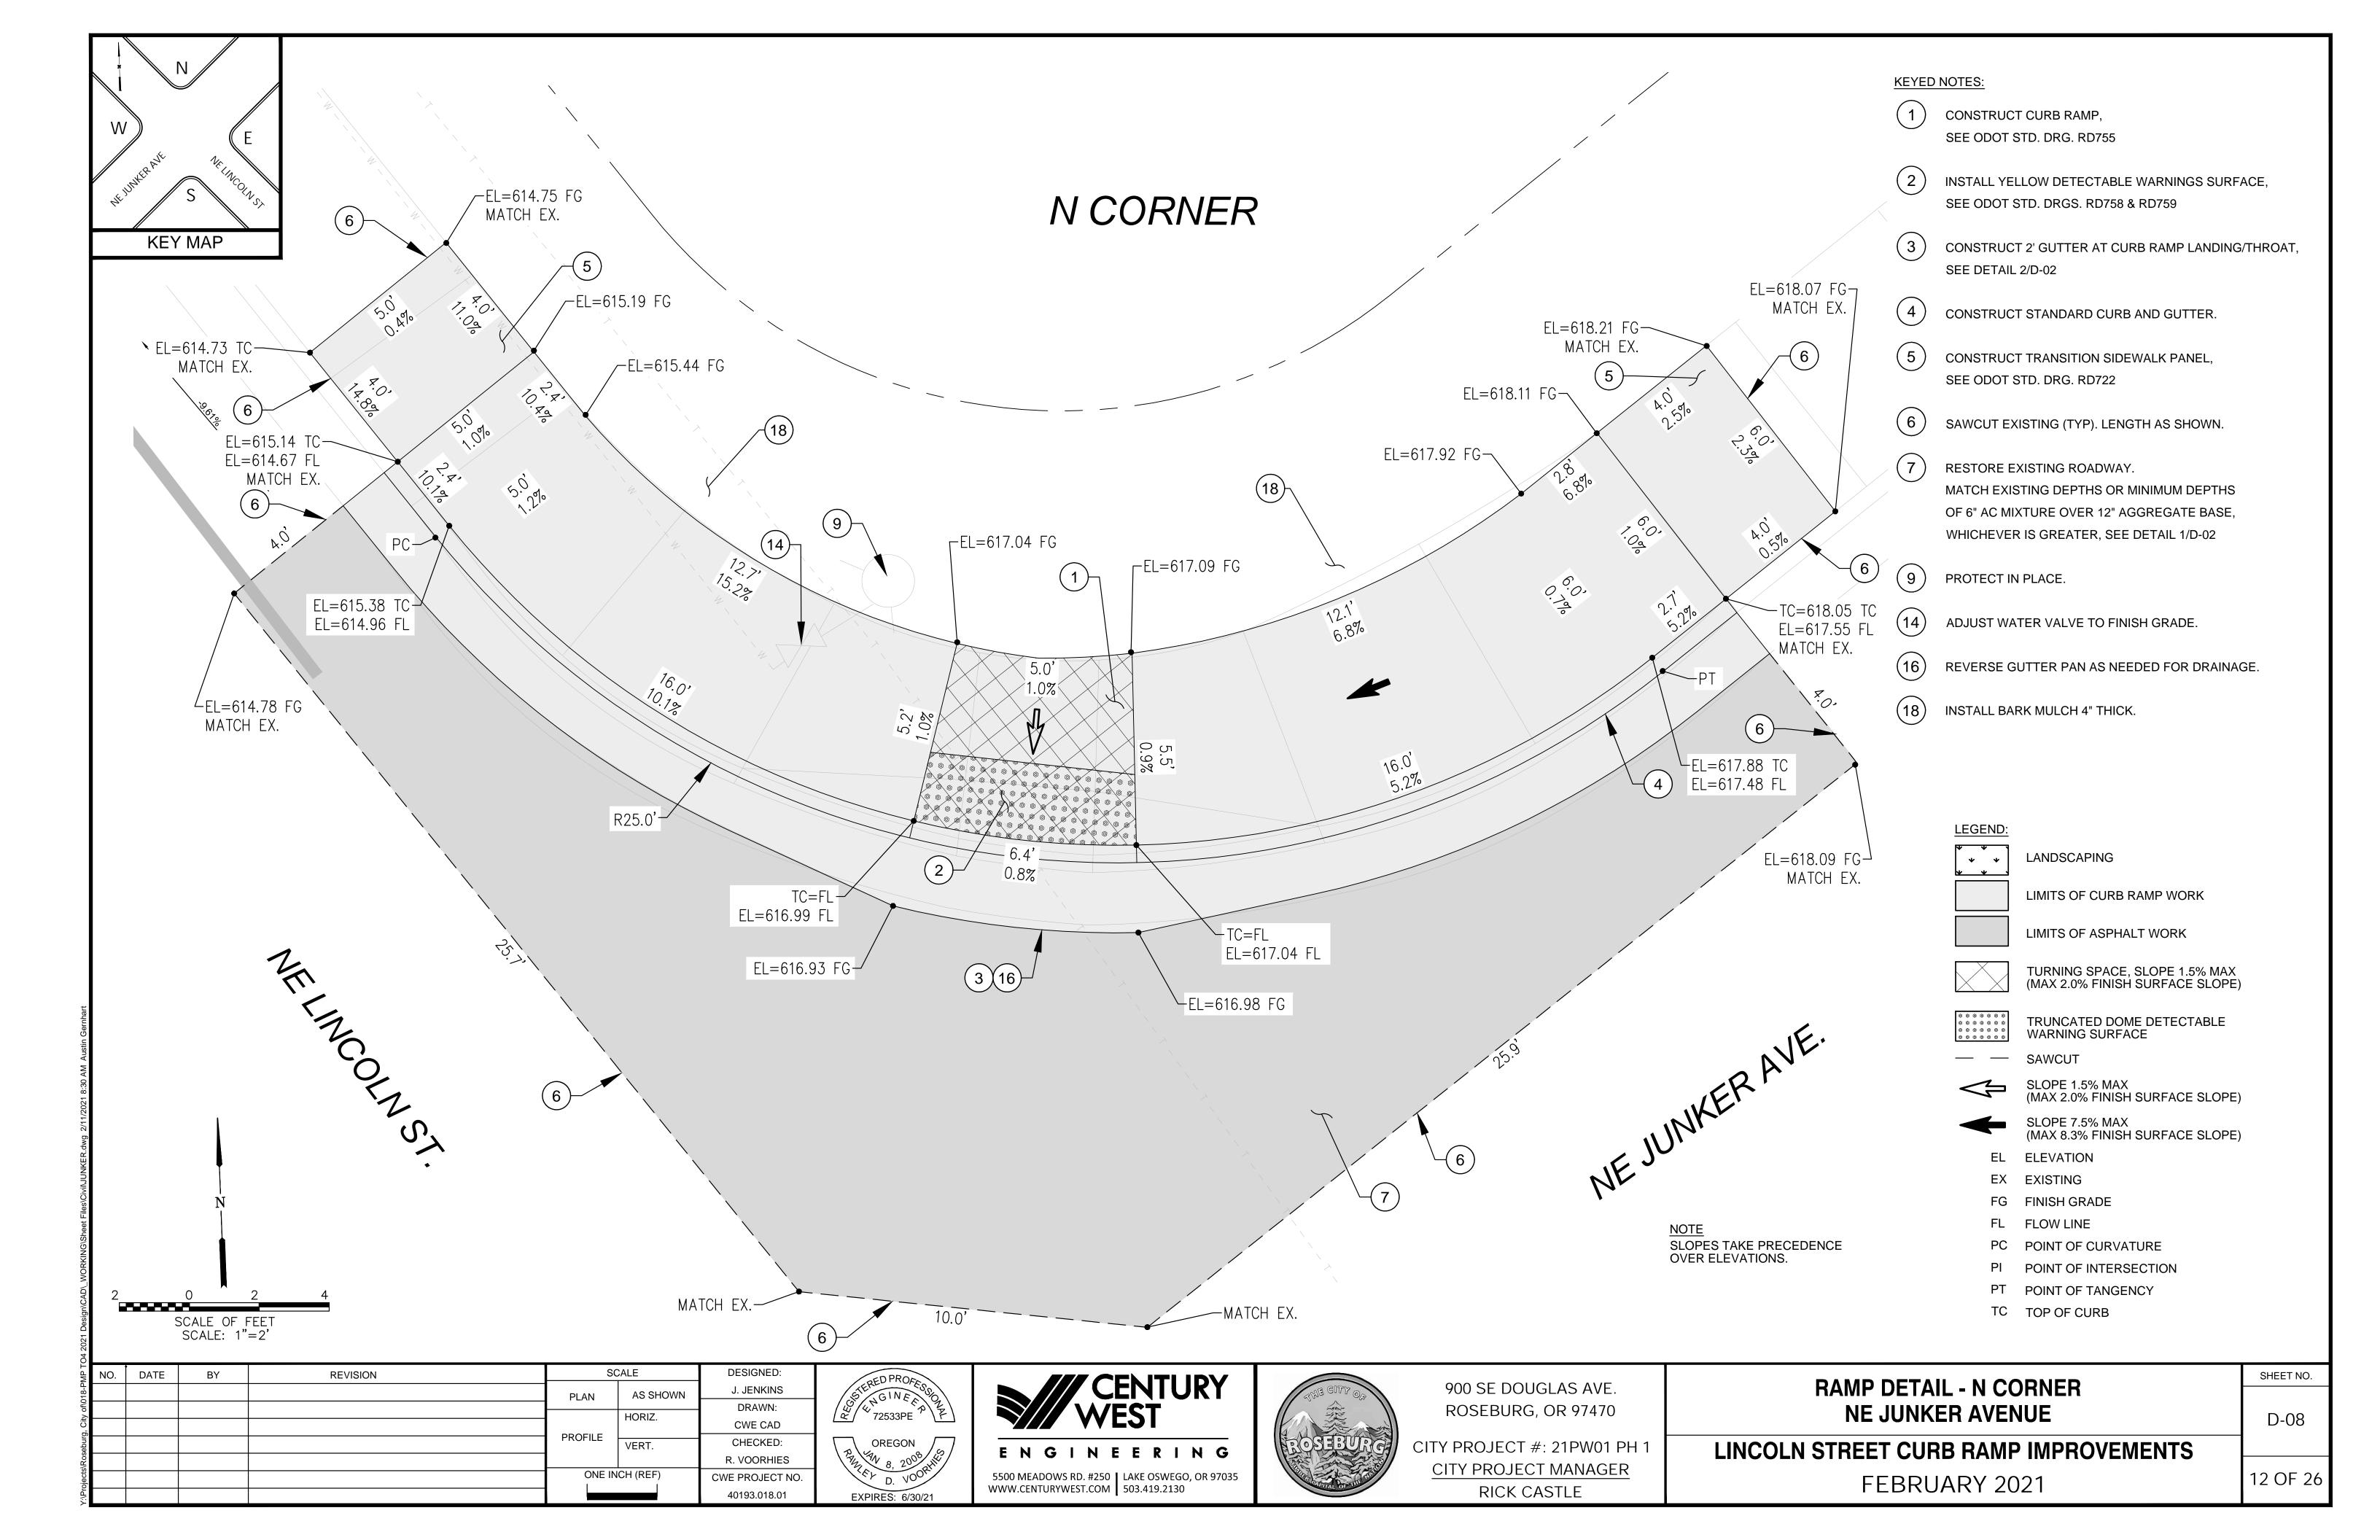





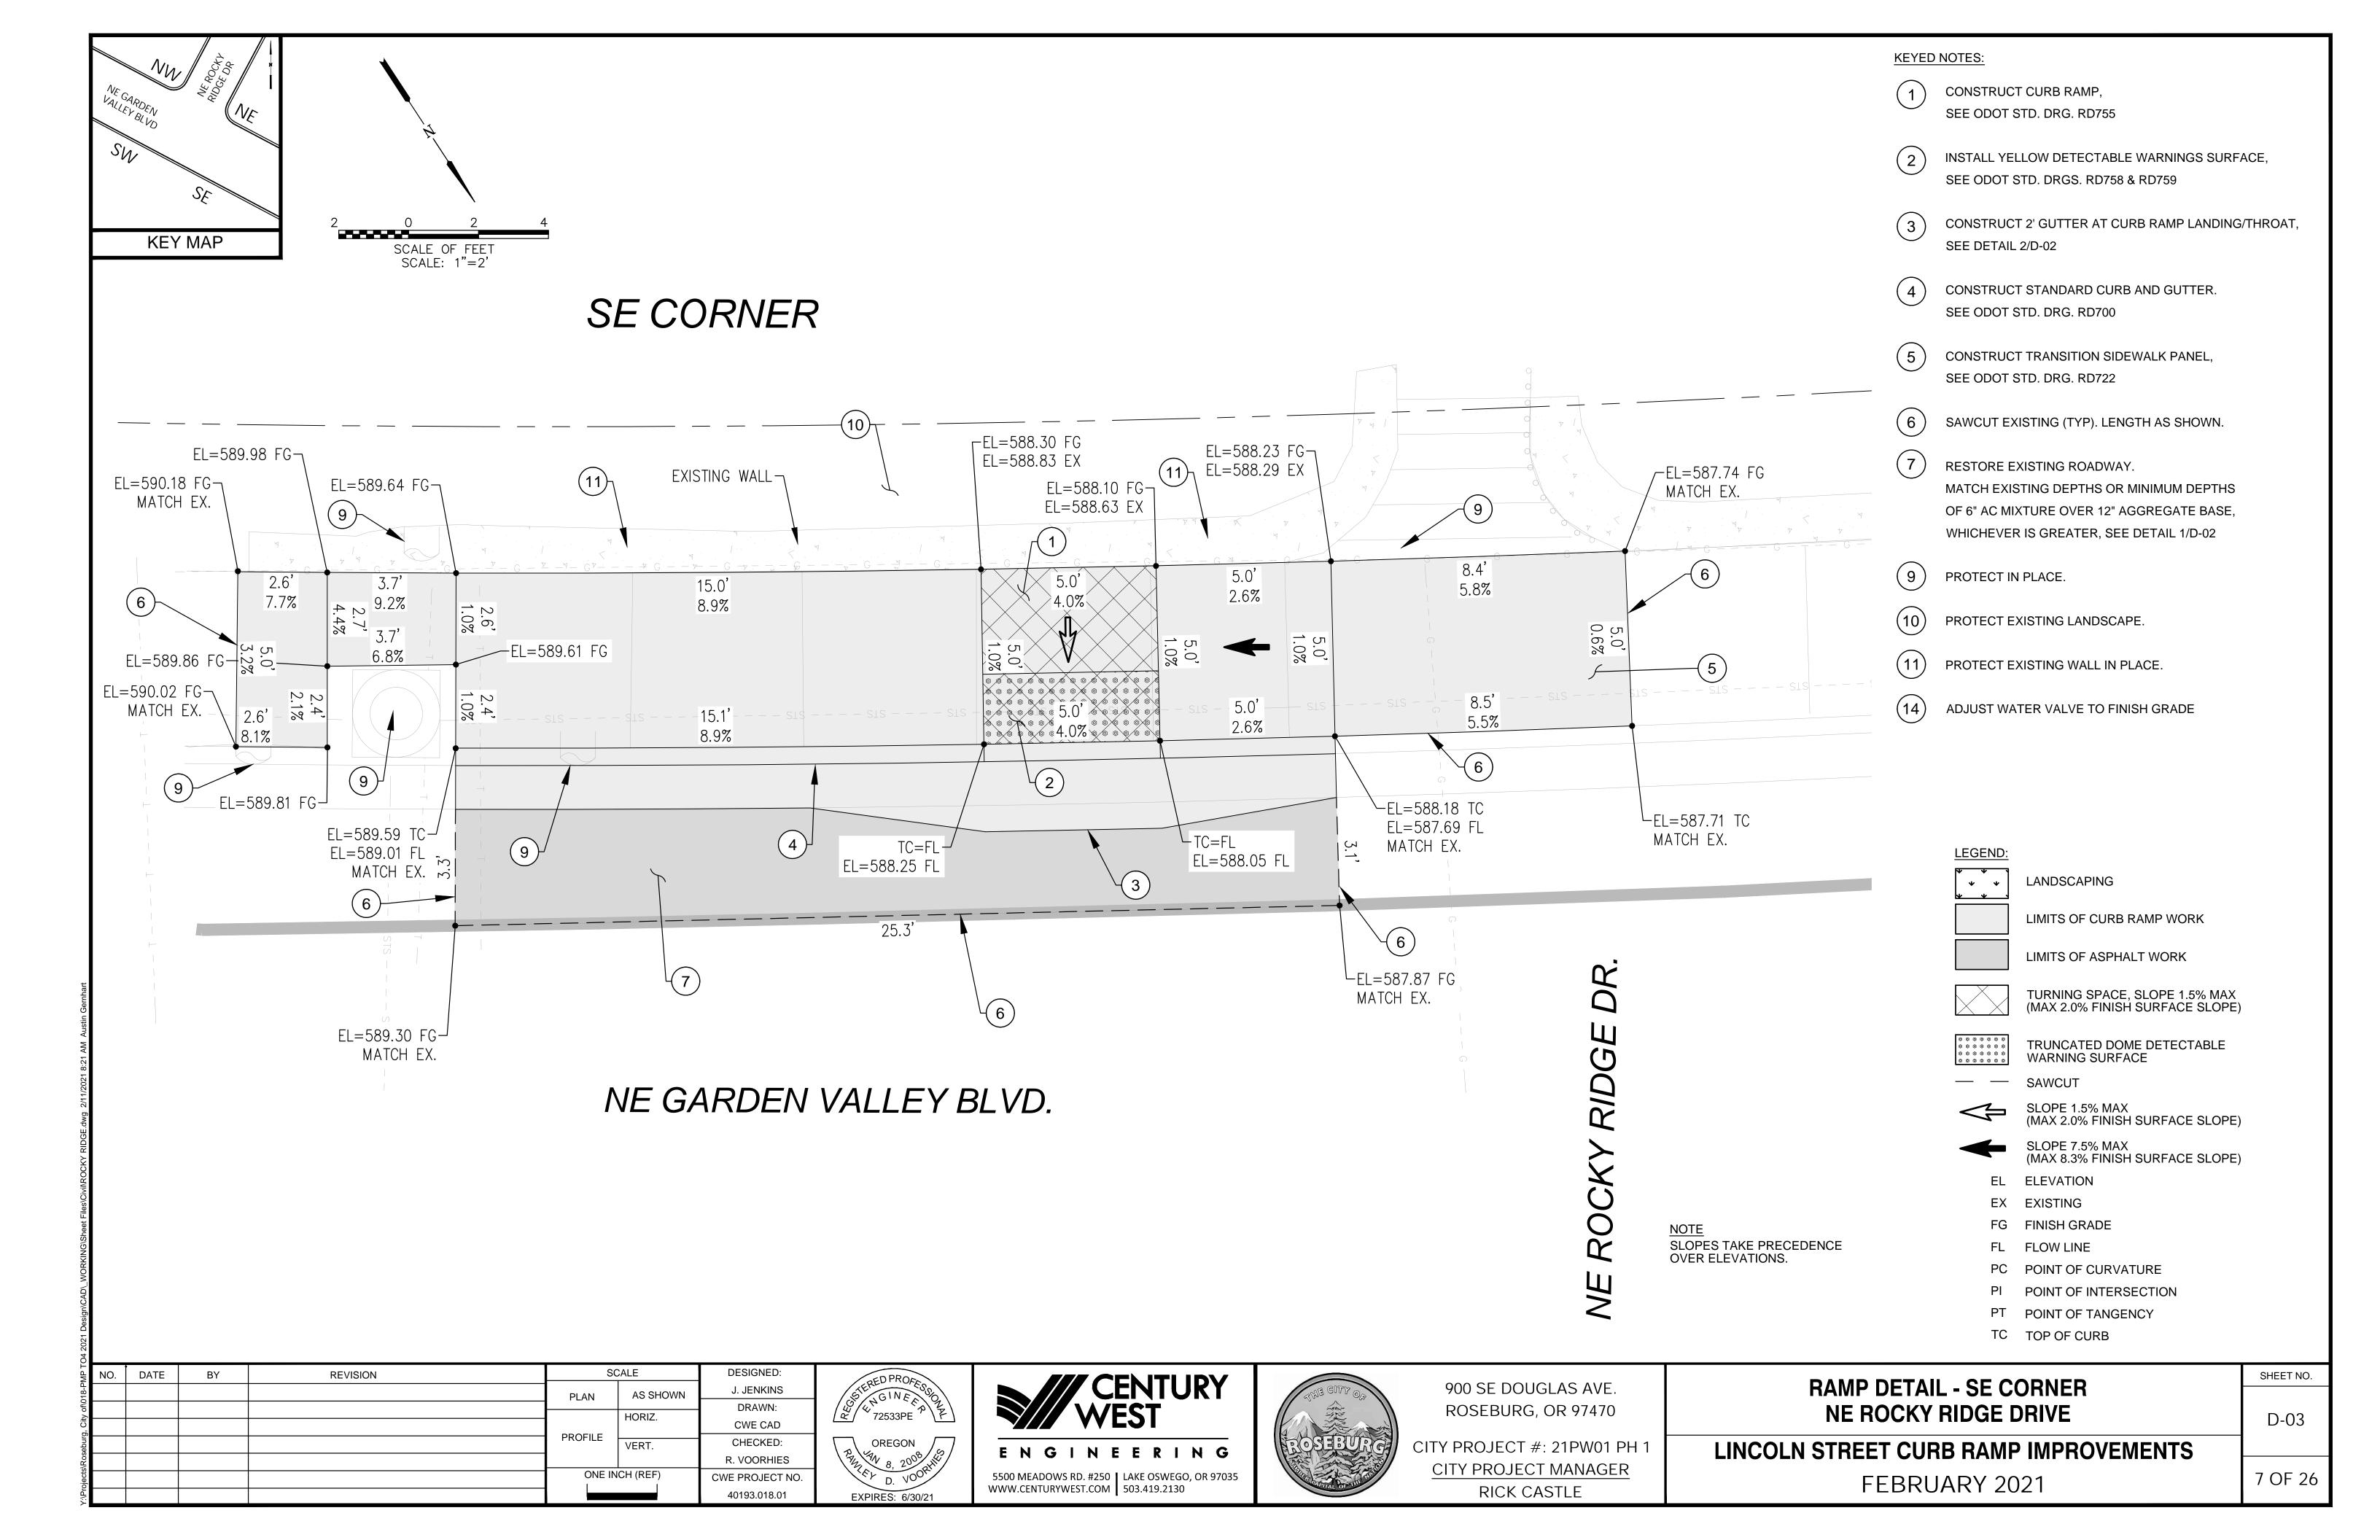


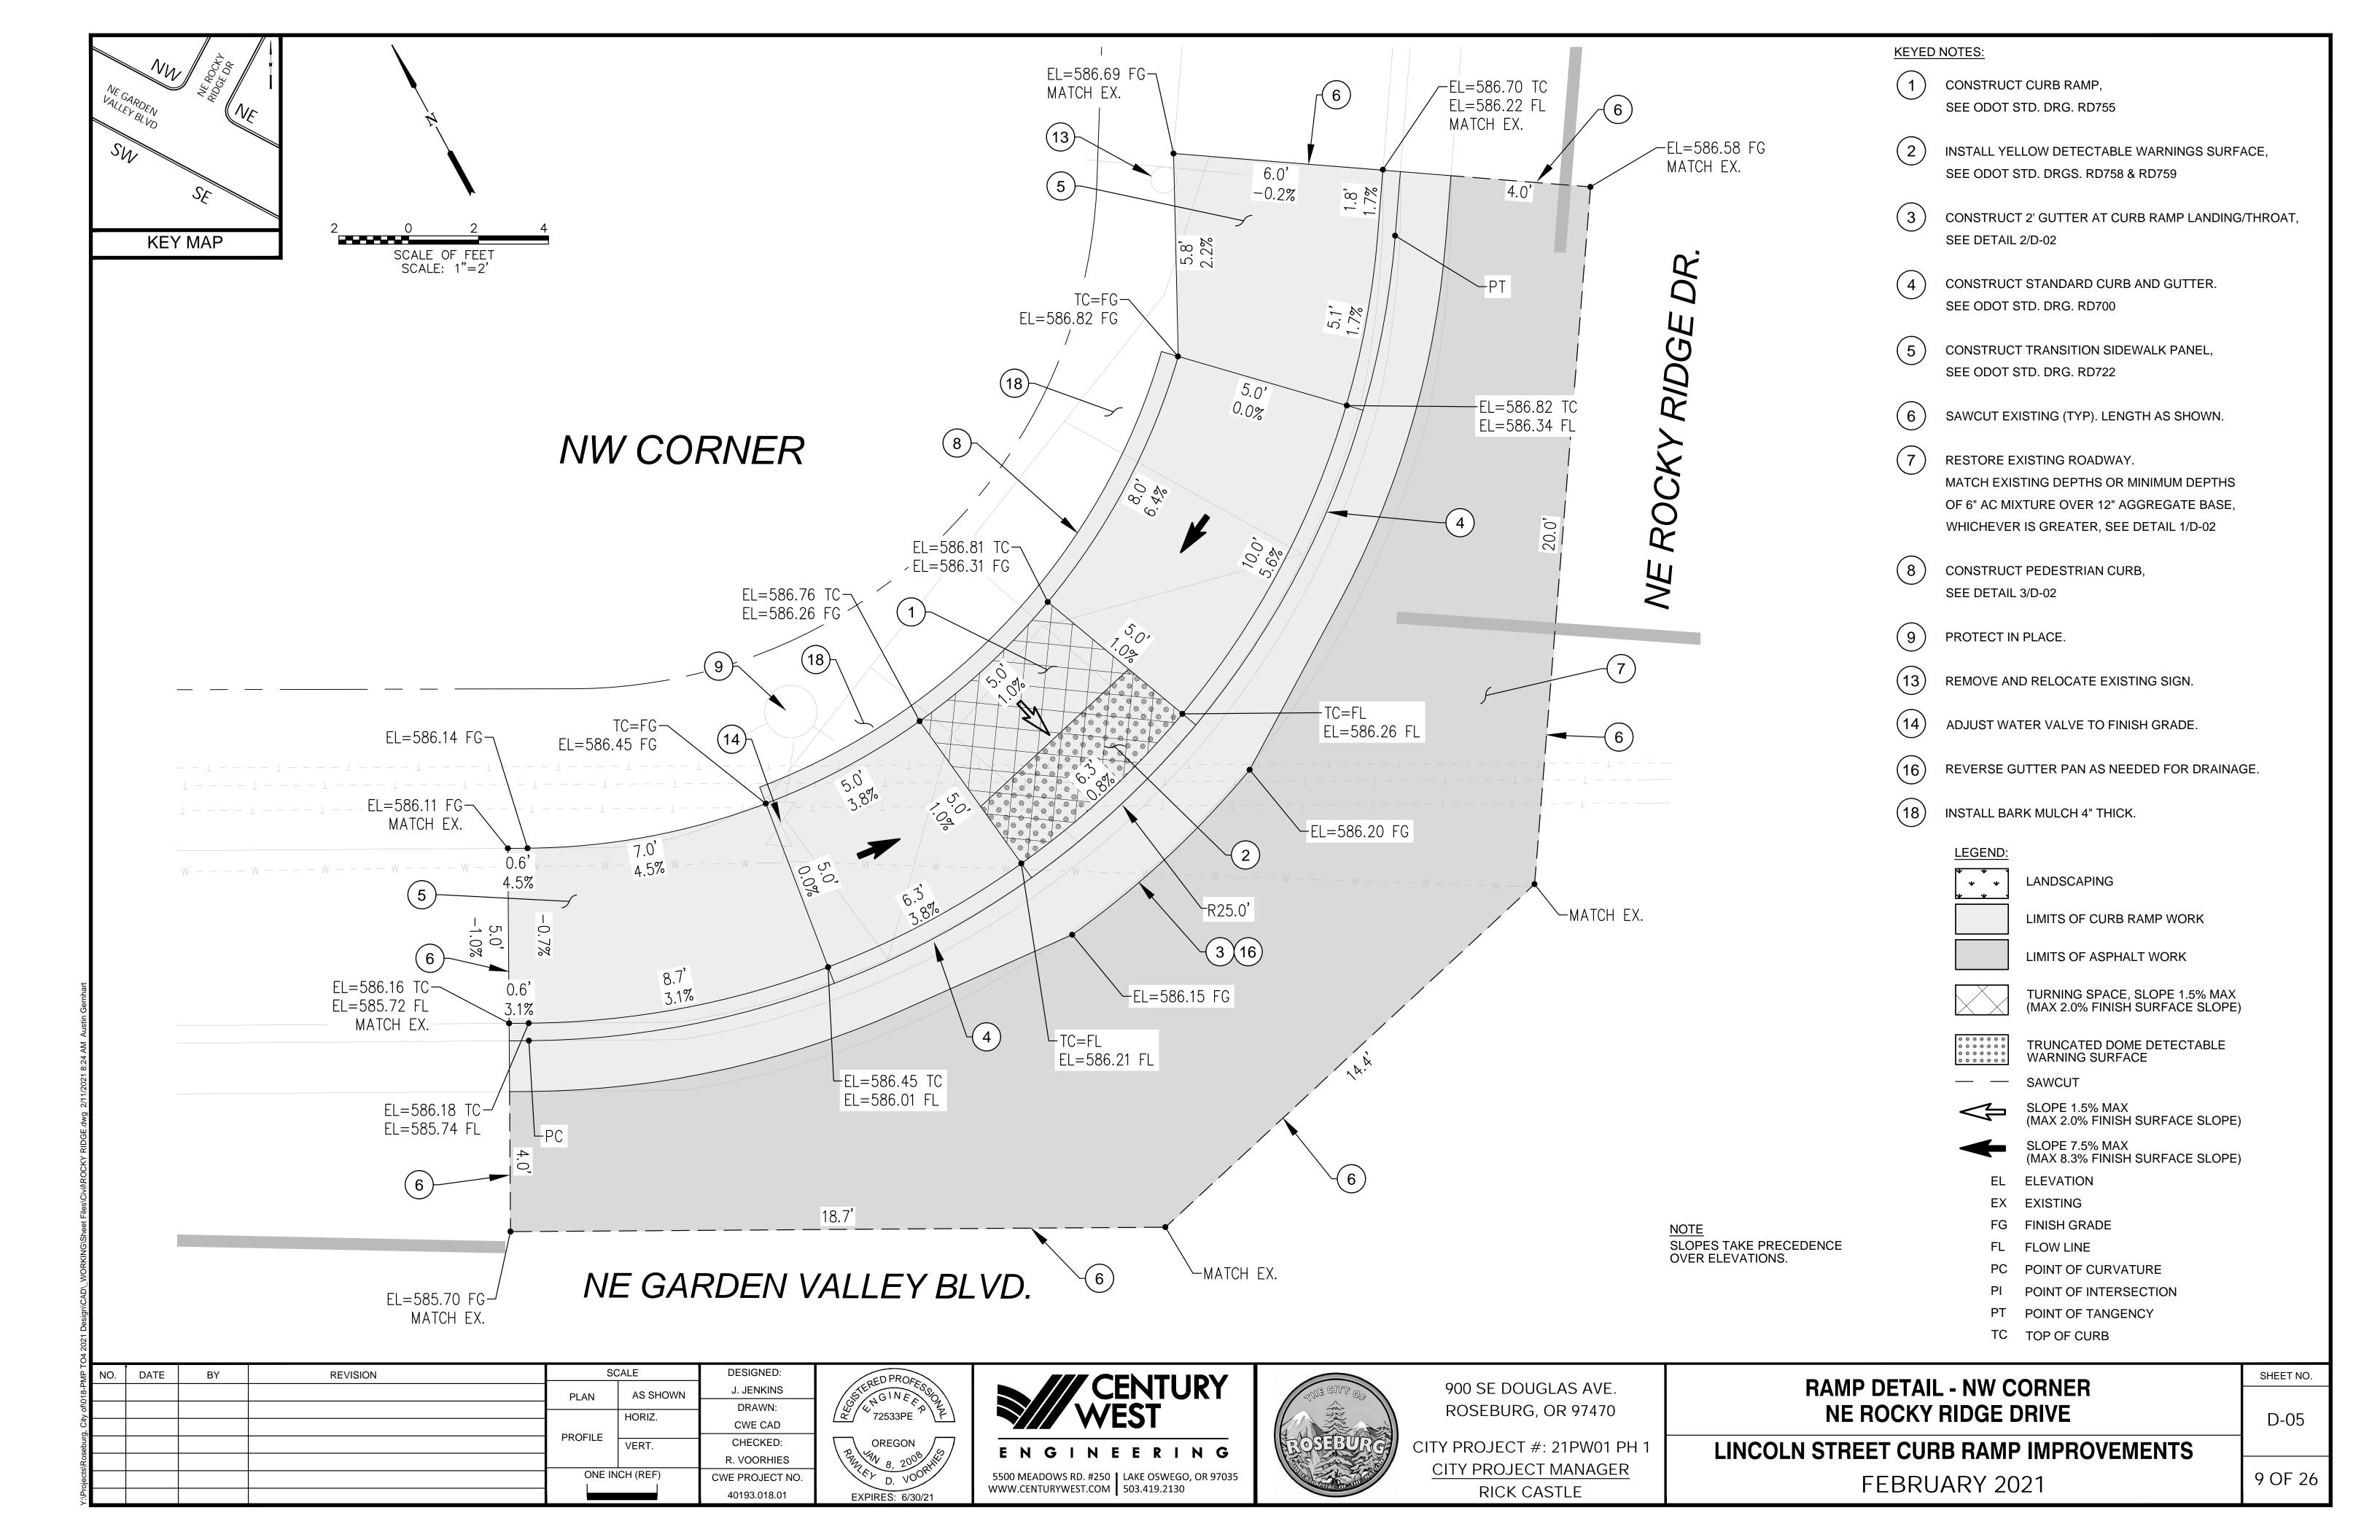

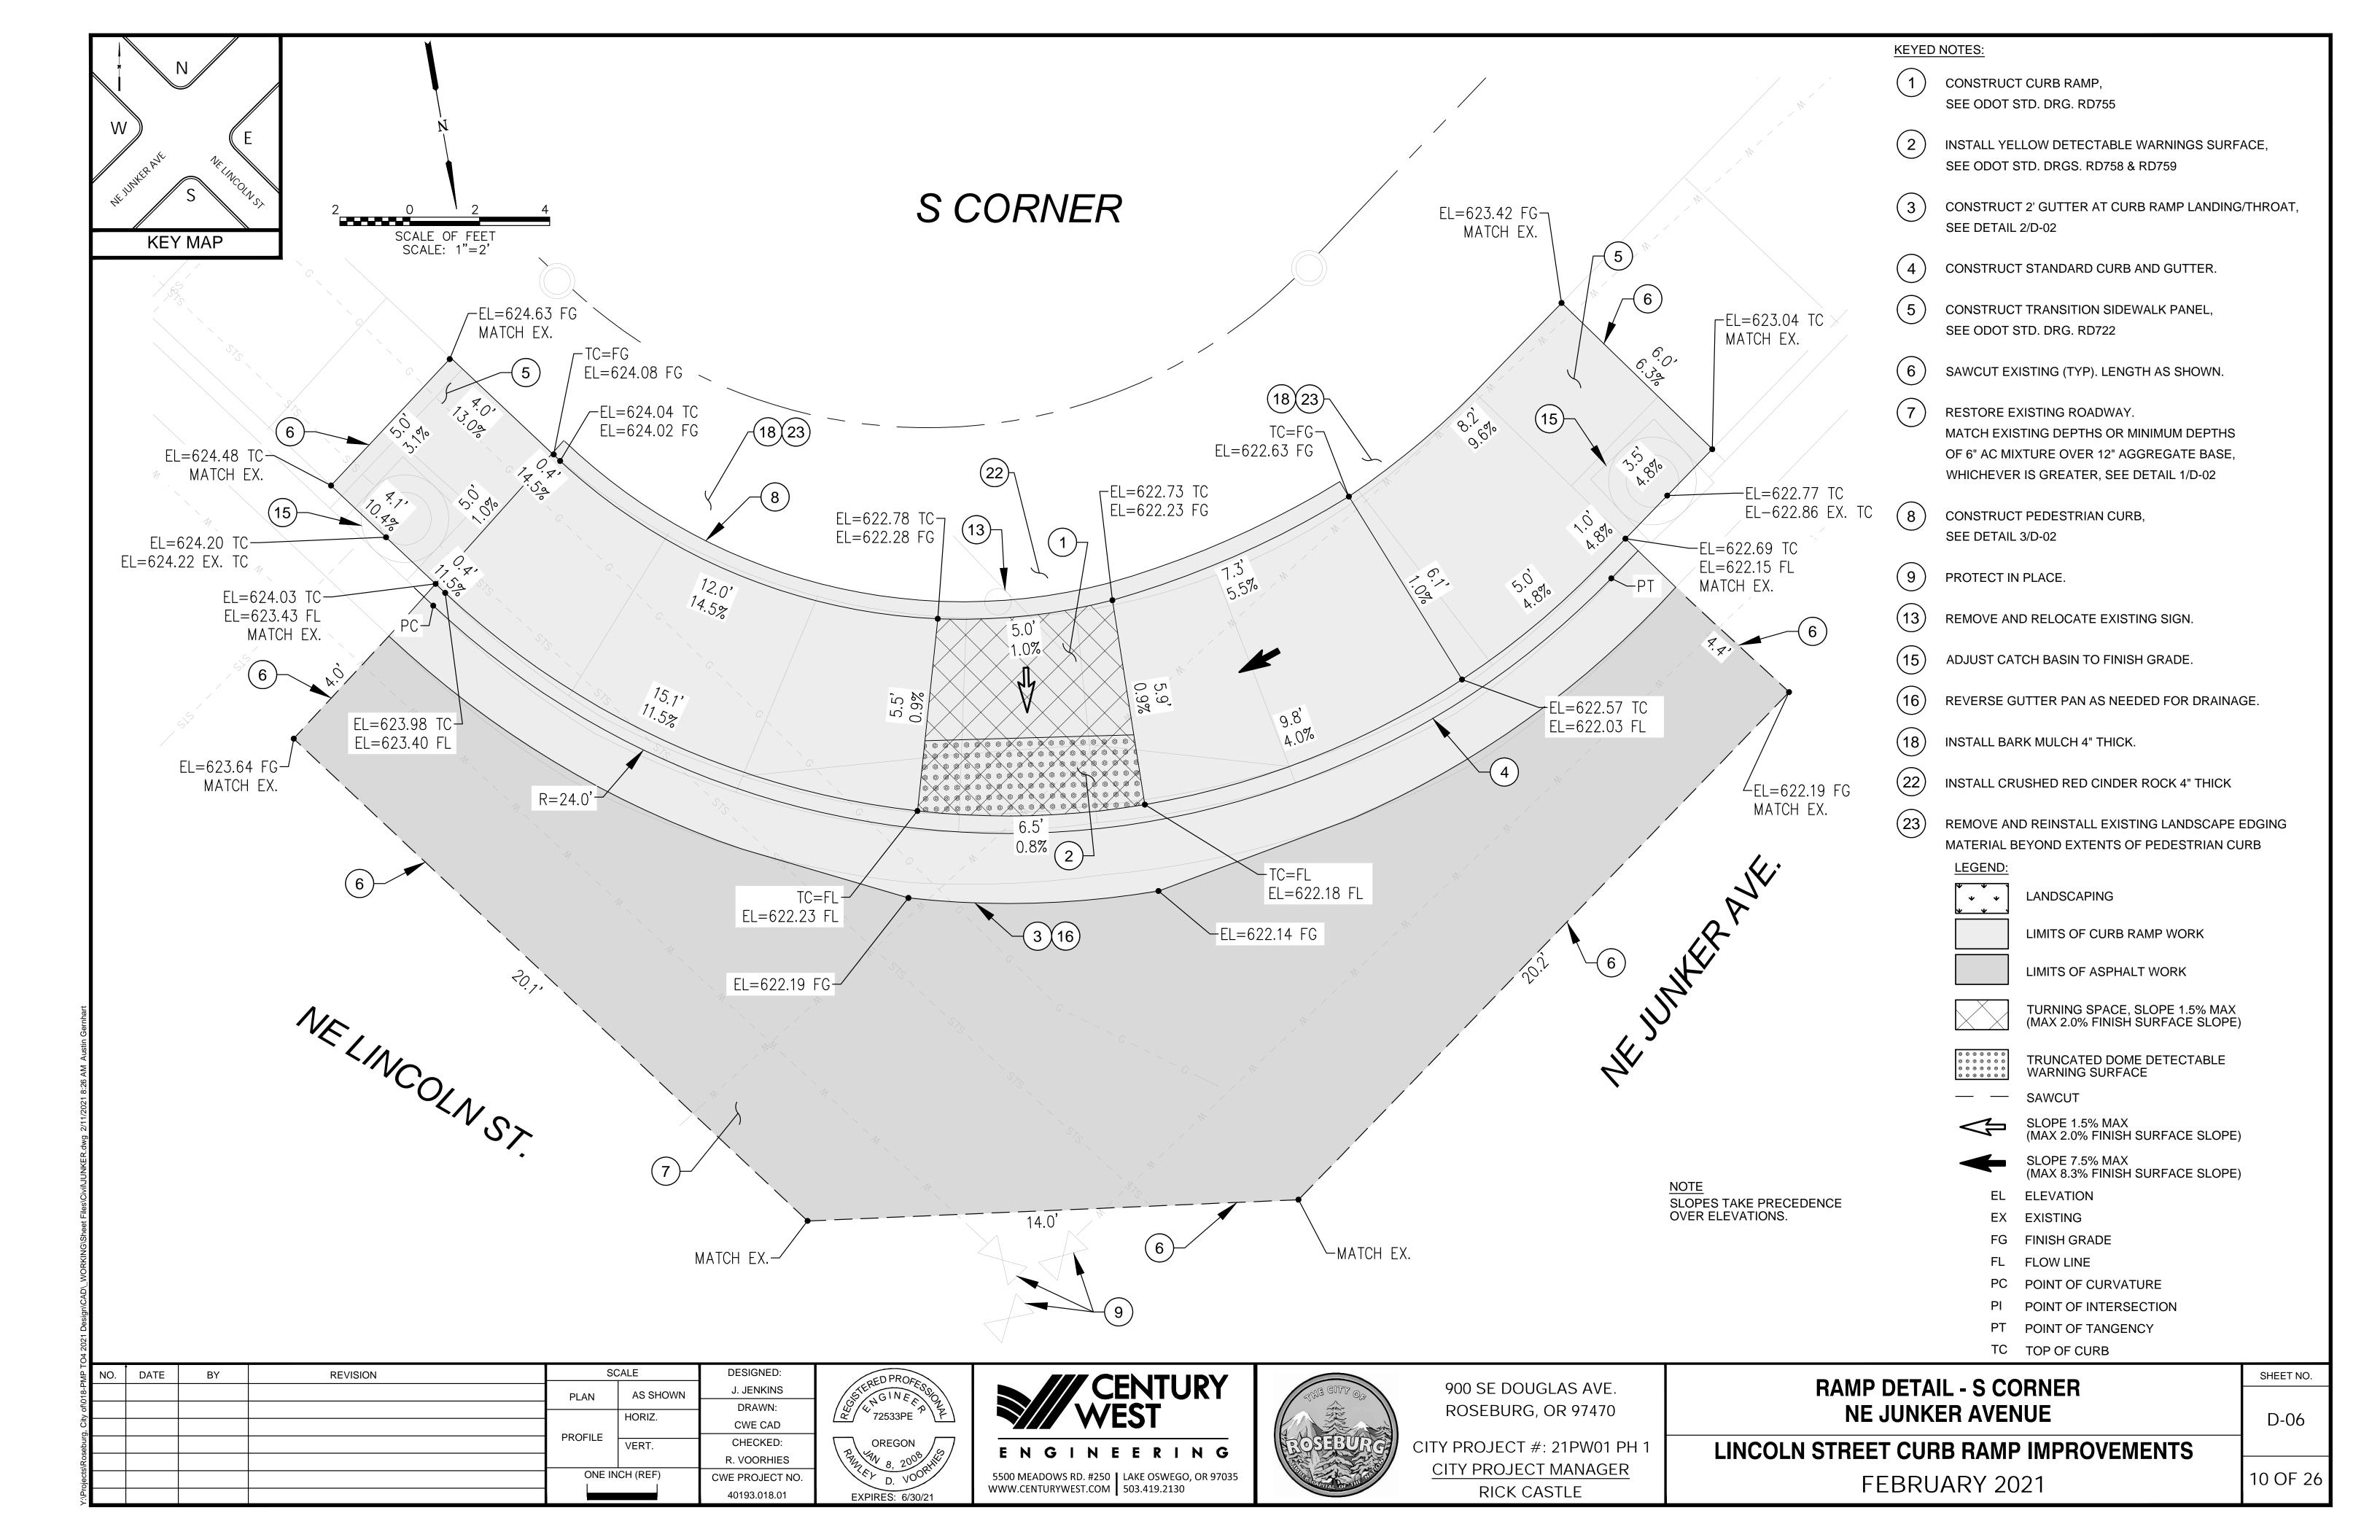

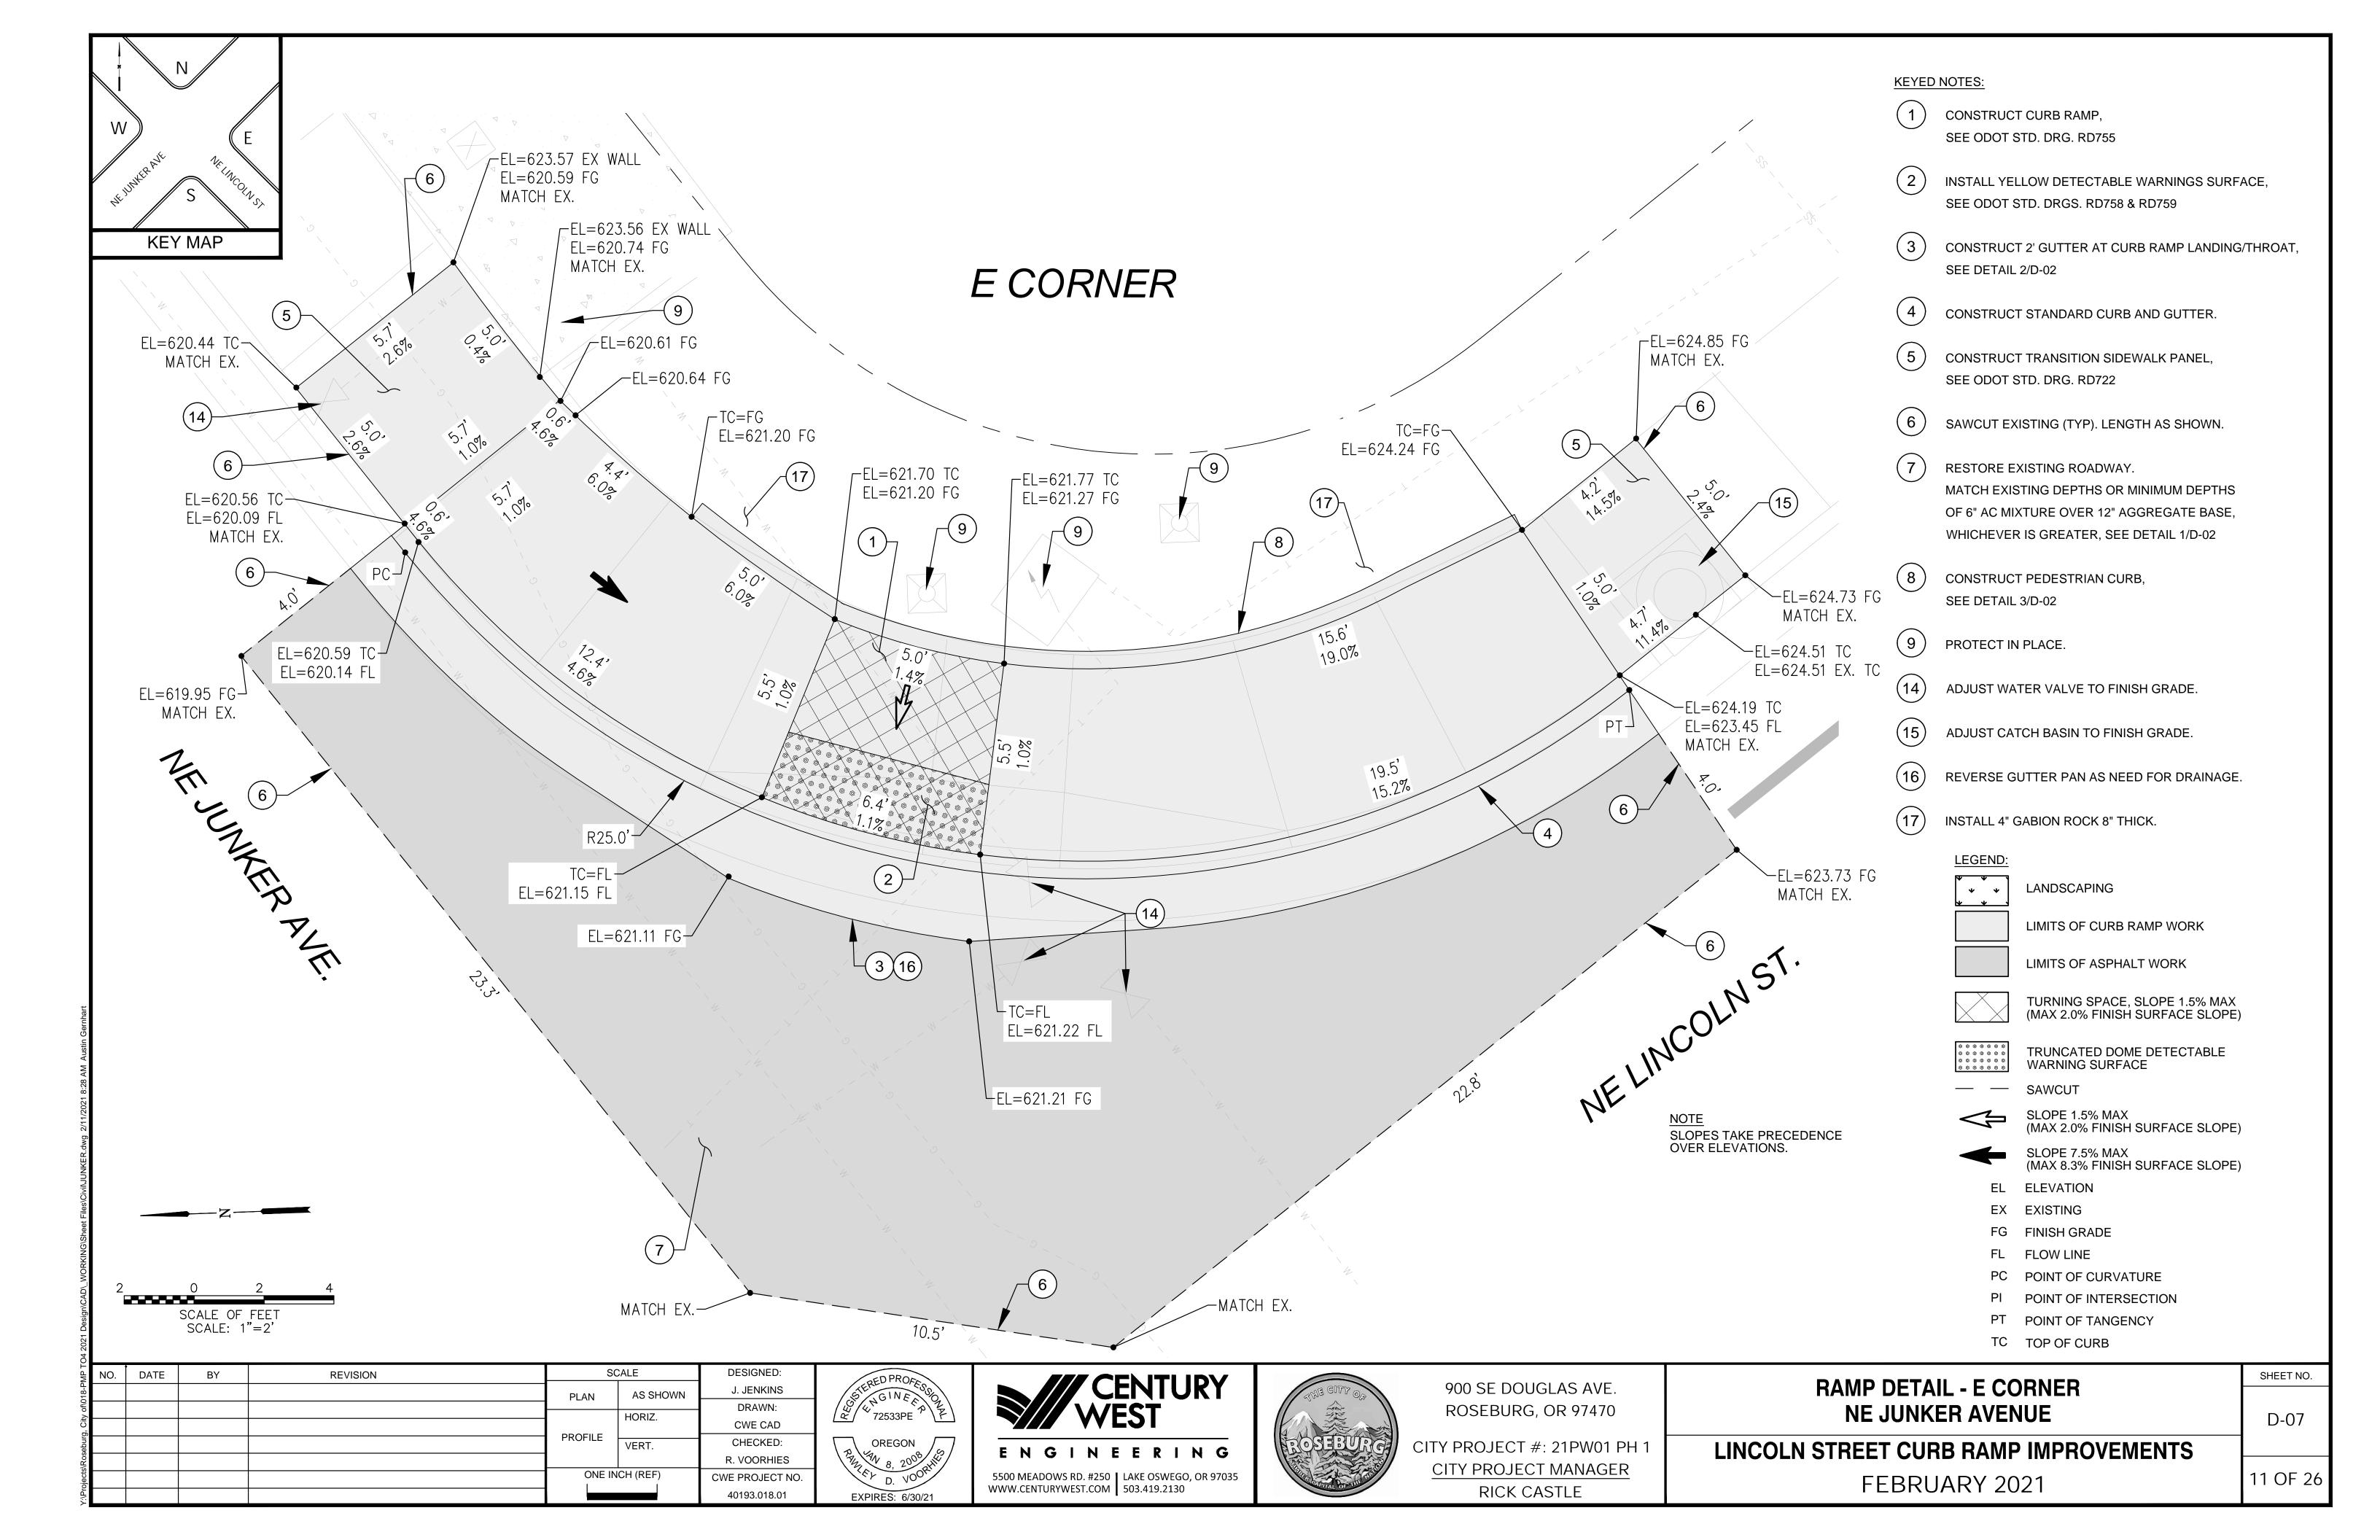


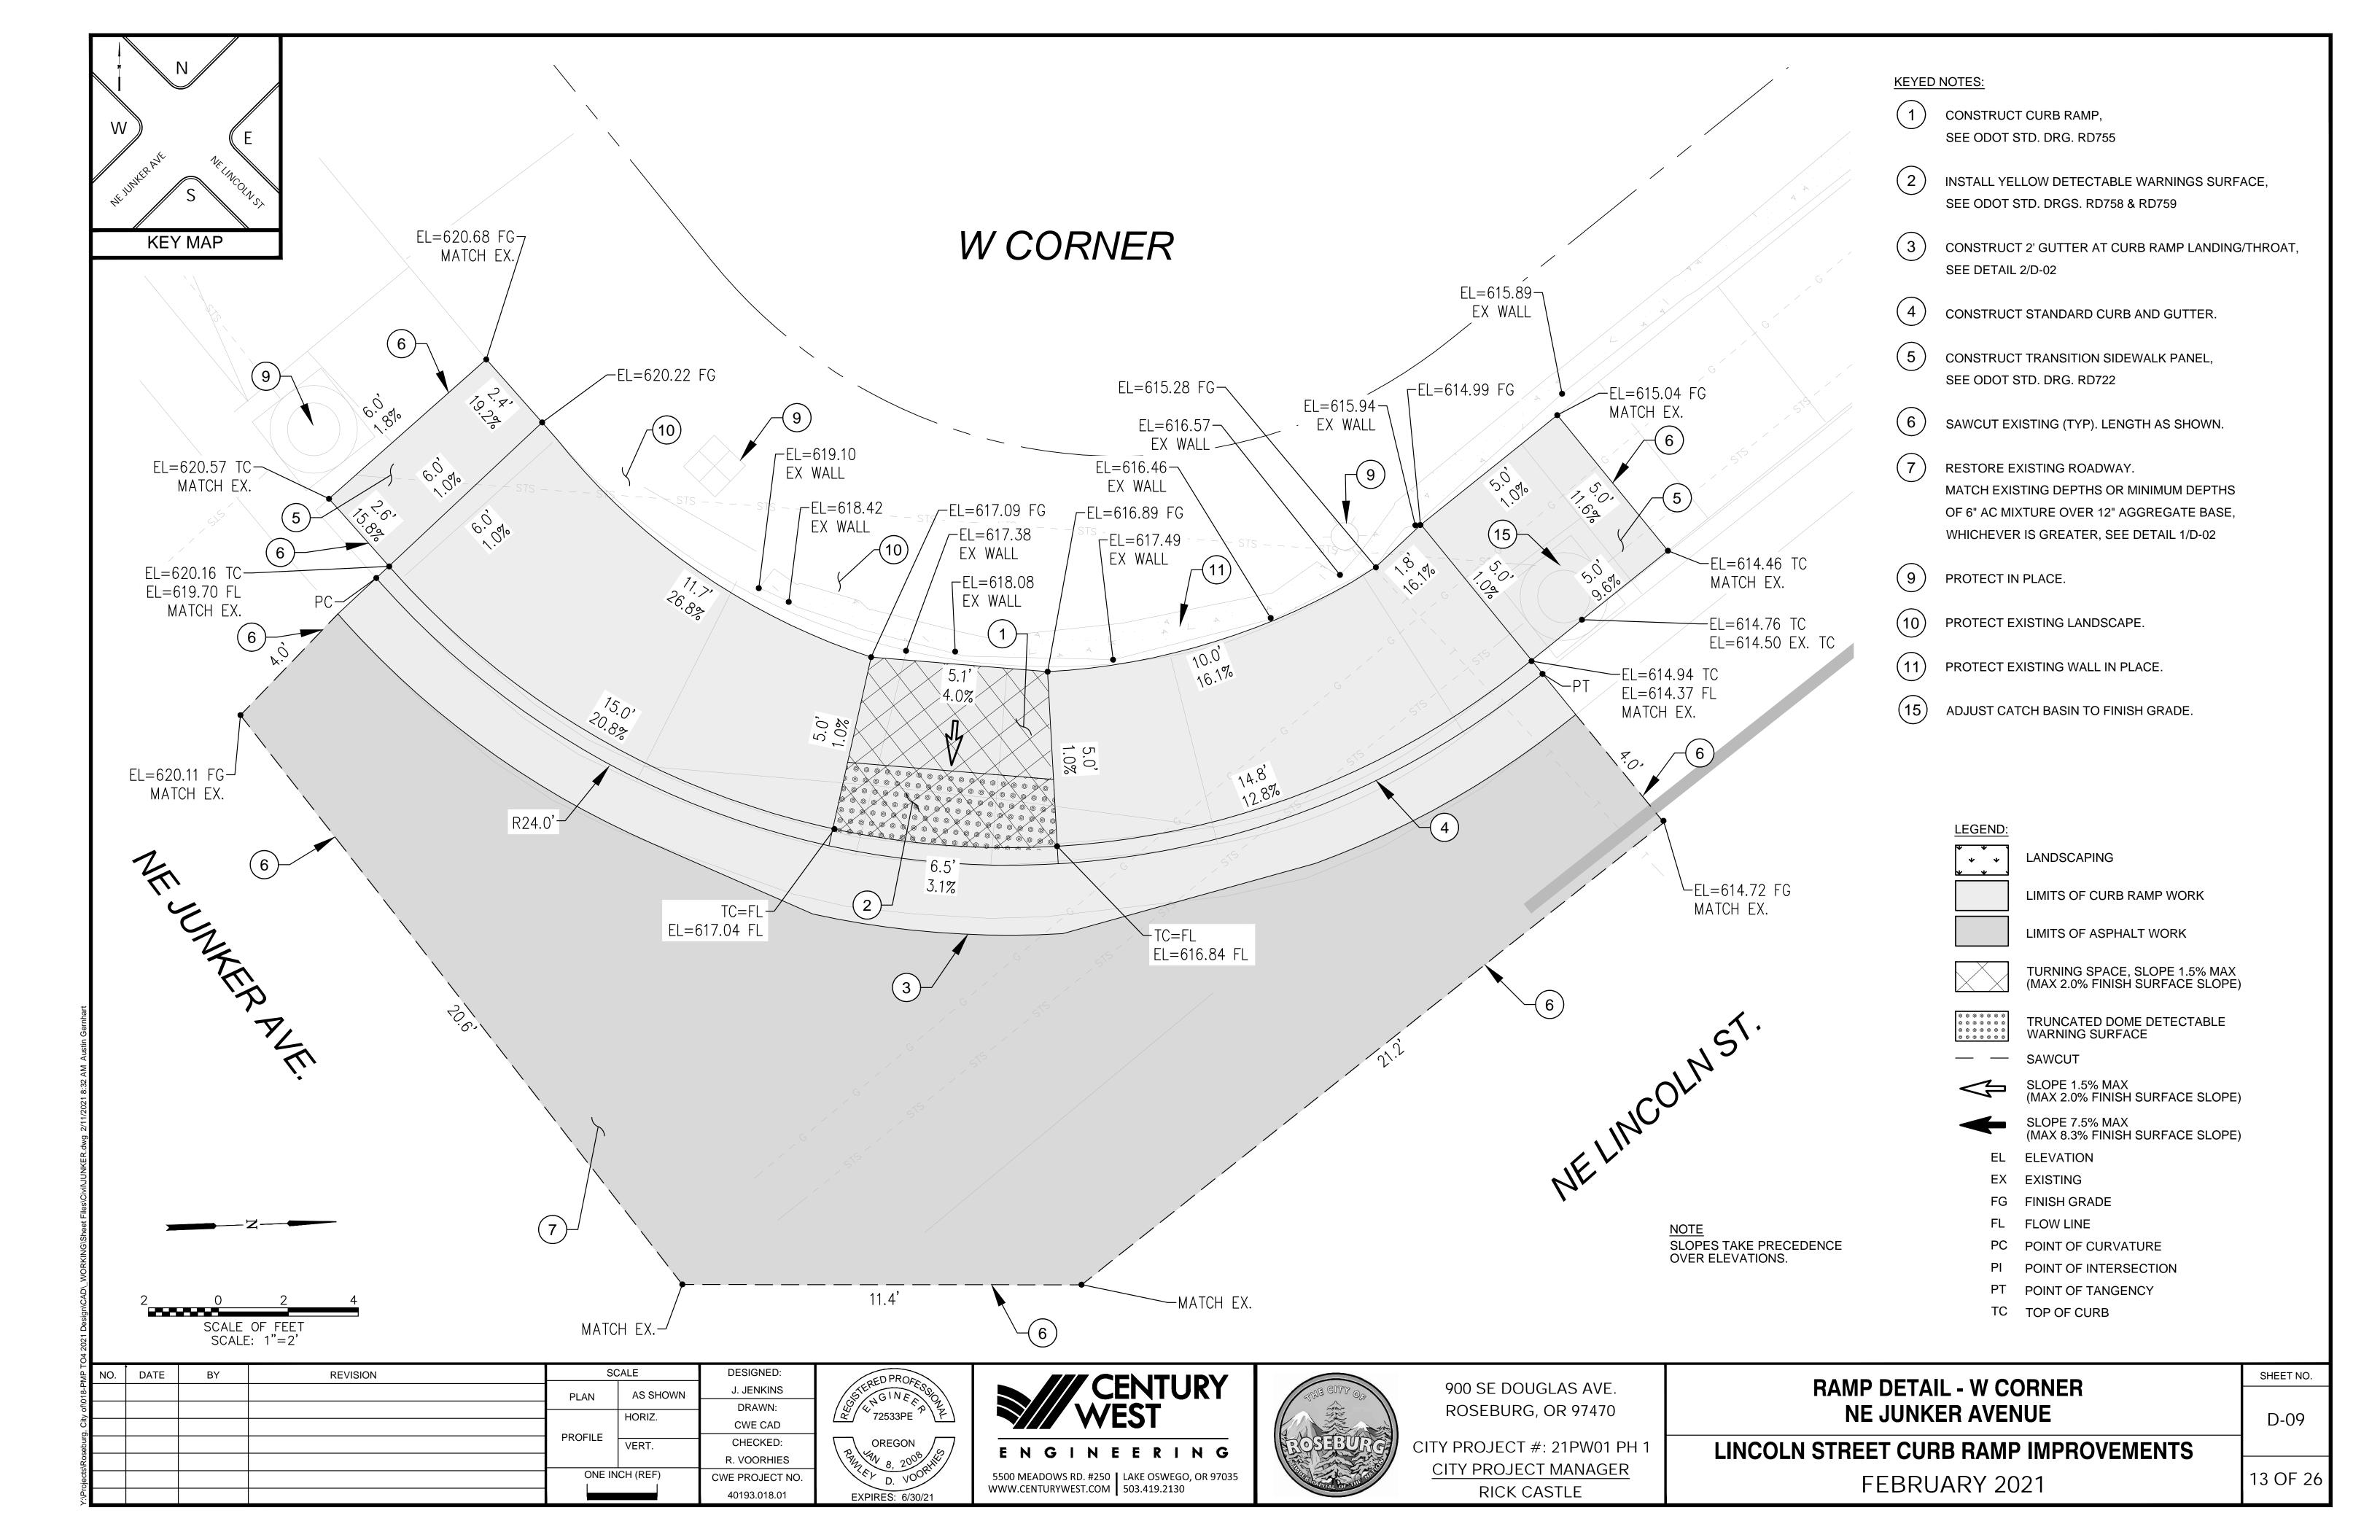


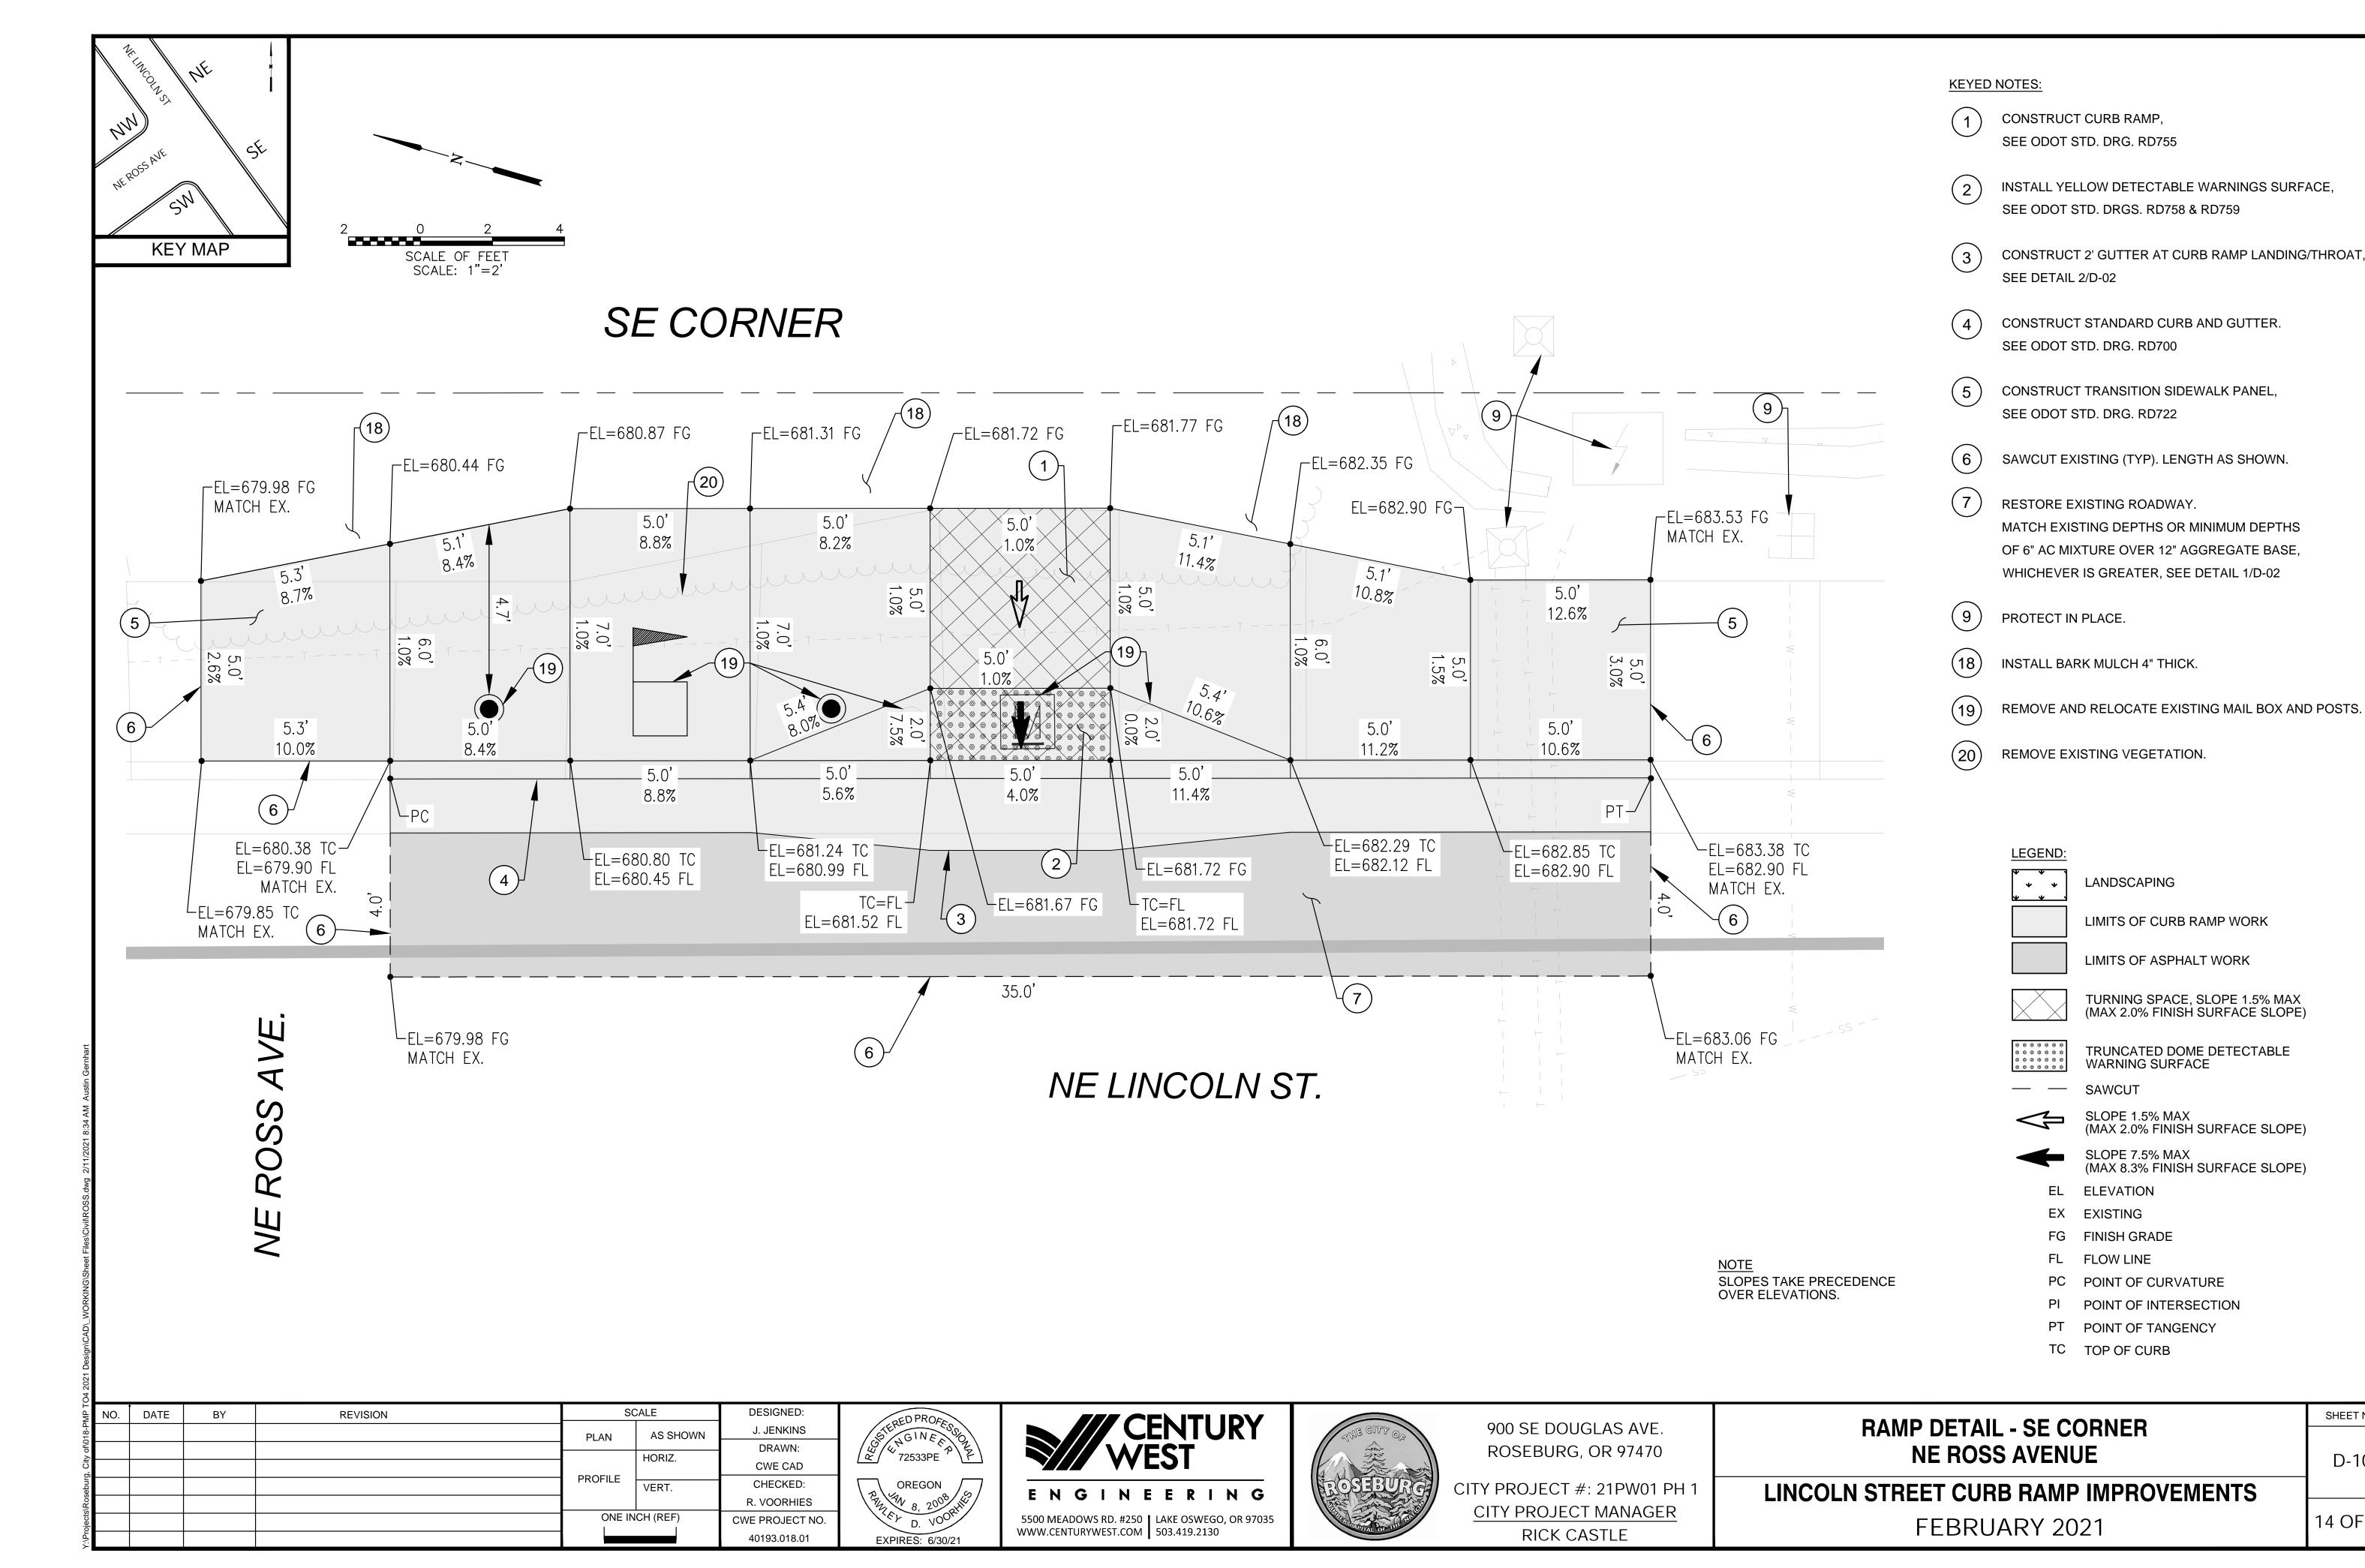



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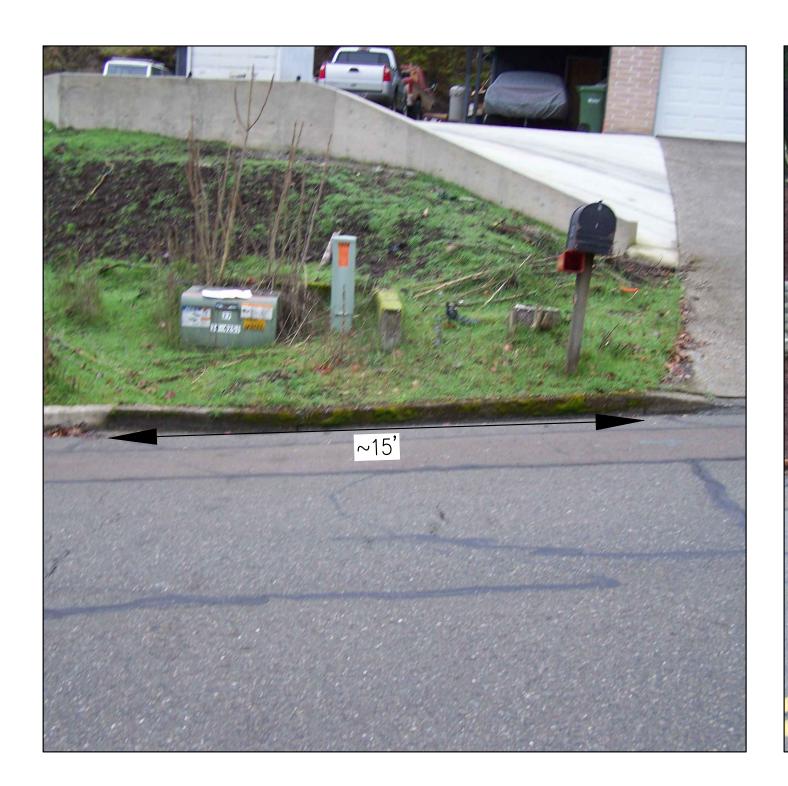




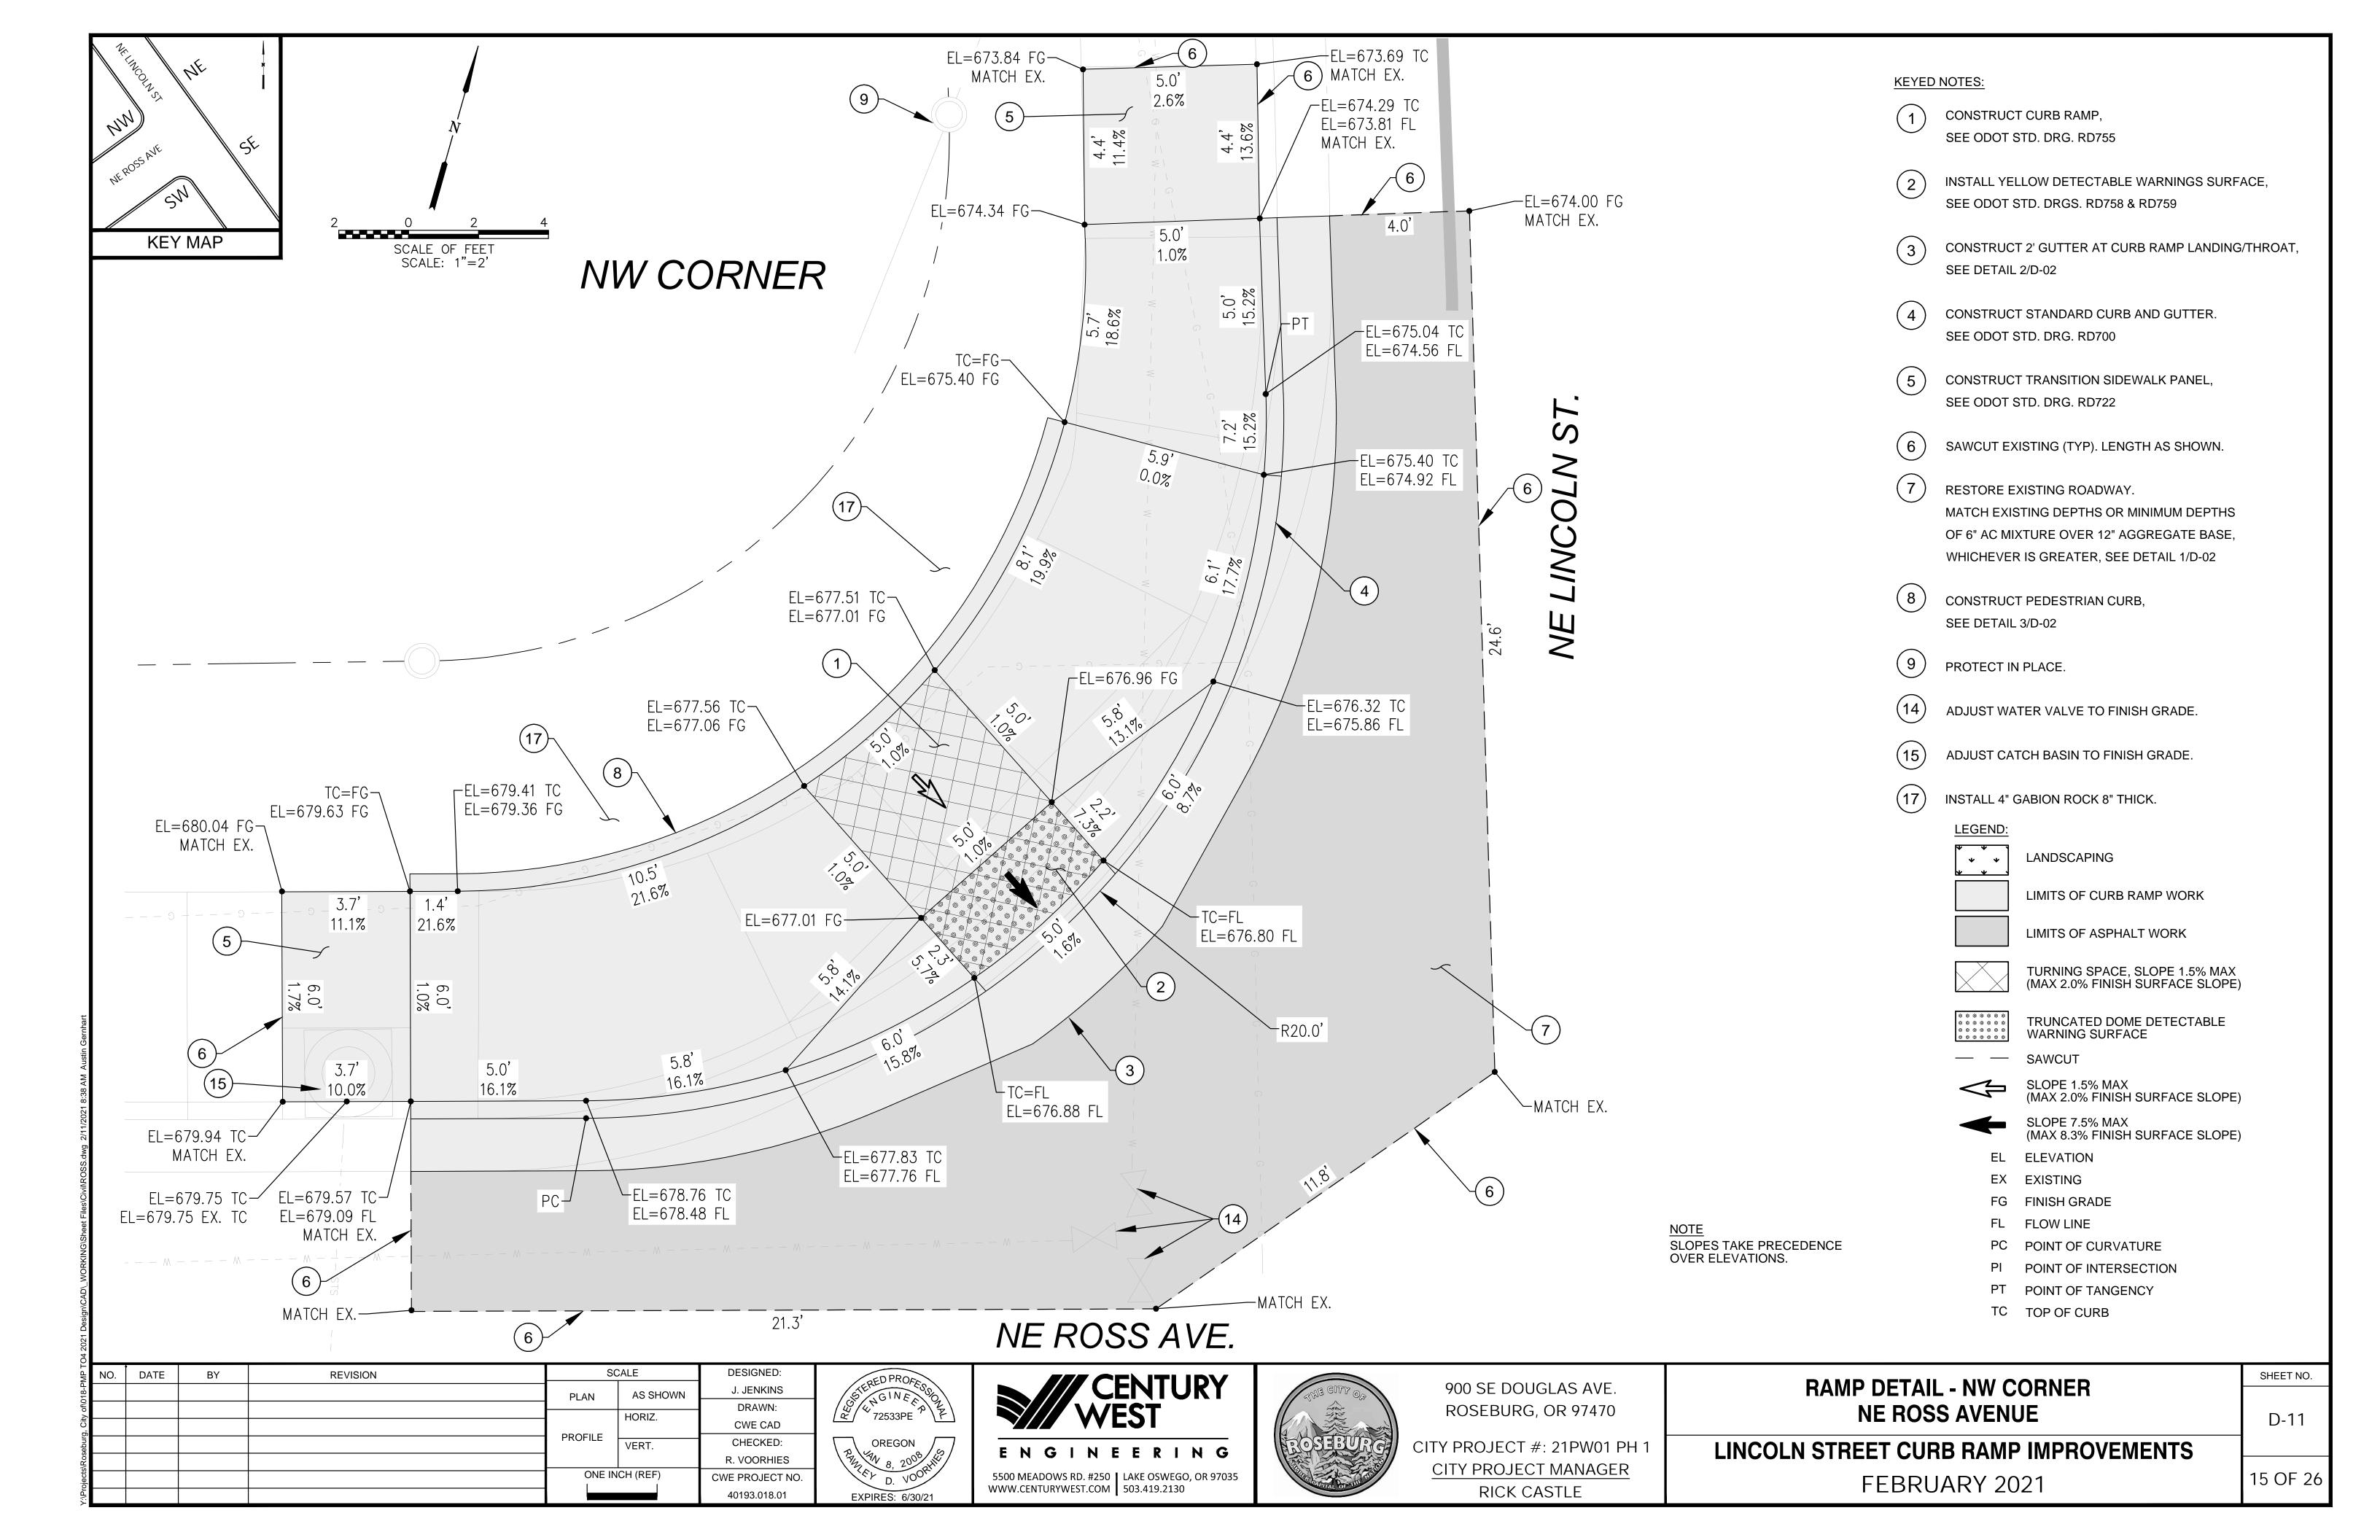

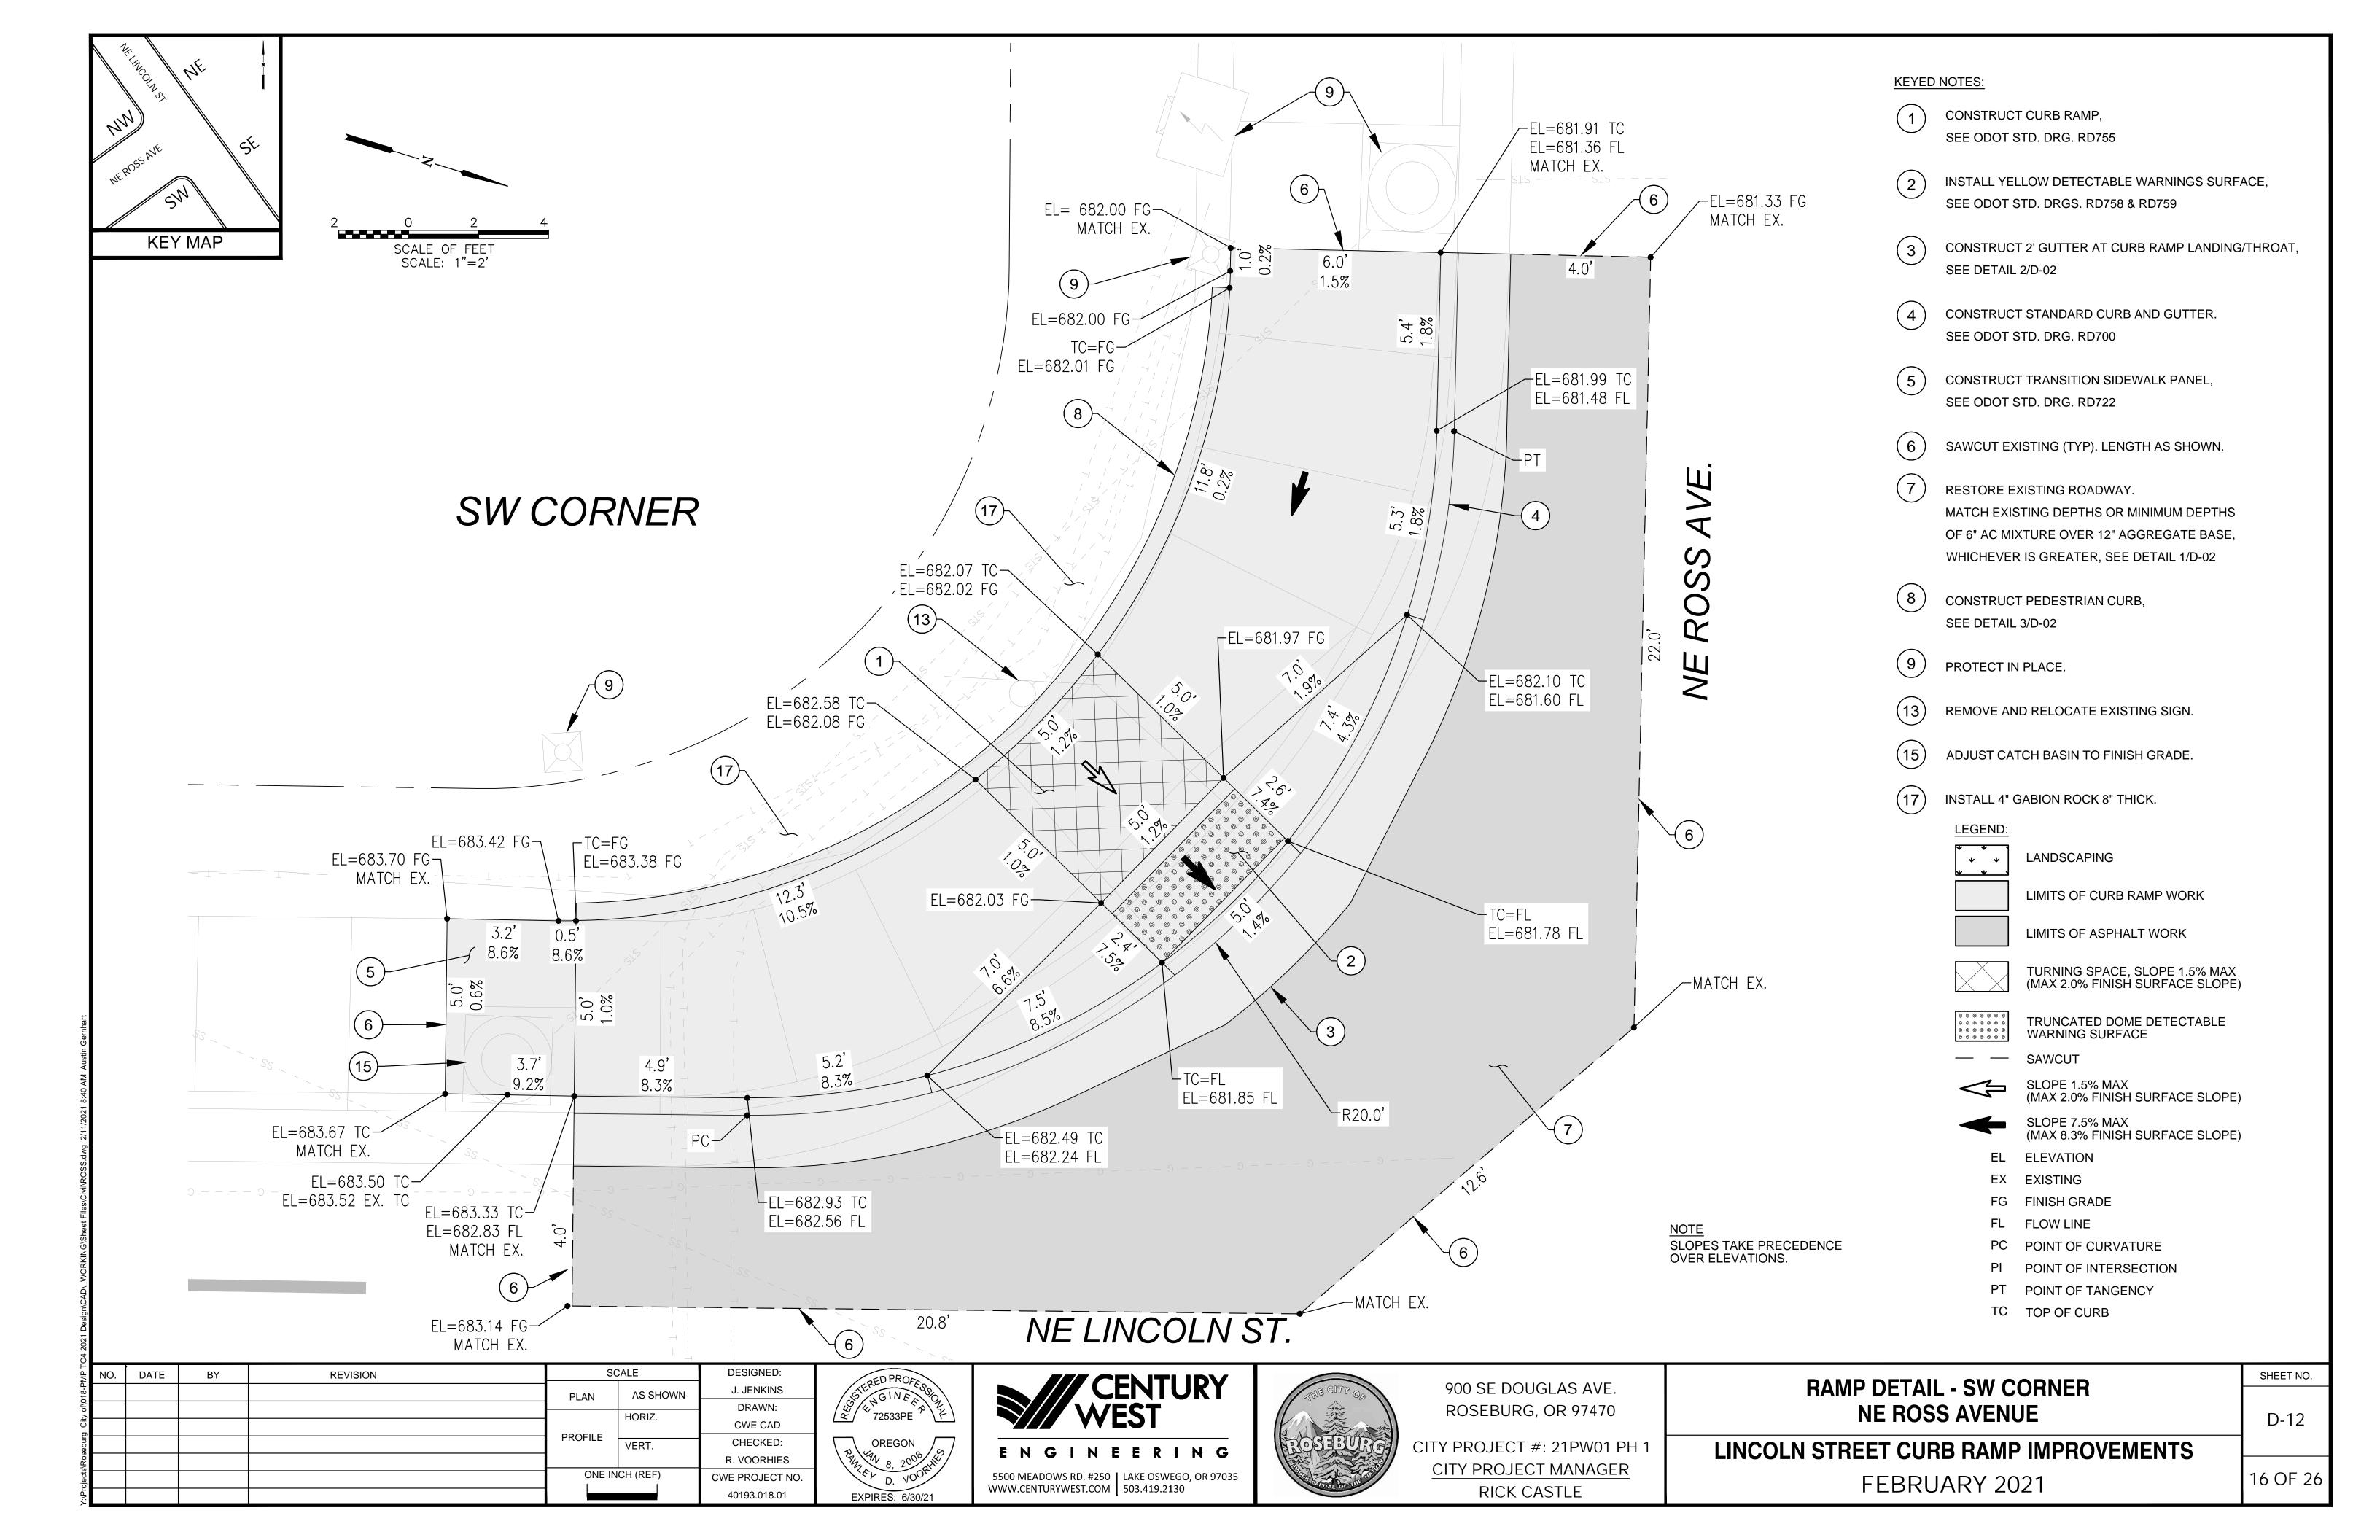

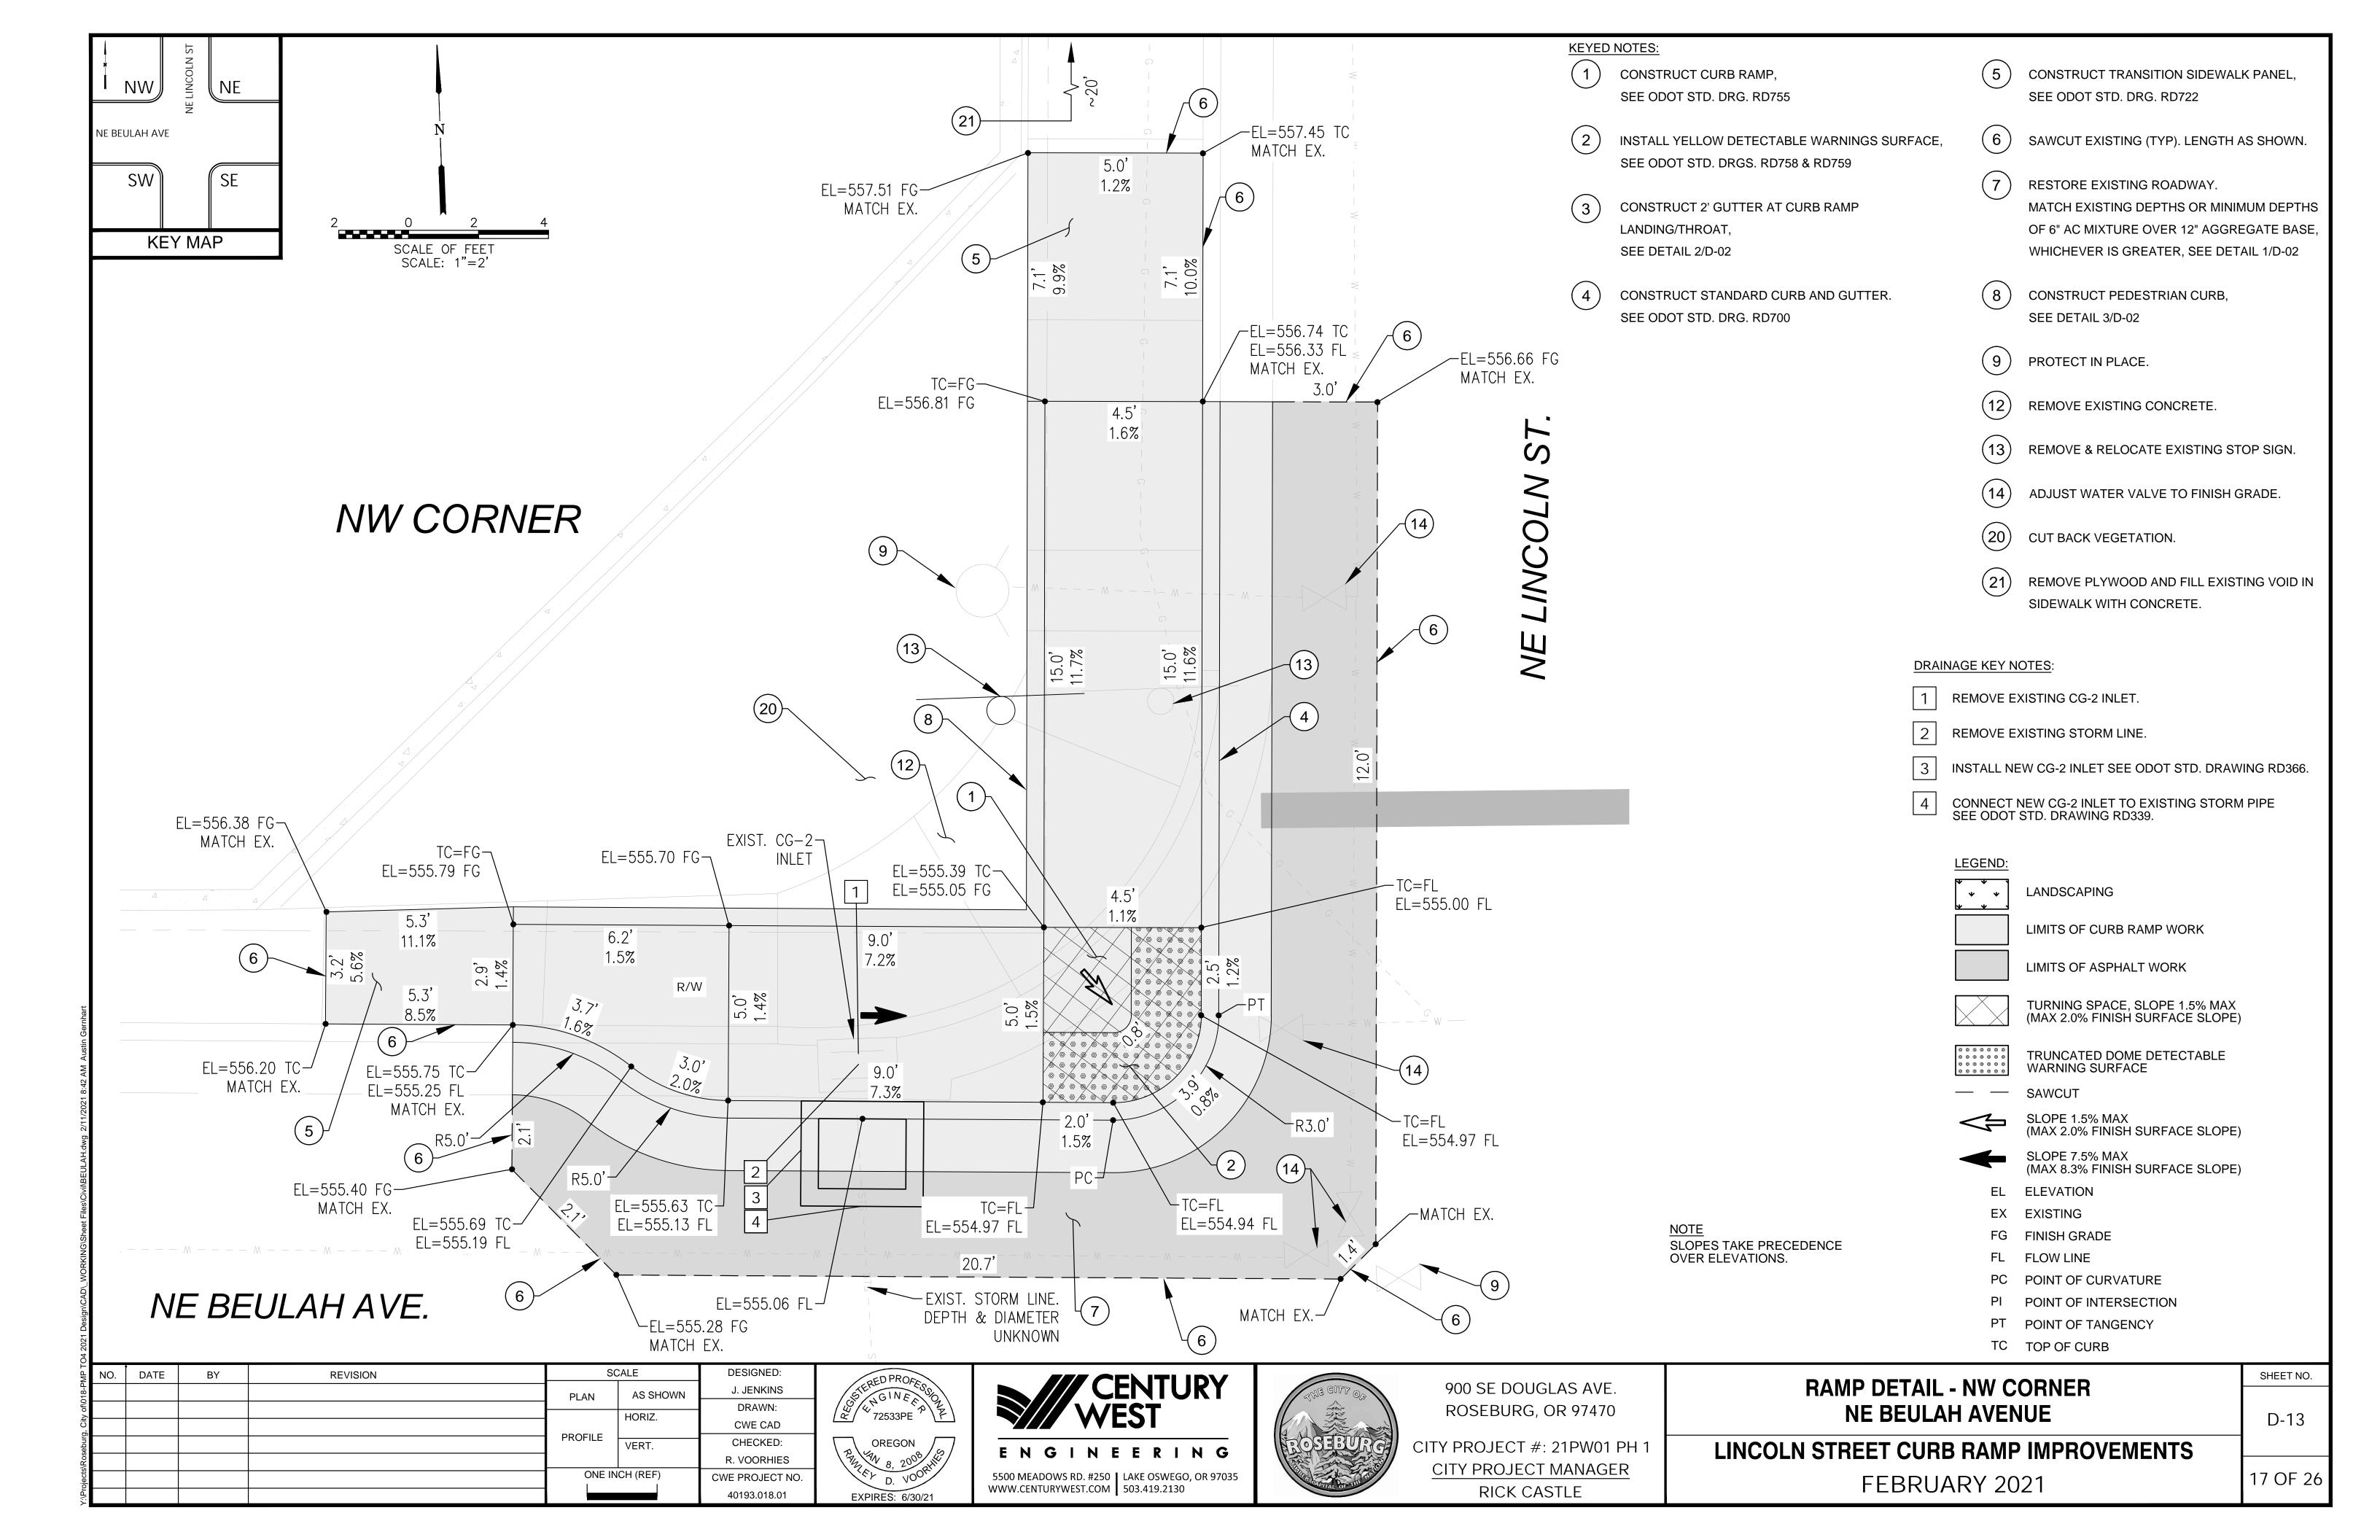- 1. SAWCUT 1' OFF EXISTING EDGE OF GUTTER.
- 2. CONSTRUCT CURB AND GUTTER PER ODOT STD. DRAWING
- 3. MATCH EXISTING GUTTER WIDTH.
- 4. CONTRACTOR TO CONSTRUCT TO EXISTING JOINTS WHEN APPARENT.
- 5. REPAIR LIMITS SHOWN ARE APPROXIMATE. CONSTRUCT CURB TO NECESSARY EXTENTS TO FULLY REPAIR DAMAGED SECTION AND/OR REMOVE UNUSED DRIVEWAY DROP.
- 6. RESTORE EXISTING ROADWAY. MATCH EXISTING DEPTHS OR MINIMUM DEPTHS OF 6" AC MIXTURE OVER 12" AGGREGATE BASE, WHICHEVER IS GREATER, SEE DETAIL 1/D-02.
- 7. RESTORE EXISTING LANDSCAPING USING 4" THICK BARK MULCH, 4" THICK CRUSHED ROCK OR SEEDING OVER 4" DEPTH TOPSOIL, WHICHEVER IS MOST APPROPRIATE TO MATCH EXISTING CONDITIONS.

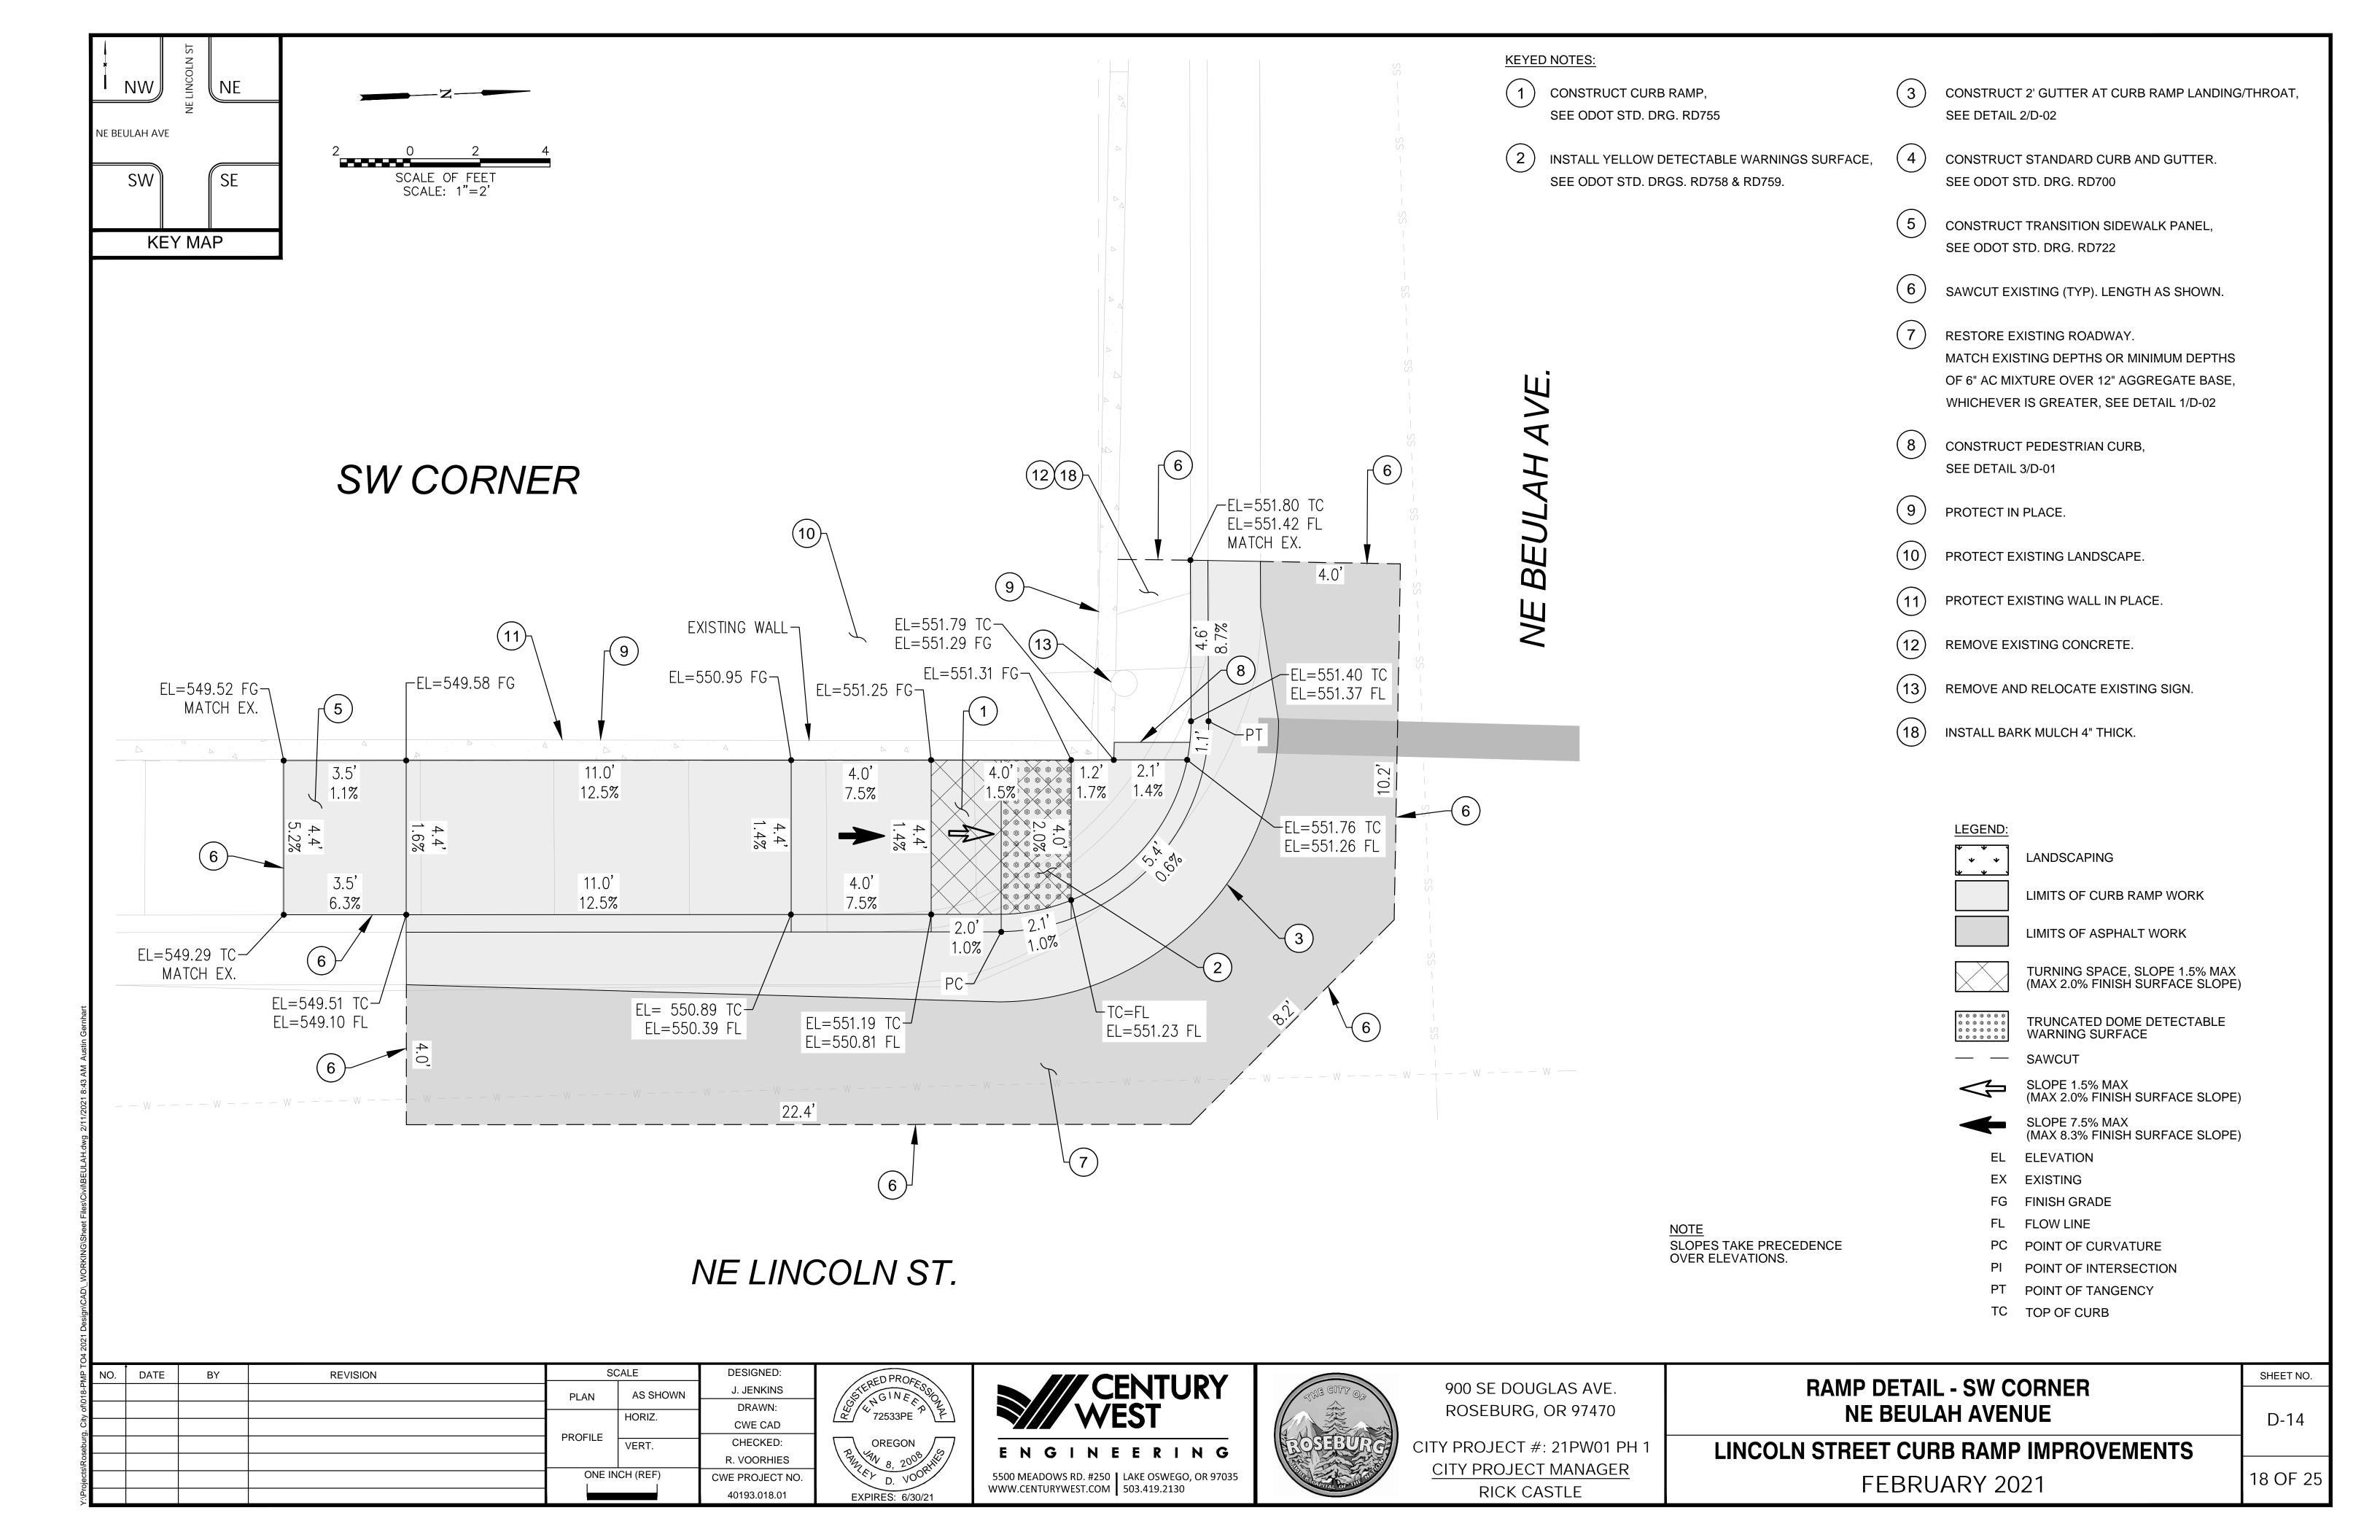







1258 NE LINCOLN ST 1 D-15




1158 NE LINCOLN ST 3
D-15

1105 NE LINCOLN ST 4
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900 SE DOUGLAS AVE. **ROSEBURG, OR 97470**


CITY PROJECT #: 21PW01 PH 1 **CITY PROJECT MANAGER RICK CASTLE**

LINCOLN STREET CURB RAMP IMPROVEMENTS **FEBRUARY 2021**

19 OF 26

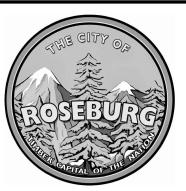
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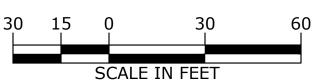
- 1. PROVIDE DRIVEWAY ACCESS AT ALL TIMES.
- 2. PROVIDE A 5' GAP BETWEEN TUBULAR MARKERS AT ALL CROSSING LOCATIONS.
- 3. SEE SHEET T7 FOR TEMPORARY SIGN DETAILS. SEE TM800, TM820, TM821, TM841, TM844 AND TM850 FOR STANDARD LANE CLOSURES, CROSSWALK CLOSURES AND TEMPORARY SIGN DETAILS NOT SHOWN ON PLANS.
- 4. SEE TM810, TM841, TM844, AND TM850 FOR STANDARD TEMPORARY PAVEMENT MARKINGS, AND FOR INTERSECTION AND TRAVEL LANE WORK ZONE DETAILS.
- 5. PLACE CHANNELIZING DEVICES AROUND INTERSECTION RADII AND CONSTRUCTION ACCESSES AT 10' SPACING.
- 6. LANE CLOSURES ALLOWED DURING DAYTIME WORK IN ACCORDANCE TO SECTION 00220 AND THE GENERAL NOTES.
- 7. MAINTAIN A MINIMUM OF TWO 10' TRAVEL LANES DURING CONSTRUCTION.
- 8. SEE SPECIFICATION SECTION 220 FOR ADDITIONAL LANE CLOSURE AND DETOUR INFORMATION PERTAINING TO PAVING AND PAVEMENT RESTORATION WORK.
- 9. LIMIT THE TIME ANY ADA RAMP IS CLOSED TO 10 CALENDAR DAYS.

TEMPORARY PEDESTRIAN ACCESSIBLE ROUTE NE LINCOLN ST. STAGE 1

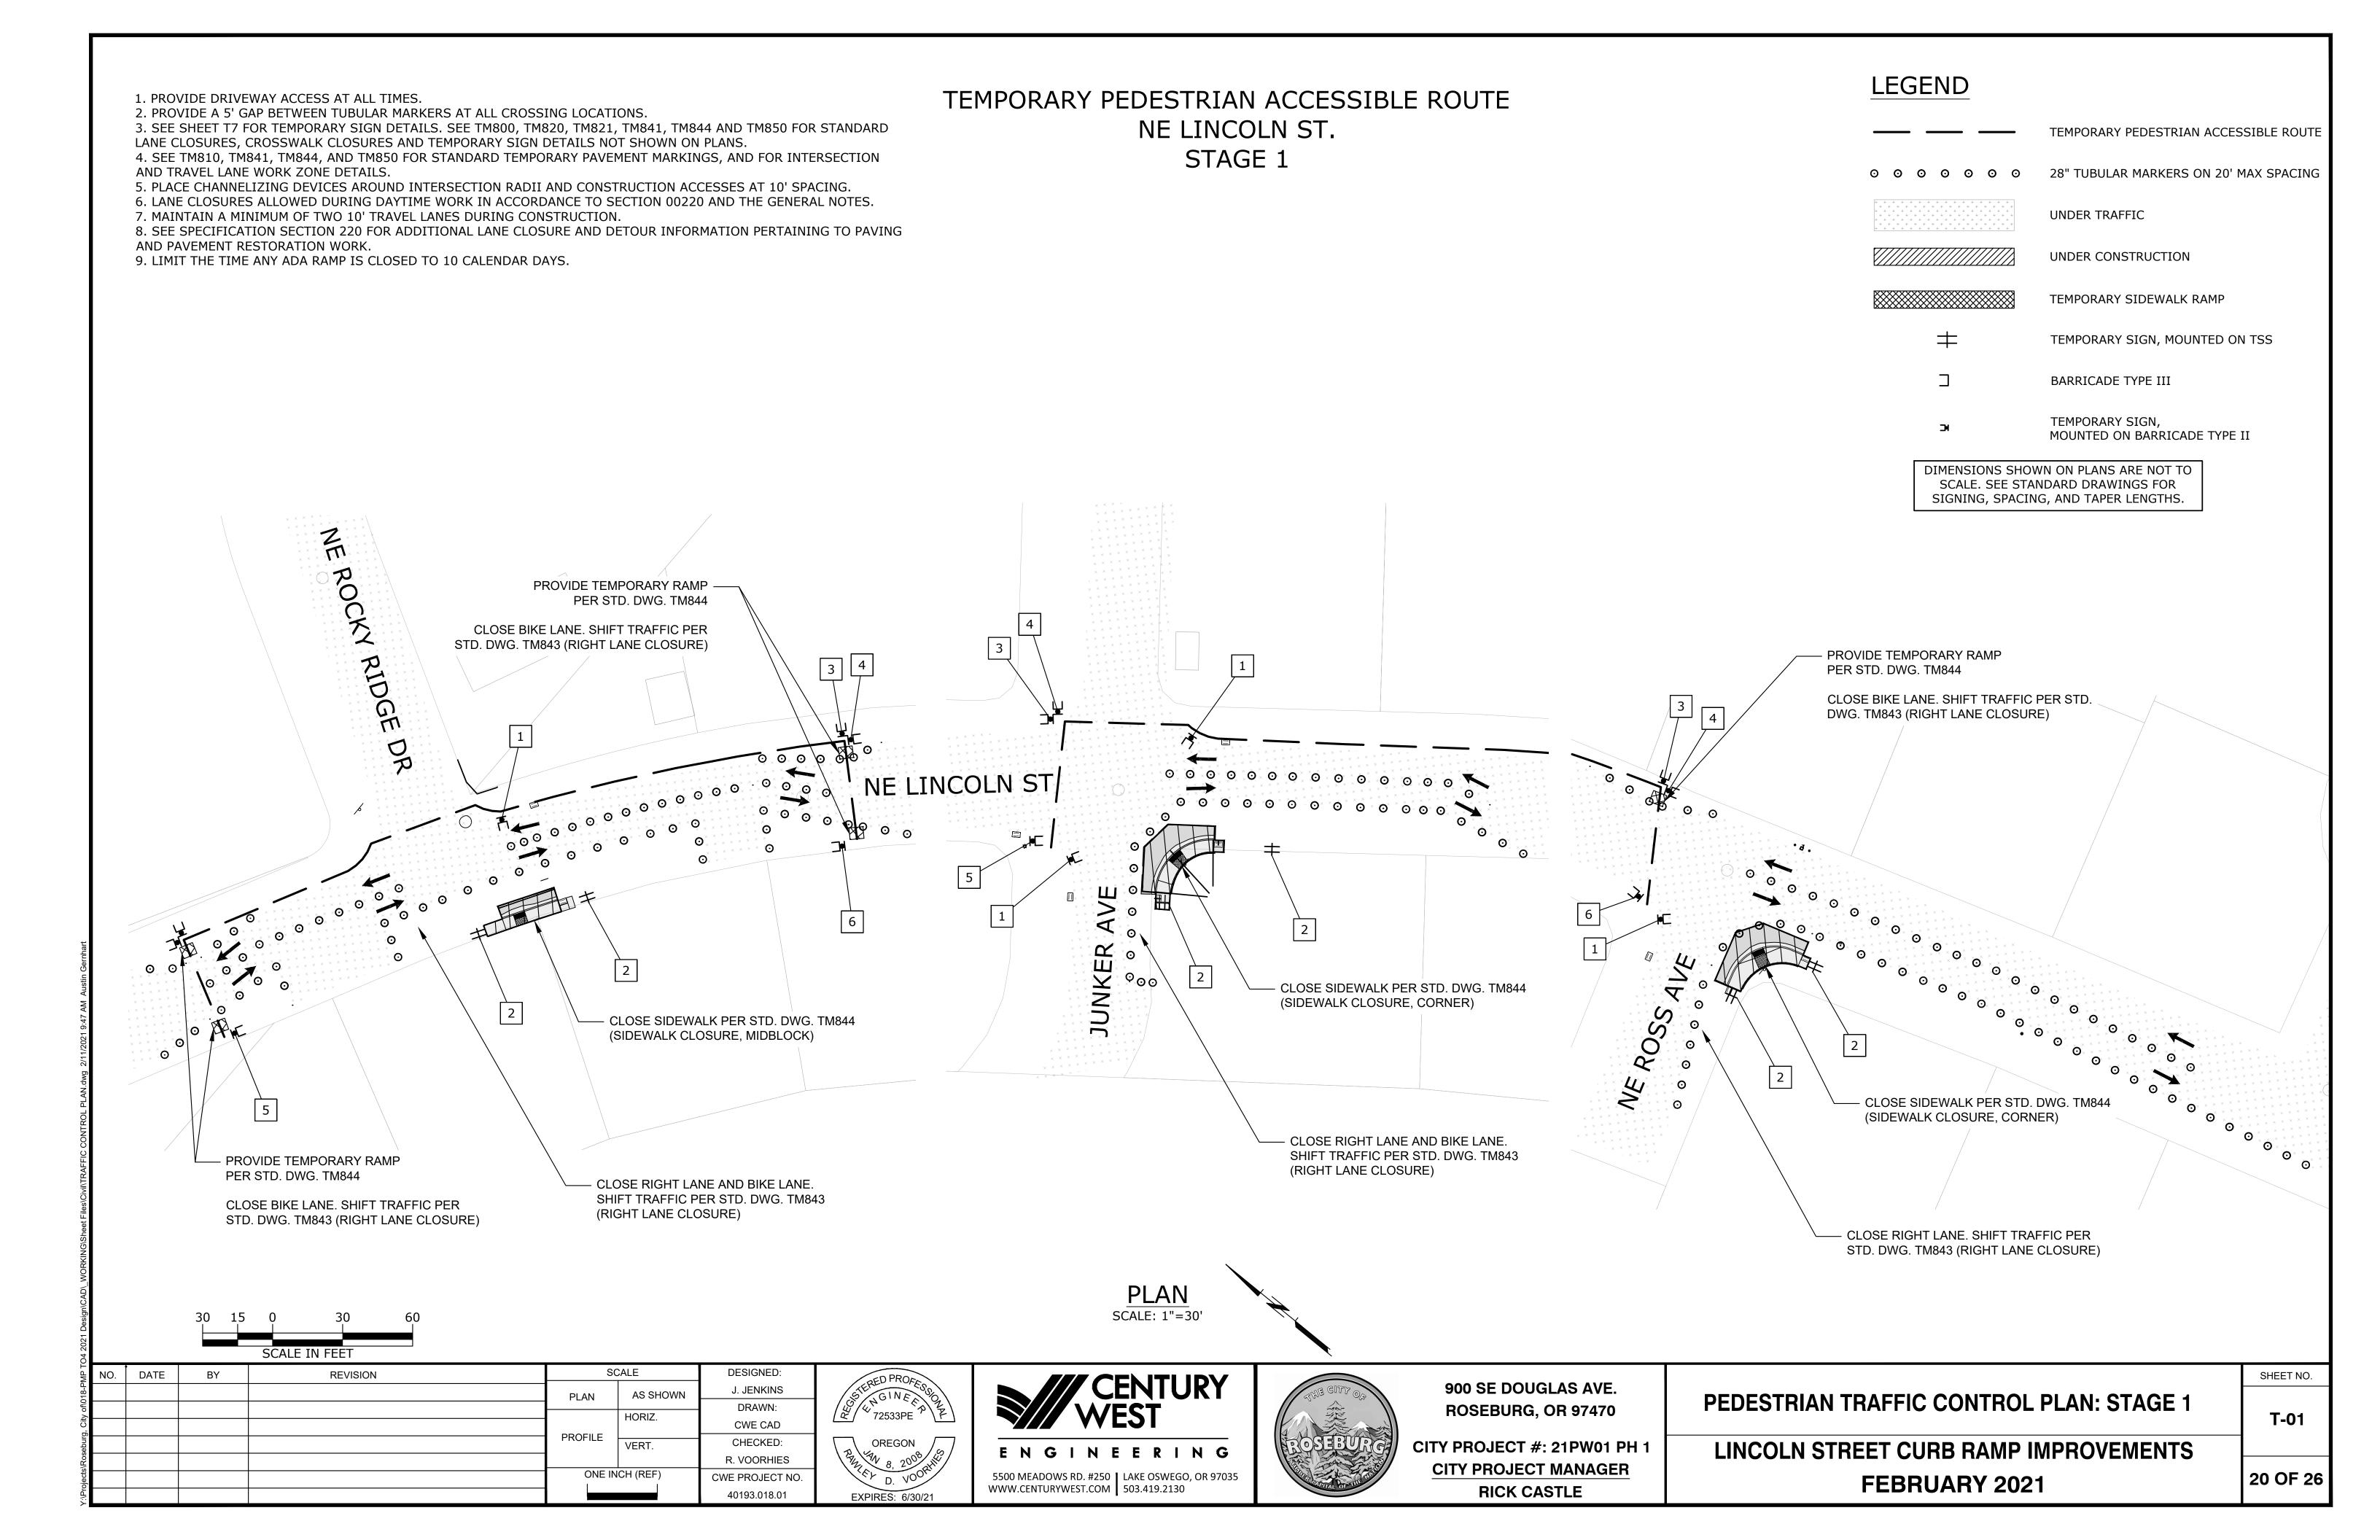


PLAN

SCALE: 1"=30'

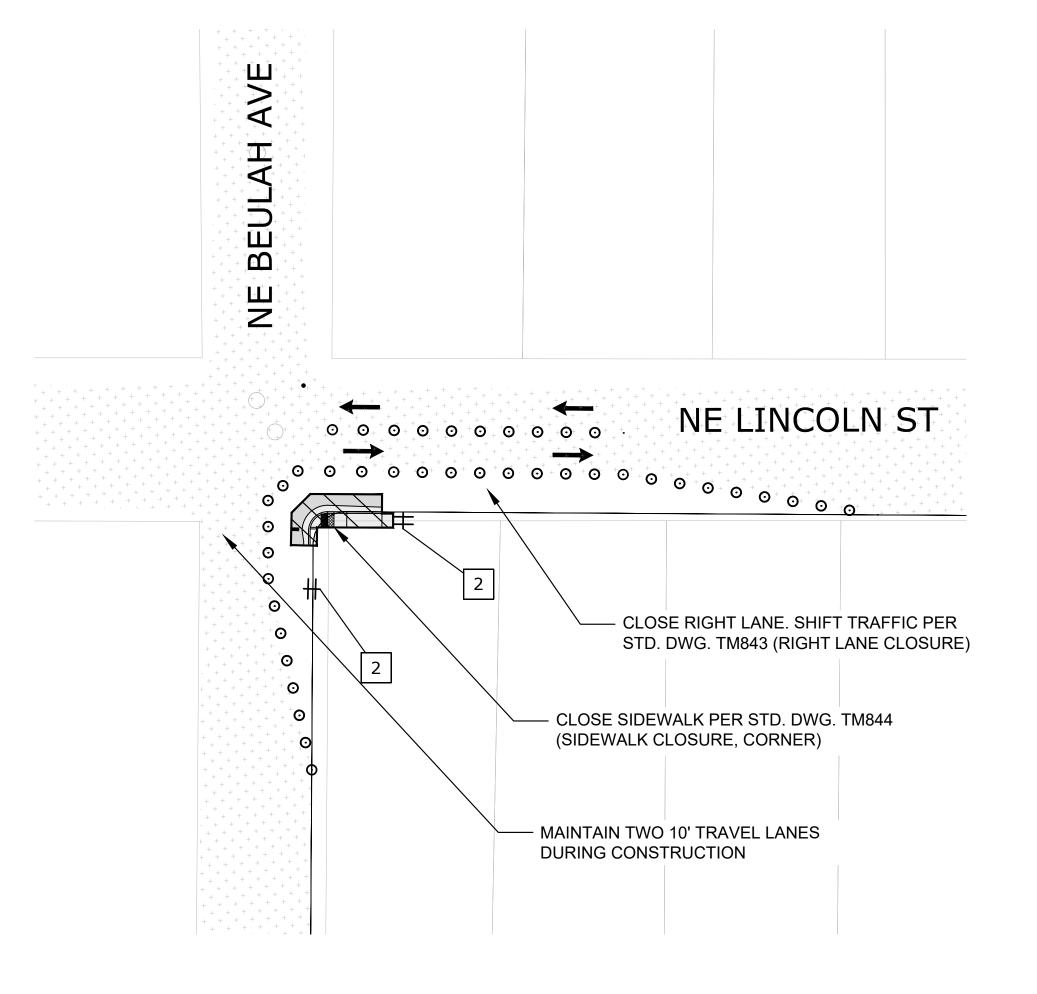

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900 SE DOUGLAS AVE. **ROSEBURG, OR 97470**

CITY PROJECT #: 21PW01 PH 1 **CITY PROJECT MANAGER RICK CASTLE**

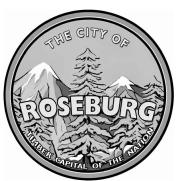LEGEND

TEMPORARY PEDESTRIAN ACCESSIBLE ROUTE

28" TUBULAR MARKERS ON 20' MAX SPACING

UNDER TRAFFIC

UNDER CONSTRUCTION

BARRICADE TYPE III

TEMPORARY SIGN,

DIMENSIONS SHOWN ON PLANS ARE NOT TO SCALE. SEE STANDARD DRAWINGS FOR SIGNING, SPACING, AND TAPER LENGTHS.

TEMPORARY SIDEWALK RAMP

TEMPORARY SIGN, MOUNTED ON TSS

MOUNTED ON BARRICADE TYPE II


LINCOLN STREET CURB RAMP IMPROVEMENTS **FEBRUARY 2021**

SHEET NO.
T-02

21 OF 26


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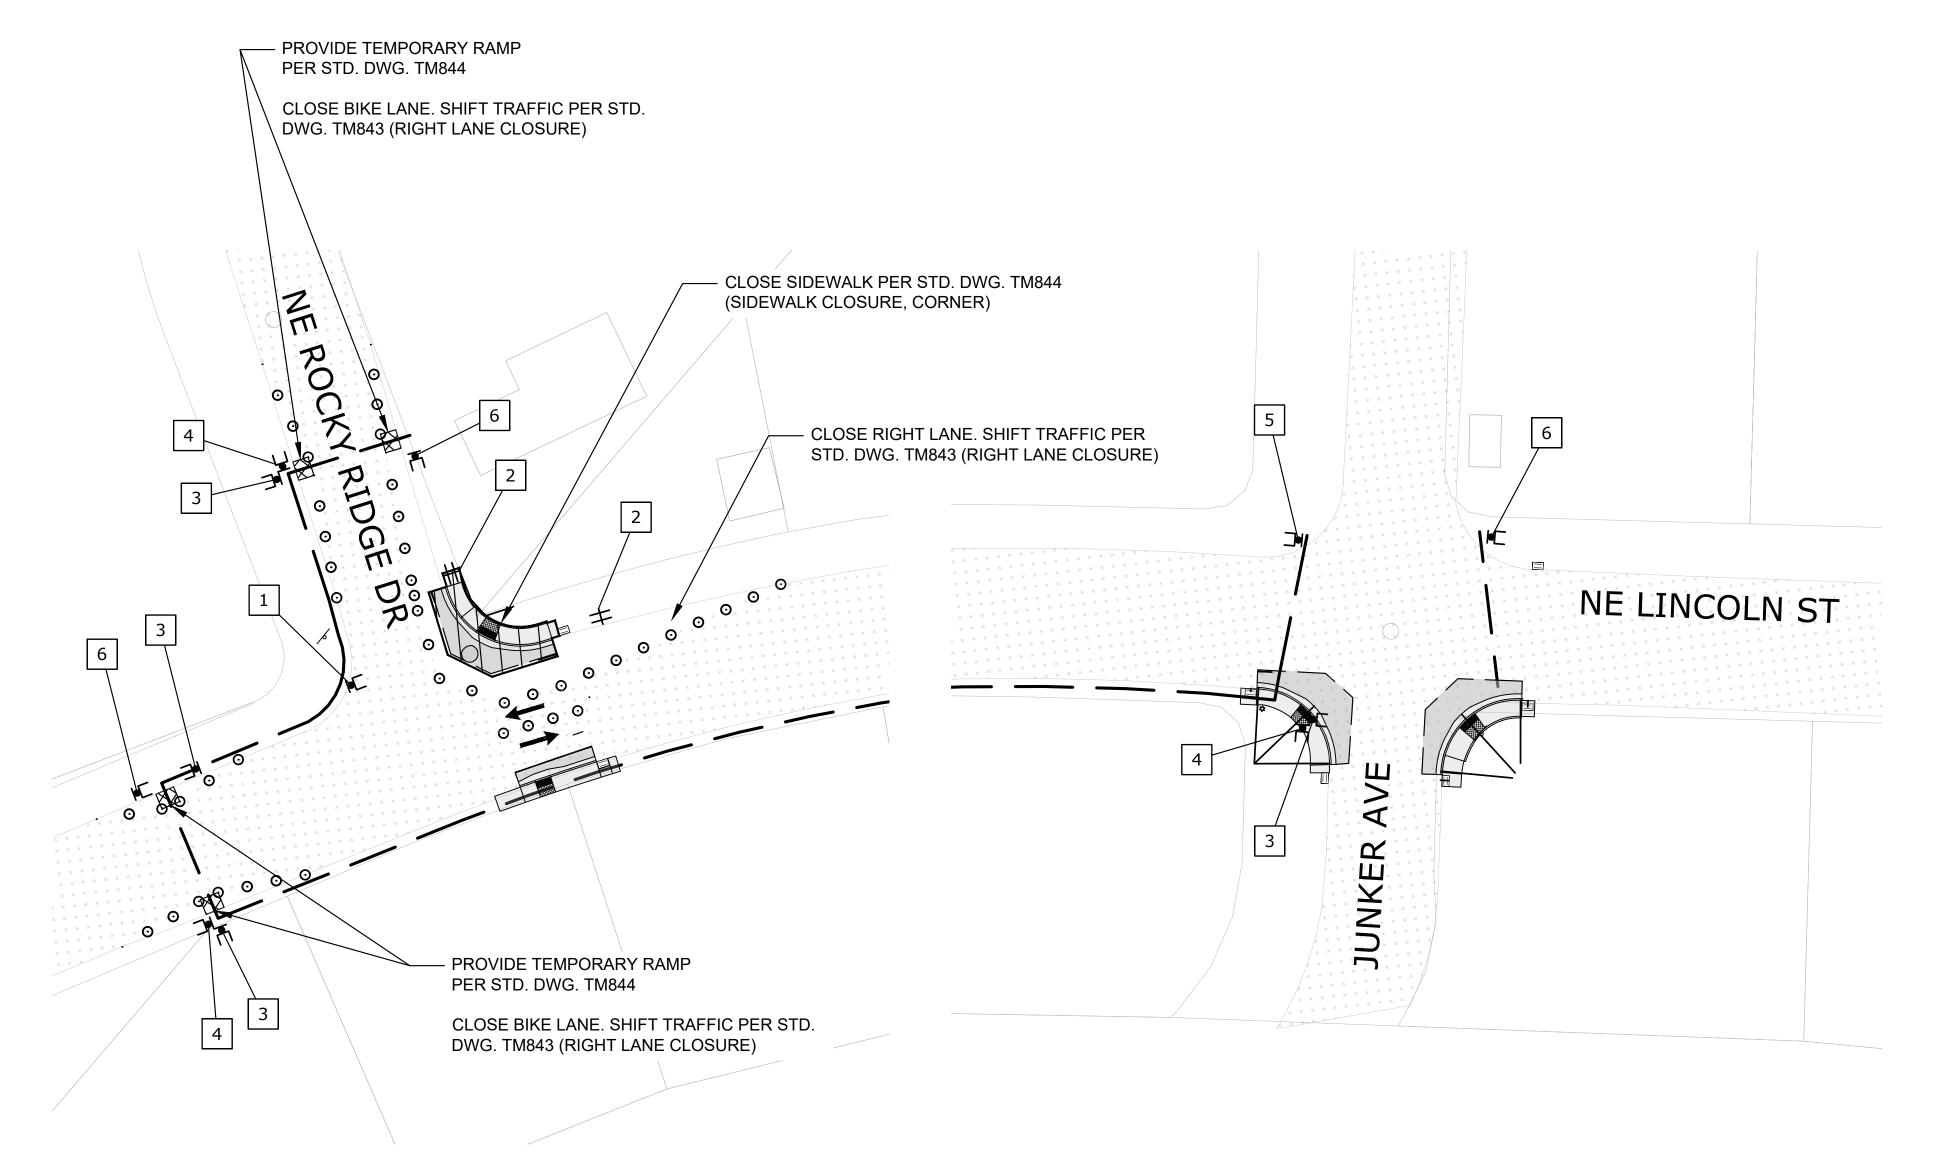


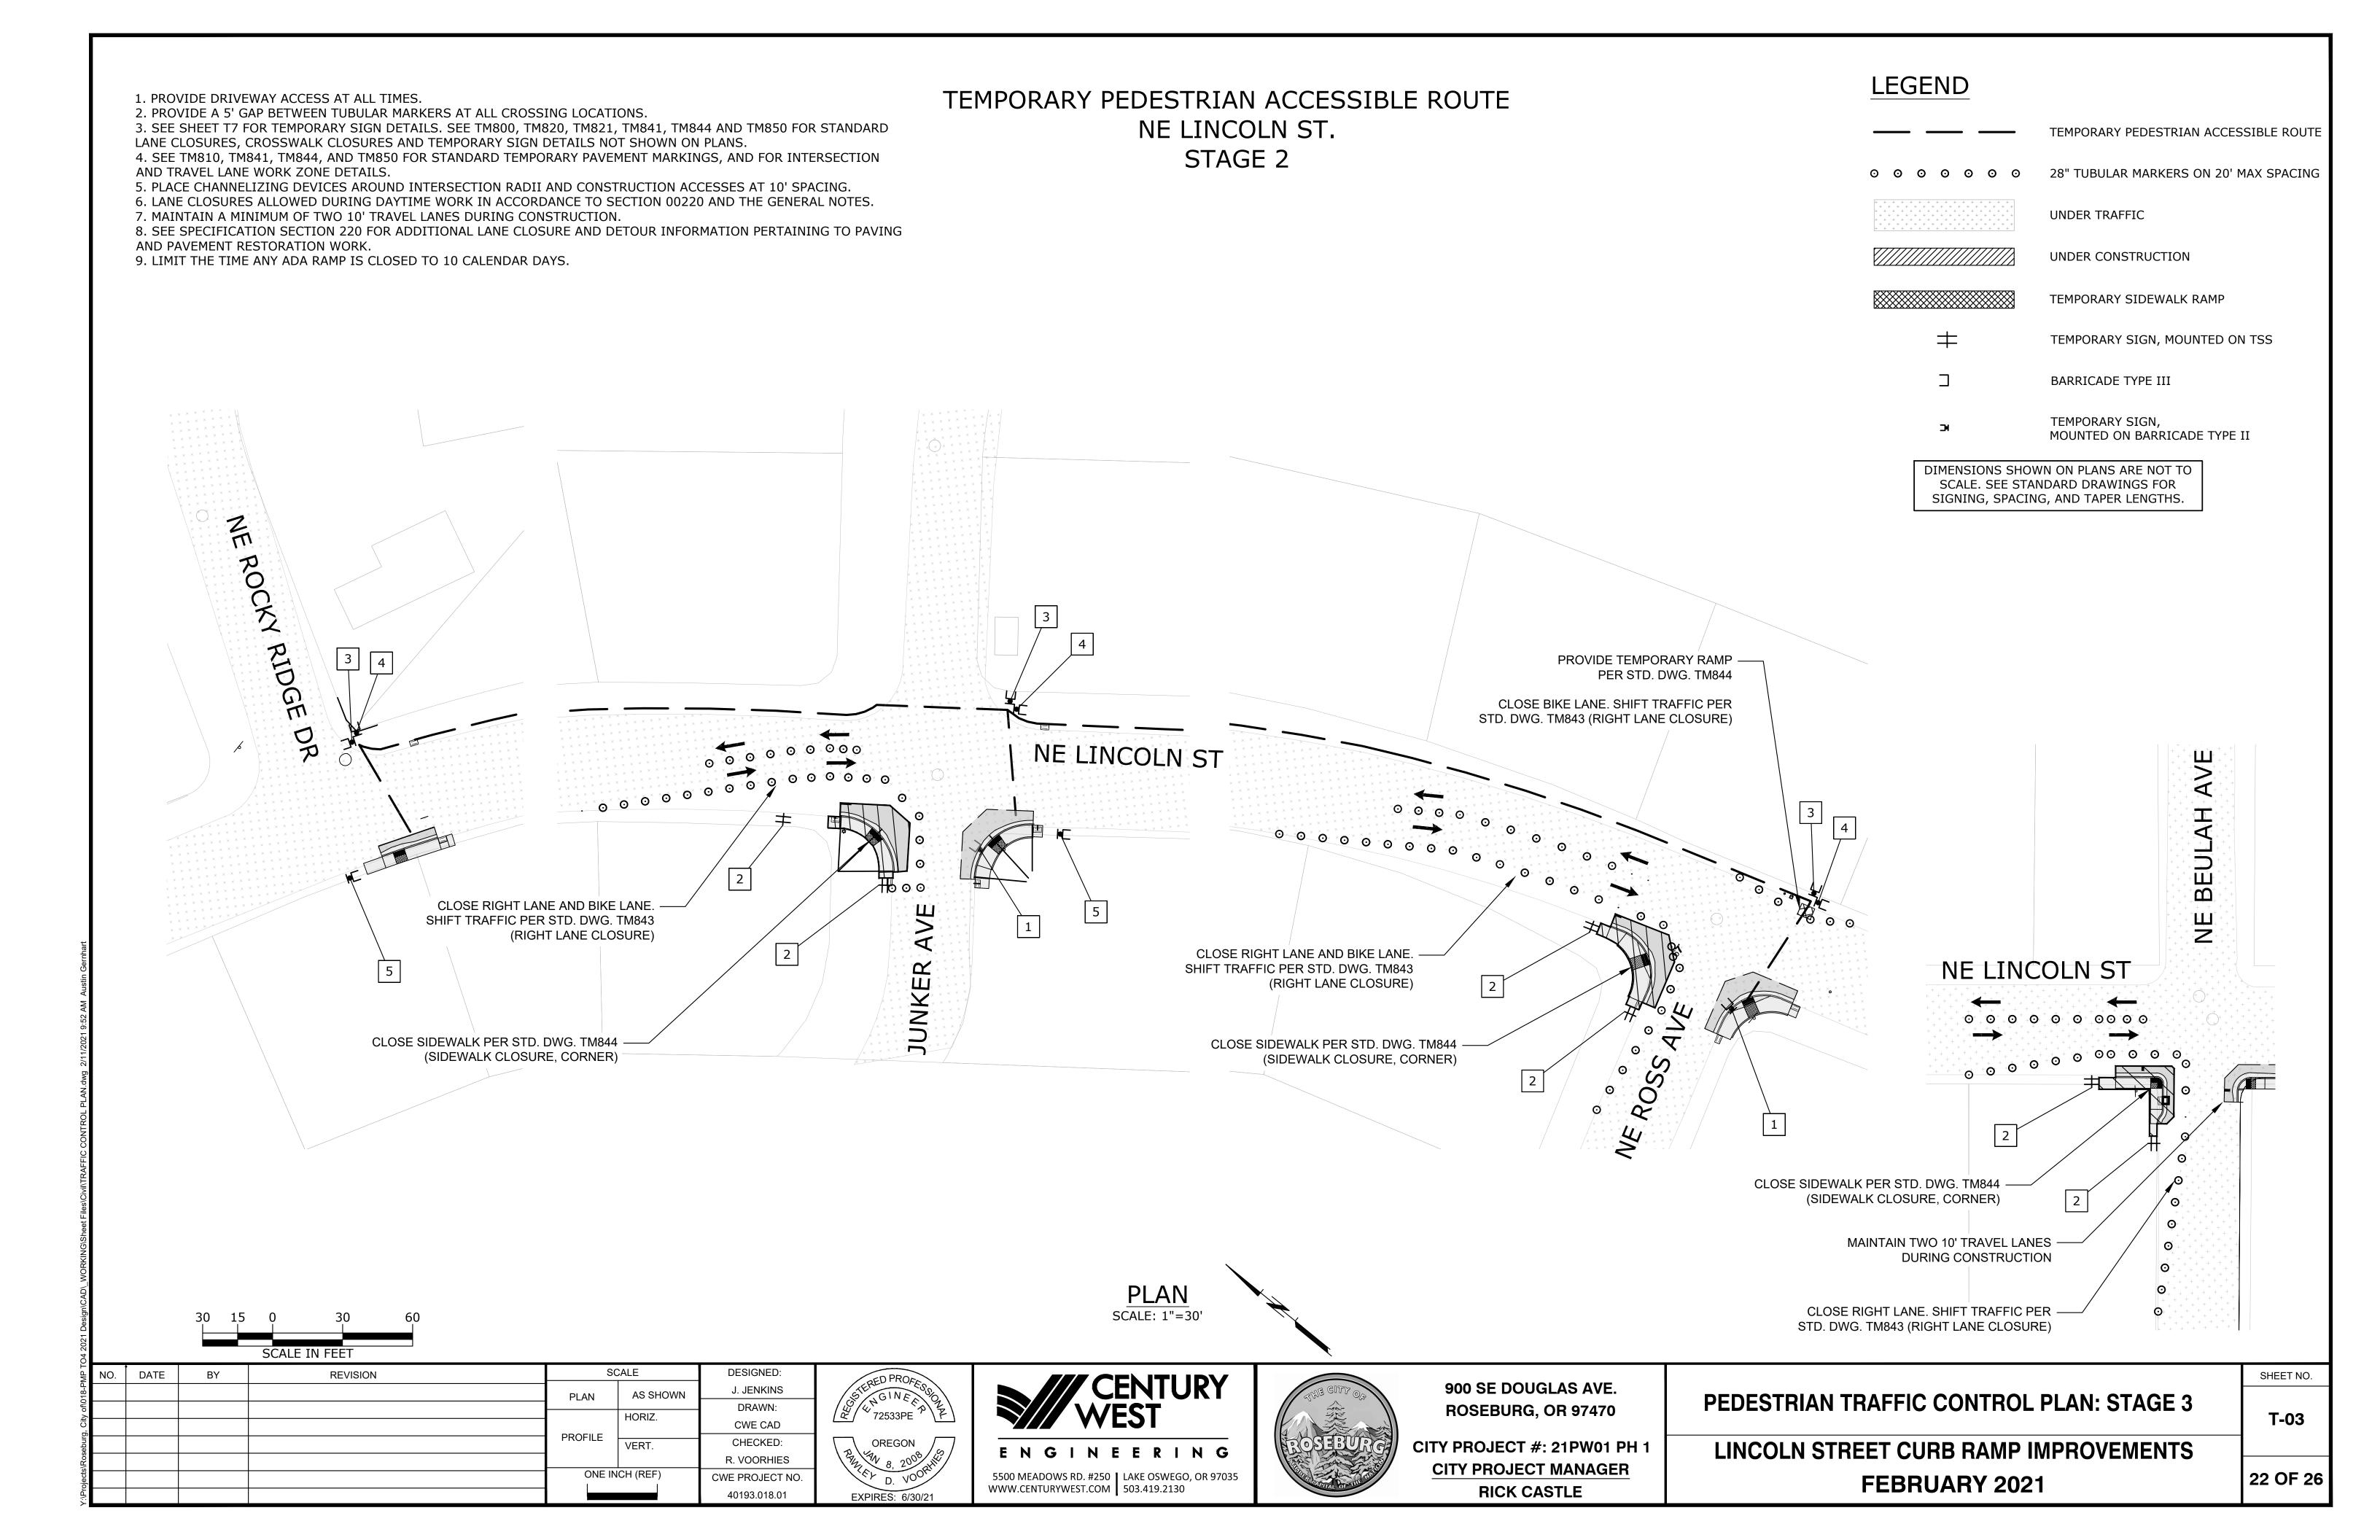


- 1. PROVIDE DRIVEWAY ACCESS AT ALL TIMES.
- 2. PROVIDE A 5' GAP BETWEEN TUBULAR MARKERS AT ALL CROSSING LOCATIONS.
- 3. SEE SHEET T7 FOR TEMPORARY SIGN DETAILS. SEE TM800, TM820, TM821, TM841, TM844 AND TM850 FOR STANDARD LANE CLOSURES, CROSSWALK CLOSURES AND TEMPORARY SIGN DETAILS NOT SHOWN ON PLANS.
- 4. SEE TM810, TM841, TM844, AND TM850 FOR STANDARD TEMPORARY PAVEMENT MARKINGS, AND FOR INTERSECTION AND TRAVEL LANE WORK ZONE DETAILS.
- 5. PLACE CHANNELIZING DEVICES AROUND INTERSECTION RADII AND CONSTRUCTION ACCESSES AT 10' SPACING.
- 6. LANE CLOSURES ALLOWED DURING DAYTIME WORK IN ACCORDANCE TO SECTION 00220 AND THE GENERAL NOTES.
- 7. MAINTAIN A MINIMUM OF TWO 10' TRAVEL LANES DURING CONSTRUCTION.
- 8. SEE SPECIFICATION SECTION 220 FOR ADDITIONAL LANE CLOSURE AND DETOUR INFORMATION PERTAINING TO PAVING AND PAVEMENT RESTORATION WORK.
- 9. LIMIT THE TIME ANY ADA RAMP IS CLOSED TO 10 CALENDAR DAYS.





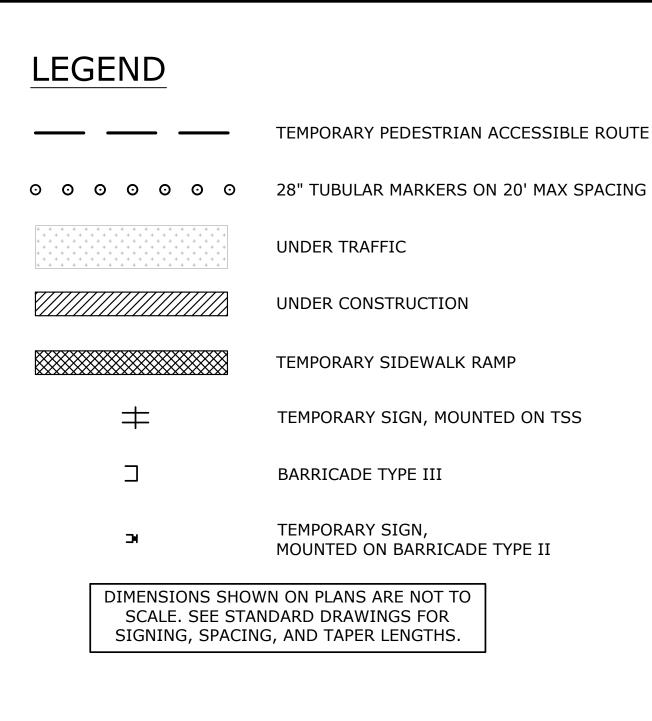

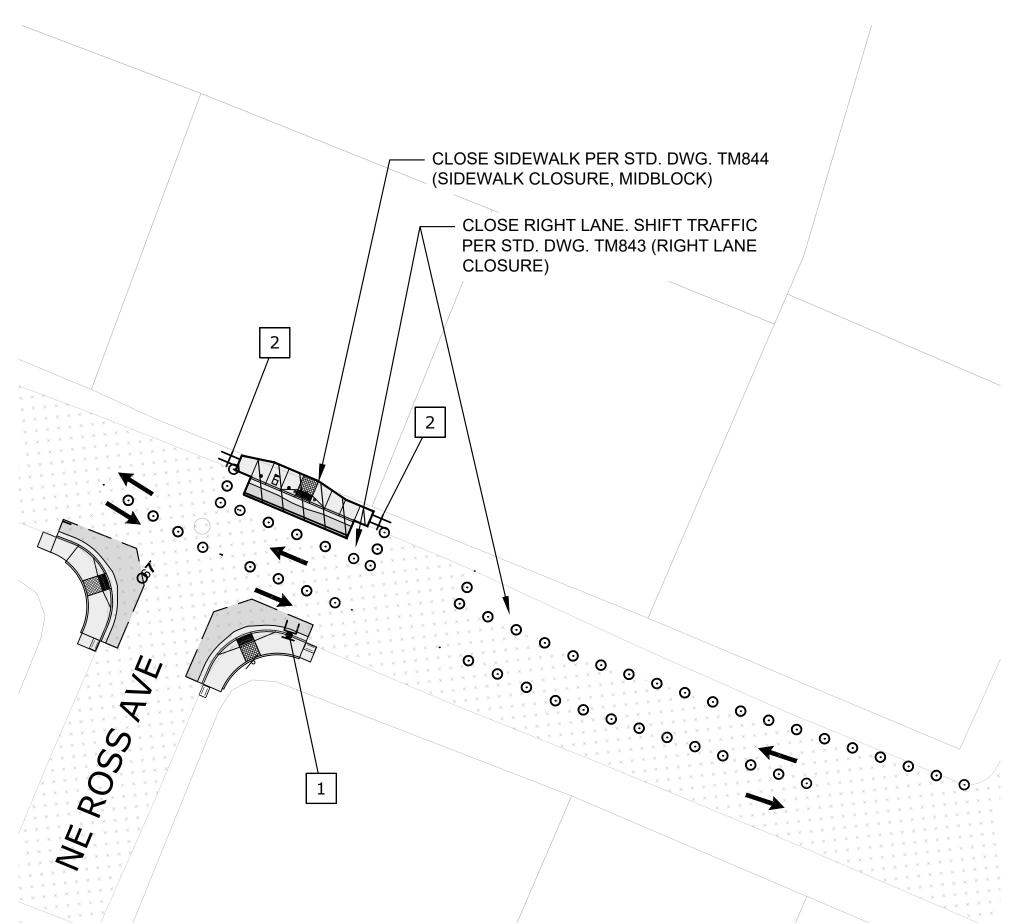


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PLAN

SCALE: 1"=30'



900 SE DOUGLAS AVE. ROSEBURG, OR 97470

CITY PROJECT #: 21PW01 PH 1
CITY PROJECT MANAGER
RICK CASTLE

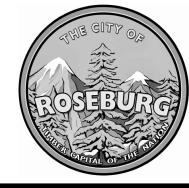PEDESTRIAN TRAFFIC CONTROL PLAN: STAGE 3


LINCOLN STREET CURB RAMP IMPROVEMENTS
FEBRUARY 2021

SHEET NO.

T-04

- 1. PROVIDE DRIVEWAY ACCESS AT ALL TIMES.
- 2. PROVIDE A 5' GAP BETWEEN TUBULAR MARKERS AT ALL CROSSING LOCATIONS.
- 3. SEE SHEET T7 FOR TEMPORARY SIGN DETAILS. SEE TM800, TM820, TM821, TM841, TM844 AND TM850 FOR STANDARD LANE CLOSURES, CROSSWALK CLOSURES AND TEMPORARY SIGN DETAILS NOT SHOWN ON PLANS.
- 4. SEE TM810, TM841, TM844, AND TM850 FOR STANDARD TEMPORARY PAVEMENT MARKINGS, AND FOR INTERSECTION AND TRAVEL LANE WORK ZONE DETAILS.
- 5. PLACE CHANNELIZING DEVICES AROUND INTERSECTION RADII AND CONSTRUCTION ACCESSES AT 10' SPACING.
- 6. LANE CLOSURES ALLOWED DURING DAYTIME WORK IN ACCORDANCE TO SECTION 00220 AND THE GENERAL NOTES.
- 7. MAINTAIN A MINIMUM OF TWO 10' TRAVEL LANES DURING CONSTRUCTION.
- 8. SEE SPECIFICATION SECTION 220 FOR ADDITIONAL LANE CLOSURE AND DETOUR INFORMATION PERTAINING TO PAVING AND PAVEMENT RESTORATION WORK.
- 9. LIMIT THE TIME ANY ADA RAMP IS CLOSED TO 10 CALENDAR DAYS.



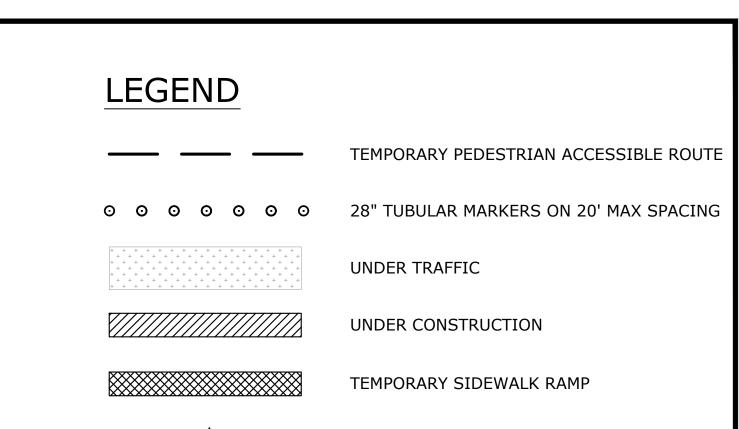


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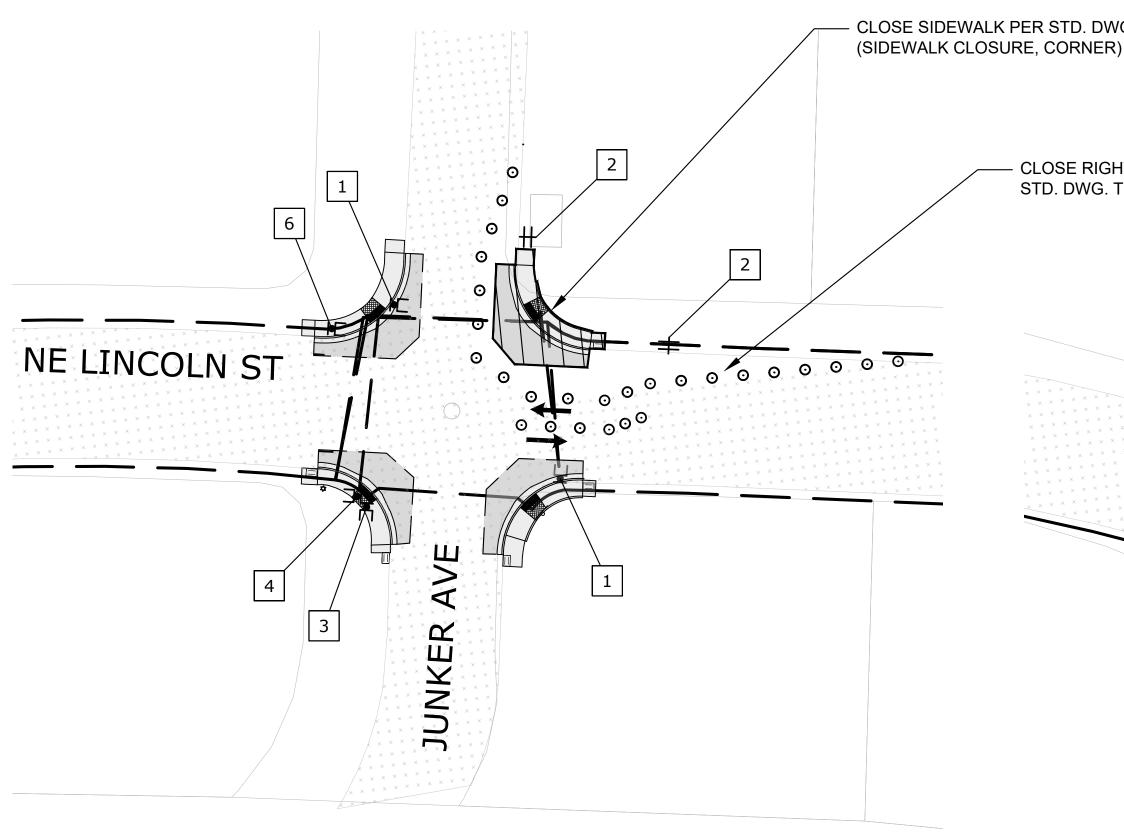
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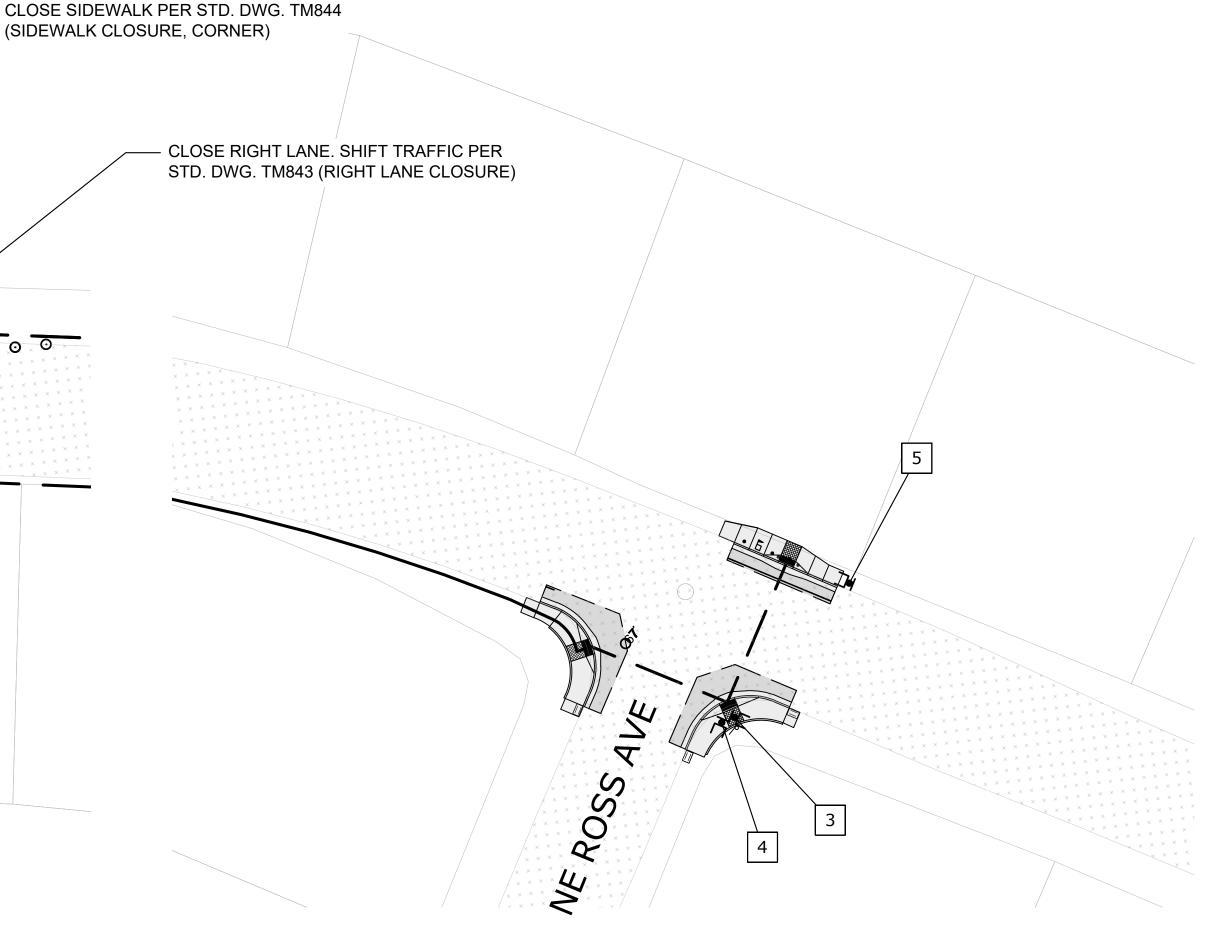
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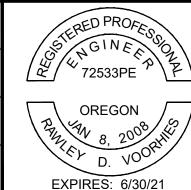
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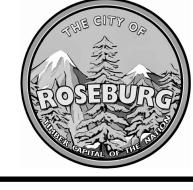


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PLAN

SCALE: 1"=30'



900 SE DOUGLAS AVE. ROSEBURG, OR 97470

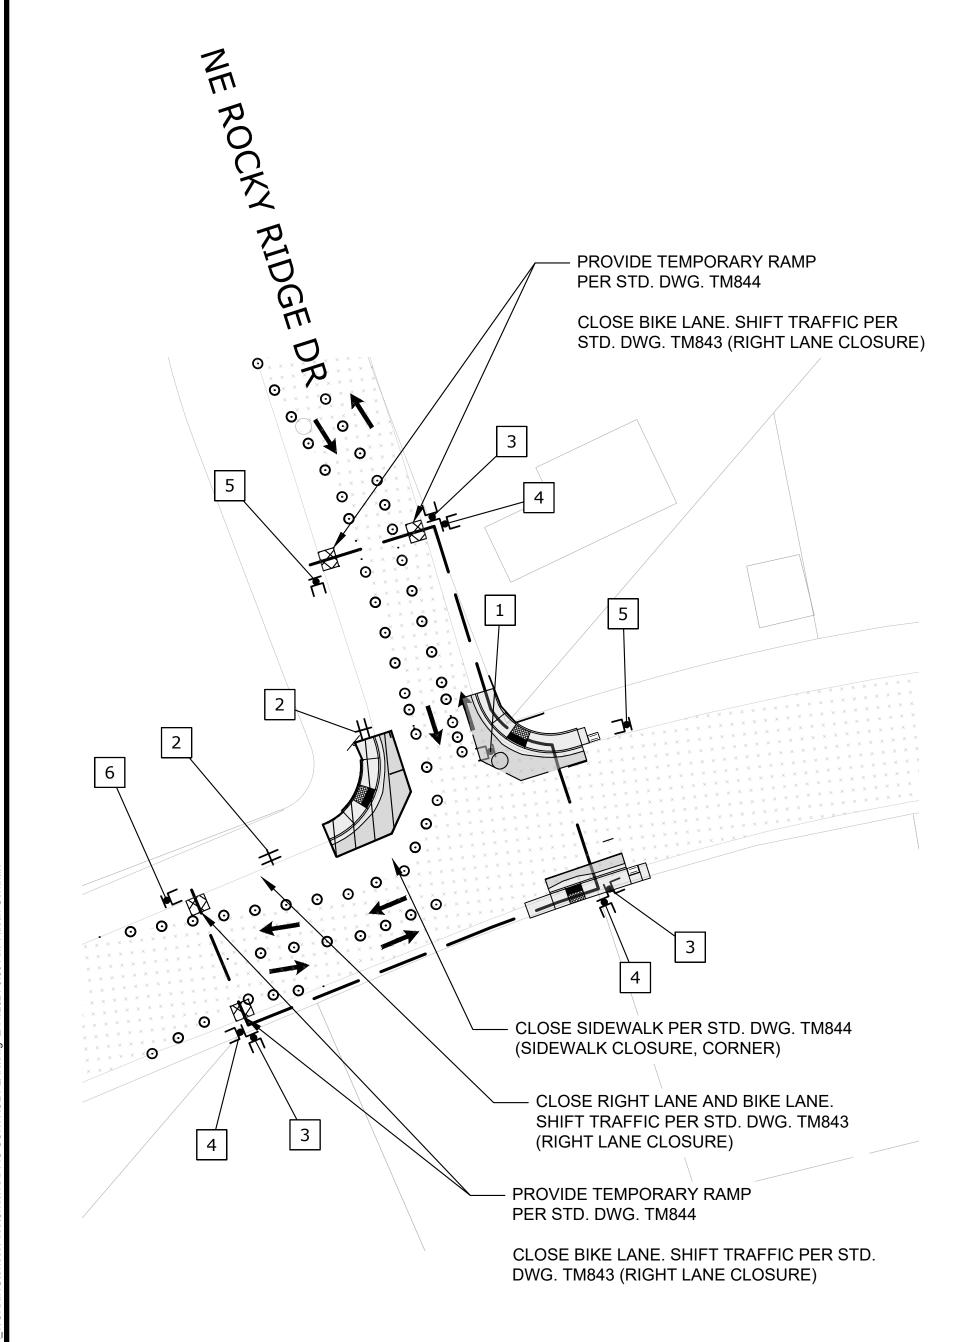CITY PROJECT #: 21PW01 PH 1

CITY PROJECT MANAGER

RICK CASTLE

PEDESTRIAN TRAFFIC CONTROL PLAN: STAGE 5

LINCOLN STREET CURB RAMP IMPROVEMENTS
FEBRUARY 2021

SHEET NO.

T-05

- 1. PROVIDE DRIVEWAY ACCESS AT ALL TIMES.
- 2. PROVIDE A 5' GAP BETWEEN TUBULAR MARKERS AT ALL CROSSING LOCATIONS.
- 3. SEE SHEET T7 FOR TEMPORARY SIGN DETAILS. SEE TM800, TM820, TM821, TM841, TM844 AND TM850 FOR STANDARD LANE CLOSURES, CROSSWALK CLOSURES AND TEMPORARY SIGN DETAILS NOT SHOWN ON PLANS.
- 4. SEE TM810, TM841, TM844, AND TM850 FOR STANDARD TEMPORARY PAVEMENT MARKINGS, AND FOR INTERSECTION AND TRAVEL LANE WORK ZONE DETAILS.
- 5. PLACE CHANNELIZING DEVICES AROUND INTERSECTION RADII AND CONSTRUCTION ACCESSES AT 10' SPACING.
- 6. LANE CLOSURES ALLOWED DURING DAYTIME WORK IN ACCORDANCE TO SECTION 00220 AND THE GENERAL NOTES.
- 7. MAINTAIN A MINIMUM OF TWO 10' TRAVEL LANES DURING CONSTRUCTION.
- 8. SEE SPECIFICATION SECTION 220 FOR ADDITIONAL LANE CLOSURE AND DETOUR INFORMATION PERTAINING TO PAVING AND PAVEMENT RESTORATION WORK.
- 9. LIMIT THE TIME ANY ADA RAMP IS CLOSED TO 10 CALENDAR DAYS.

TEMPORARY PEDESTRIAN ACCESSIBLE ROUTE NE LINCOLN ST. STAGE 5

<u>LEGEND</u>

TEMPORARY PEDESTRIAN ACCESSIBLE ROUTE

 \circ \circ \circ \circ \circ

28" TUBULAR MARKERS ON 20' MAX SPACING

UNDER TRAFFIC

UNDER CONSTRUCTION


TEMPORARY SIDEWALK RAMP


TEMPORARY SIGN, MOUNTED ON TSS

BARRICADE TYPE III

TEMPORARY SIGN,
MOUNTED ON BARRICADE TYPE II

DIMENSIONS SHOWN ON PLANS ARE NOT TO SCALE. SEE STANDARD DRAWINGS FOR SIGNING, SPACING, AND TAPER LENGTHS.

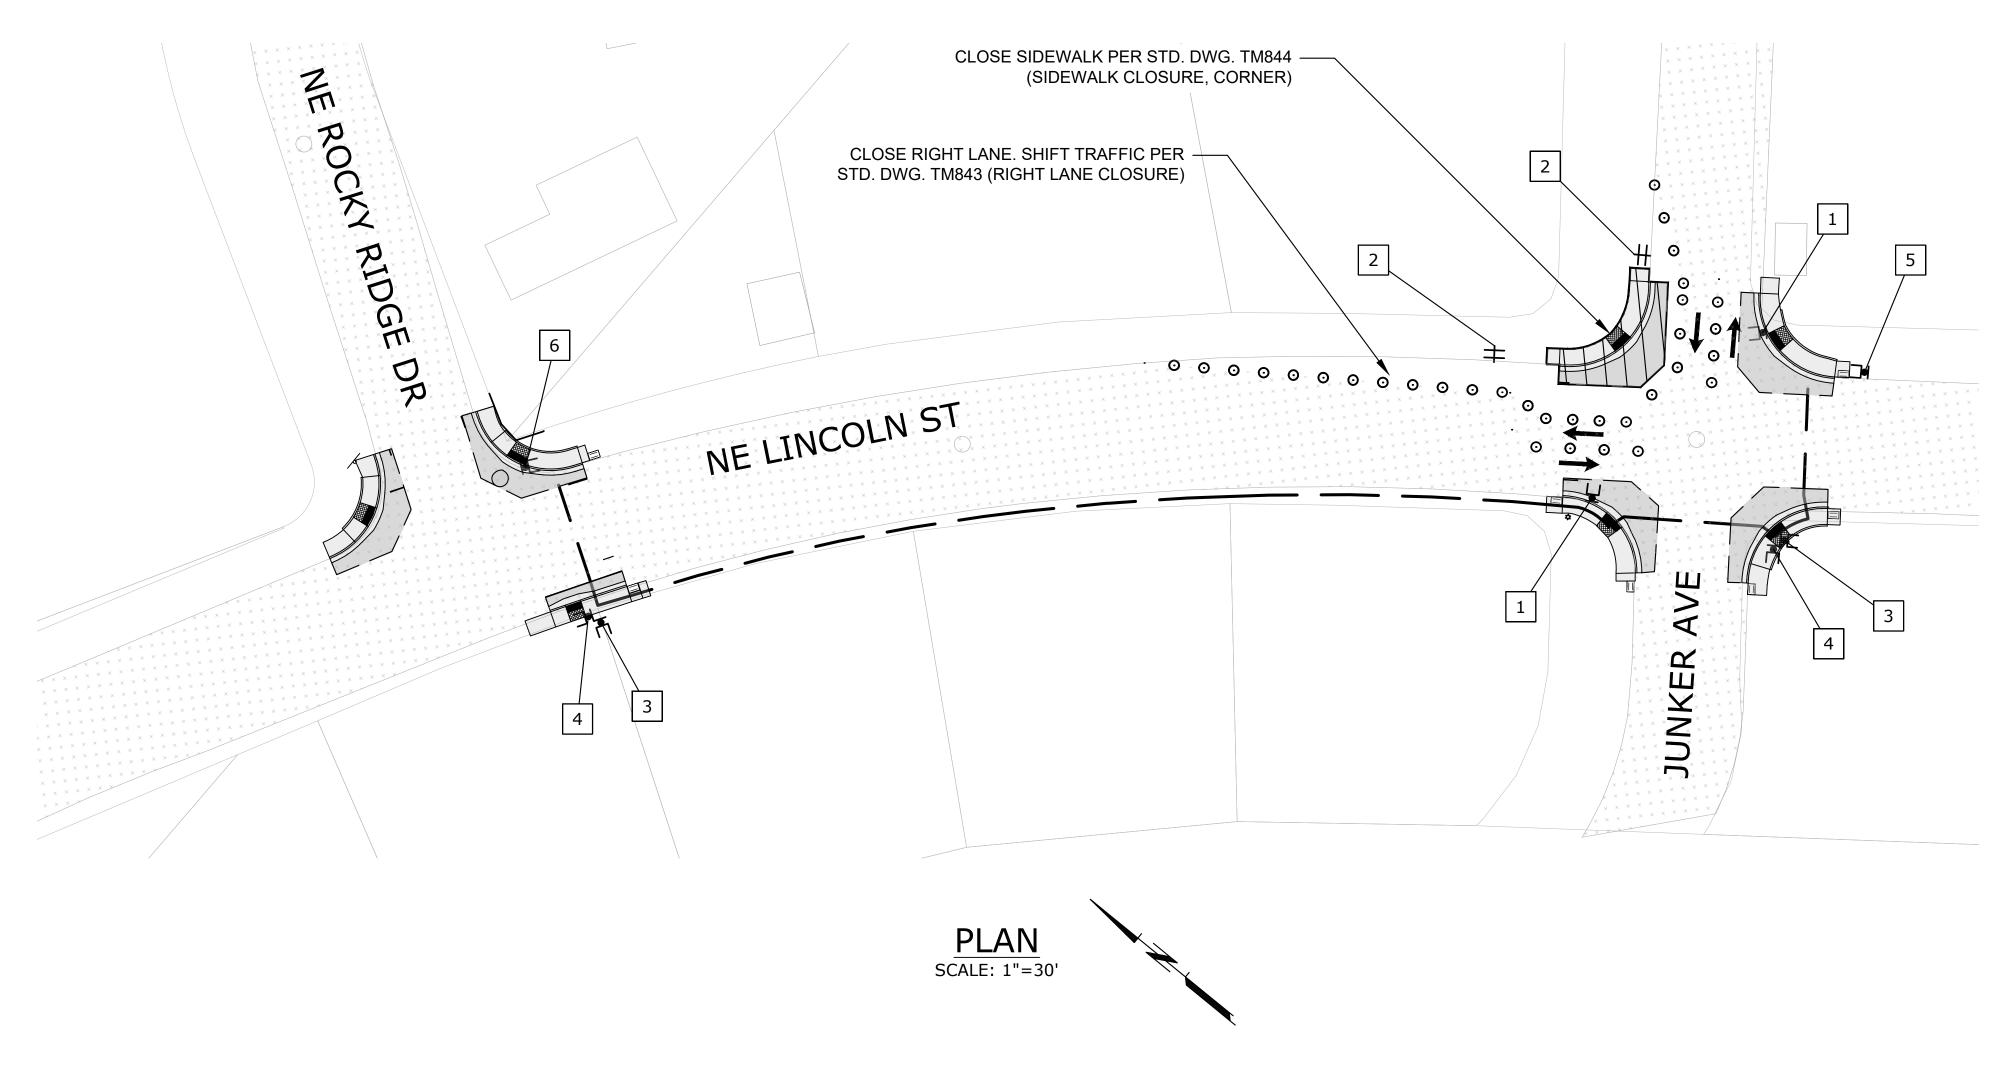

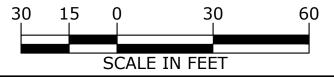

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CITY PROJECT #: 21PW01 PH 1
CITY PROJECT MANAGER
RICK CASTLE

PEDESTRIAN TRAFFIC CONTROL PLAN: STAGE 6

LINCOLN STREET CURB RAMP IMPROVEMENTS
FEBRUARY 2021


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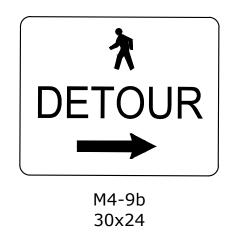




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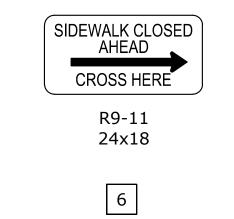


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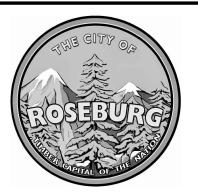


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900 SE DOUGLAS AVE. ROSEBURG, OR 97470

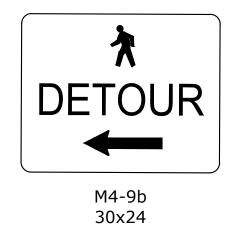CITY PROJECT #: 21PW01 PH 1

CITY PROJECT MANAGER

RICK CASTLE

TEMPORARY SIGN DETAILS	

LINCOLN STREET CURB RAMP IMPROVEMENTS
FEBRUARY 2021

26 OF 26

SHEET NO.

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LAN.dwg 2/11/2021 10:06 AM Austin Gernhart