

ABBREVIATIONS

| ARRKEAT | ATIONS | | |
|----------------|---------------------------------------|-----------------|---|
| @ | AT | HMAC | HOT MIX ASPHALT CONCRETE |
| ABAN | ABANDON(ED) | HDPE | HIGH DENSITY POLYETHYLENE |
| AC | ASPHALTIC CONCRETE | HORIZ | HORIZONTAL |
| ACP | ASPHALTIC CONCRETE PAVEMENT | HWY | HIGHWAY |
| ADWF | AVERAGE DRY WEATHER FLOW | HP | HIGH PRESSURE |
| AGG | AGGREGATE | | |
| AL | ALUMINUM | ID | IDENTIFICATION/INSIDE DIAMETER |
| ANSI APPROX | AMERICAN NATIONAL STANDARDS INSTITUTE | IE IH | INVERT ELEVATION IRRIGATION HEAD |
| APPVD | APPROXIMATE(LY) APPROVED | INSTL | INSTALL |
| APWA | AMERICAN PUBLIC WORKS ASSOCIATION | IR | IRON ROD |
| ASSY | ASSEMBLY | 110 | INON NOD |
| ARV | AIR RELEASE VALVE | LAT | LATERAL |
| AVE | AVENUE | LF | LINEAR FEET |
| AWWA | AMERICAN WATER WORKS ASSOCIATION | LN | LANE |
| | | LP | LOW PRESSURE |
| BFILL | BACKFILL | LS | LONG SLEEVE |
| BLDG BLVD | BUILDING BOULEVARD | LT | LEFT |
| BM | BENCHMARK | MAINT | MAINTAIN |
| BTM | BOTTOM | MATL(S) | MATERIAL(S) |
| BETW | BETWEEN | MAX | MAXIMUM |
| | | MFR(S) | MANUFACTURER('S) |
| C/L | CENTER LINE | MH(S) | MANHOLE(S) |
| СВ | CATCH BASIN | MHMAC | MINOR HOT MIX ASPHALT CONCRETE |
| CCTV | CLOSED CIRCUIT TELEVISION | MIN | MINIMUM |
| CDF | CONTROLLED DENSITY FILL | M) | MECHANICAL JOINT |
| CI CIPP | CAST IRON CURED IN PLACE PIPE | MON(S) MUTCD | MONUMENT(S) MANUAL ON UNIFORM TRAFFIC CONTROL DEVICES |
| CG | CURB/GUTTER | MOTED | MANDAL ON UNITORM TRAITIC CONTROL DEVICES |
| CL | CLASS | NB | NORTHBOUND |
| CLR | CLEAR | NO | NUMBER |
| CLSM | CONTROLLED LOW STRENGTH MATERIAL | NOM | NOMINAL |
| CND | CONDUIT | NTS | NOT TO SCALE |
| CO | CLEANOUT | | |
| COMM | COMMUNICATIONS | 00 | ON CENTER |
| CONC CONN | CONCRETE CONNECTION | OD ODOT | OUTSIDE DIAMETER OREGON DEPARTMENT OF TRANSPORTATION |
| CONST | CONSTRUCT/CONSTRUCTION | OVHD | OVERHEAD LINE |
| COORD | COORDINATE | OVIID | OVERHER EINE |
| COP | COPPER | Р | POWER |
| COR | CITY OF ROSEBURG | PC | POINT OF CURVATURE |
| CP | CONCRETE PIPE | PCC | POINT OF COMPOUND CURVATURE |
| CPLG | COUPLING | PCMS | PORTABLE CHANGEABLE MESSAGE SIGN |
| CR | CRUSHED ROCK | PCVC | POINT OF CURVATURE ON VERTICAL CURVE |
| CT CHKV | COURT CHECK VALVE | PE PERF | PLAIN END PERFORATED |
| CHKV | CUBIC YARD | PERM | PERMANENT |
| CI | CODIC TARD | PI | POINT OF INTERSECTION |
| D | DRAIN | PIVC | POINT OF INTERSECTION ON VERTICAL CURVE |
| DBH | DIAMETER AT BREAST HEIGHT | PK | PARKING |
| DET(S) | DETAIL(S) | P/L | PROPERTY LINE |
| DI | DUCTILE IRON | PL | PLACE |
| DIA | DIAMETER | PRESS | PRESSURE |
| DR | DRIVE | PROP PS | PROPOSED PLIMB CTATION |
| DRG DWY | DRAWING DRIVEWAY | PSI | PUMP STATION POUNDS PER SQUARE INCH |
| DWI | DITVEWAT | PT | POINT OF TANGENCY |
| EA | EACH | PV | PLUG VALVE |
| EB | EASTBOUND | PVC | POLYVINYL CHLORIDE |
| EG | EXISTING GRADE | PVMT | PAVEMENT |
| EL | ELEVATION | PW | PUBLIC WORKS |
| ELEC/E EOP | ELECTRICAL EDGE OF PAVEMENT | R | DADILIC |
| EQ | EQUAL | R&R | RADIUS REMOVE AND REPAIR |
| EQUIP | EQUIPMENT | RCP | REINFORCED CONCRETE PIPE |
| ESC | EROSION/SEDIMENTATION CONTROL | RD | ROAD/ROOF DRAIN |
| ESMT | EASEMENT | RDCR | REDUCER |
| EXIST/EX | EXISTING | REHAB | REHABILITATE/REHABILITATION |
| | | REINF | REINFORCE(D)(ING)(MENT) |
| FAB | FABRICATE | REQ'D | REQUIRED |
| FD | FLOOR DRAIN | RESTR | RESTRAIN(ED) |
| FG FH | FINISH GRADE FIRE HYDRANT | RET RT | RETAINING RIGHT |
| FIN GR | FINISHED GRADE | R/W | RIGHT OF WAY |
| FL | FLOW LINE | . 4 | |
| FLG | FLANGE(D) | SB | SOUTHBOUND |
| FM | FORCE MAIN | SCHED | SCHEDULE |
| FO | FIBER OPTIC | SD | STORM DRAIN |
| FT | FEET/FOOT | SDMH | STORM DRAIN MANHOLE |
| FTG | FITTING | SHT(S) | SHEET(S) |
| G | GAS | SLP SPECS | SLOPE SPECIFICATIONS |
| GALV | GAS GALVANIZED | SPECS | SPOOL |
| GR | GRADE | SPR | SANITARY POINT REPAIR |
| GRVL | GRAVEL | SQ | SQUARE |
| GUT | GUTTER | SQ FT | SQUARE FOOT |
| GV | GATE VALVE | | |

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900 SE DOUGLAS AVE. ROSEBURG, OR 97470

CITY PROJECT #: 22PW01 PH 1

CITY PROJECT MANAGER

RICK CASTLE

LEGEND & ABBREVIATIONS

SS SSC SSCO SSMH SST ST

STL STPR

S/W

T/TEL TB

TBD

TBM TC TCM TCP TEMP THK

THRU TV TYP

USDOT

VERT VCP

WM WZ

W/O

SANITARY SEWER STAINLESS STEEL CLAMPS SANITARY SEWER CLEANOUT

SANITARY SEWER MANHOLE

STAINLESS STEEL STREET

STANDARD STEEL STORM POINT REPAIR

TELEPHONE THRUST BLOCK TO BE DETERMINED

THICK/THICKNESS

TRANSPORTATION

VERTICAL(LY) VITRIFIED CLAY PIPE

TELEVISION

TYPICAL

WATER WESTBOUND

WITH

WITHOUT

WATER METER WORK ZONE

TEMPORARY BENCH MARK TOP OF CURB

TRAFFIC CONTROL MEASURES TRAFFIC CONTROL PLAN TEMPORARY

UNITED STATES DEPARTMENT OF

G-02

STEPHENS STREET CURB RAMP IMPROVEMENTS
MARCH 2022

- 3. IT SHALL BE THE RESPONSIBILITY OF THE CONTRACTOR TO VERIFY ALL UTILITY LOCATIONS PRIOR TO CONSTRUCTION AND ARRANGE FOR THE RELOCATION OF ANY UTILITIES IN CONFLICT WITH THE PROPOSED CONSTRUCTION. THE LOCATIONS, DEPTH AND DESCRIPTION OF EXISTING UTILITIES SHOWN WERE COMPILED FROM AVAILABLE RECORDS. THE ENGINEER OR UTILITY COMPANIES DO NOT GUARANTEE THE ACCURACY OR THE COMPLETENESS OF SUCH RECORDS. ADDITIONAL UTILITIES, OTHER THAN THOSE SHOWN. MAY EXIST WITHIN THE WORK AREA.
- 4. OREGON LAW REQUIRES THAT THE RULES ADOPTED BY OREGON UTILITY NOTIFICATION CENTER BE FOLLOWED. THOSE RULES ARE SET FORTH IN OAR 952-001-0010 THROUGH OAR 952-001-0090. YOU MAY OBTAIN COPIES OF THE RULES BY CALLING THE CENTER OR ACCESSING VIA INTERNET AT WWW.CALLBEFOREYOUDIG.ORG. CALL BEFORE YOU DIG 811.
- 5. THE CONTRACTOR SHALL MAKE PROVISIONS TO KEEP ALL EXISTING UTILITIES IN SERVICE AND PROTECT THEM DURING CONSTRUCTION. CONTRACTOR SHALL IMMEDIATELY REPAIR OR REPLACE ANY DAMAGED UTILITIES USING MATERIALS AND METHODS APPROVED BY THE UTILITY OWNER. NO SERVICE INTERRUPTIONS SHALL BE PERMITTED WITHOUT PRIOR WRITTEN AGREEMENT WITH THE UTILITY PROVIDER
- 6. CONTRACTOR SHALL NOTIFY THE ENGINEER AND THE CITY OF ROSEBURG 48 HOURS IN ADVANCE OF STARTING CONSTRUCTION AND 24 HOURS BEFORE RESUMING WORK AFTER SHUTDOWNS, EXCEPT FOR NORMAL RESUMPTION OF WORK FOLLOWING SATURDAYS, SUNDAYS, OR HOLIDAYS.
- 7. CONTRACTOR SHALL REMOVE AND DISPOSE OF CONCRETE, ASPHALT CEMENT, TOPSOIL, AND OTHER MATERIAL IN THE WORK LIMITS AND WHERE INDICATED ON THE PLANS. MATERIAL SHALL BE DISPOSED OF IN SUCH A MANNER AS TO MEET ALL APPLICABLE REGULATIONS. CONTRACTOR SHALL ENSURE RECIPIENTS OF FILL MATERIALS REMOVED OFFSITE ARE PERMITTED TO RECEIVE SAID MATERIALS REGARDLESS OF THE RECEIVING JURISDICTION.
- 8. UNLESS OTHERWISE APPROVED BY THE ENGINEER, LIMIT HOURS OF CONSTRUCTION TO EITHER DAY SHIFT, 7:00AM TO 7:00PM, OR NIGHT SHIFT, 7:00PM TO 7:00AM, MONDAY THROUGH FRIDAY AS STATED IN SECTION 000180.40(A) OF THE SPECIAL PROVISIONS. CONSTRUCTION IN ALL PROJECT AREAS IS PROHIBITED ON SATURDAYS, SUNDAYS AND HOLIDAYS, AS STATED IN SECTION 220.40(E) OF THE SPECIAL PROVISIONS. SEE SECTION 00220 OF THE SPECIAL PROVISIONS FOR ALLOWABLE LANE CLOSURES.
- 9. THE CONTRACTOR SHALL KEEP AN APPROVED SET OF PLANS ON THE PROJECT SITE AT ALL TIMES.
- 10. IT IS THE CONTRACTOR'S RESPONSIBILITY TO VISIT THE SITE AND VERIFY ALL EXISTING CONDITIONS BEFORE THE START OF WORK. THE CONTRACTOR SHALL TAKE ALL NECESSARY FIELD MEASUREMENTS AND OTHERWISE VERIFY ALL DIMENSIONS AND EXISTING CONSTRUCTION CONDITIONS INDICATED AND/OR SHOWN ON THE PLANS. SHOULD ANY ERROR OR INCONSISTENCY EXIST, THE CONTRACTOR SHALL NOT PROCEED WITH THE WORK AFFECTED UNTIL REPORTED TO THE ENGINEER FOR CLARIFICATION OR CORRECTION.
- 11. ANY INSPECTION BY THE CITY, COUNTY, STATE, FEDERAL AGENCY OR ENGINEER SHALL NOT, IN ANY WAY, RELIEVE THE CONTRACTOR FROM ANY OBLIGATION TO PERFORM THE WORK IN COMPLIANCE WITH THE APPLICABLE CODES, REGULATIONS, CITY STANDARDS AND PROJECT CONTRACT DOCUMENTS.
- 12. CONTRACTOR SHALL COORDINATE ALL IMPROVEMENT LIMITS WITH THE ENGINEER ONSITE PRIOR TO BEGINNING WORK. NO PAYMENT WILL BE MADE FOR EXTRA WORK THAT IS CONSTRUCTED BEYOND THE APPROVED CONSTRUCTION LIMITS.
- 13. AT THE END OF EACH WORK DAY, THE CONTRACTOR SHALL CLEAN UP THE PROJECT AREA AND LEAVE IT IN A NEAT AND SECURED MANNER. UPON COMPLETION OF THE PROJECT, THE CONTRACTOR SHALL LEAVE THE PROJECT AREA FREE FROM ALL DEBRIS AND UNUSED MATERIALS.
- 14. PROPERTY LINES SHOWN ON PLAN SHEETS ARE APPROXIMATE AND FOR GENERAL DELINEATION PURPOSES ONLY AND ARE NOT MEANT TO REPRESENT THE ACTUAL PROPERTY BOUNDARIES.
- 15. THE CONTRACTOR SHALL BE SOLELY RESPONSIBLE FOR COMPLYING WITH ALL CONSTRUCTION SAFETY, HEALTH AND OTHER RULES AND REGULATIONS FROM OSHA, DEQ, STATE, AND LOCAL REGULATING AGENCIES FOR SAFETY AND INSTALLATION OF THE WORK INCLUDING, BUT NOT LIMITED TO. SHORING, BRACING, ERECTION/INSTALLATION. FALL PROTECTION, GUARDRAILS, ETC.
- 16. REPLACE CURBS, SIDEWALKS, AND/OR DRIVEWAY APRONS THAT ARE DAMAGED AS A RESULT OF CONSTRUCTION OPERATIONS. REPLACE FULL SECTIONS TO THE NEAREST EXISTING CONSTRUCTION JOINT. REPLACEMENT WILL BE CONSIDERED INCIDENTAL TO THE WORK.
- 17. ALL CONSTRUCTION SURVEY AND STAKING REQUIRED FOR THE PROJECT SHALL BE PROVIDED BY THE CONTRACTOR. THE CONTRACTOR SHALL DEVELOP AND MAKE ALL DETAIL SURVEYS NECESSARY FOR LAYOUT AND CONSTRUCTION INCLUDING EXACT COMPONENT LOCATION (SUCH AS EXISTING STRIPING, SYMBOLS, DETECTOR LOOPS, ETC), WORKING POINTS, LINES, AND ELEVATIONS. PRIOR TO CONSTRUCTION, THE FIELD LAYOUT SHALL BE REVIEWED BY THE ENGINEER. THE CONTRACTOR SHOULD ASSUME THAT ALL SURVEY STAKING IS TO BE COMPLETED USING INFORMATION CONTAINED IN THE PLANS AND SPECIFICATIONS OR FROM EXISTING ONSITE FEATURES. INFORMATION OR CLARIFICATION BY THE ENGINEER MAY BE AVAILABLE UPON REQUEST, BUT IS NOT GUARANTEED.

- 18. THE CONTRACTOR SHALL HAVE THE RESPONSIBILITY TO CAREFULLY PRESERVE BENCHMARKS, REFERENCE POINTS AND STAKES, AND IN THE CASE OF DESTRUCTION THEREOF BY THE CONTRACTOR RESULTING FROM ITS NEGLIGENCE, THE CONTRACTOR SHALL BE CHARGED WITH THE EXPENSE AND DAMAGE RESULTING THEREFORE AND SHALL BE RESPONSIBLE FOR ANY MISTAKES THAT MAY BE CAUSED BY THE UNNECESSARY LOSS OR DISTURBANCE OF SUCH MARKS, REFERENCE POINTS AND STAKES.
- 19. CONTRACTOR IS RESPONSIBLE FOR SURVEYING AND REPLACING ALL MONUMENTS DISTURBED BY PAVING OR CONCRETE WORK PURSUANT TO ORS 209.150, AND FOR PREPARING AND FILING A RECORD OF SURVEY TO THE COUNTY SURVEYOR'S OFFICE PURSUANT TO ORS 209.250.
- 20. COORDINATE WITH OTHER CONTRACTORS WITHIN THE PROJECT LIMITS COMPLETING WORK. IF APPLICABLE, SEE THE GENERAL CONDITIONS OF THE SPECIFICATIONS FOR CONTACT INFORMATION.
- 21. PROTECT FRESHLY POURED CONCRETE CURBS AND SIDEWALK FROM VANDALISM OR OTHER DAMAGE FOR A MINIMUM OF TWENTY-FOUR (24) HOURS OR UNTIL CURED ENOUGH TO SUPPORT TYPICAL USE, WHICHEVER IS LONGER. ANY CURB OR SIDEWALK DAMAGED BY VANDALISM OR OTHER CAUSES SHALL BE REPLACED AT NO COST TO THE CITY.
- 22. CONTRACTOR SHALL RESTORE ALL DISTURBED LANDSCAPING AND IRRIGATION. PLACE TOPSOIL, AGGREGATE, AND/OR BARK MULCH WHERE SHOWN.
- 23. FURNISH AND PLACE DOWELS TO JOIN NEW CONCRETE WALKS, CURBS AND DRIVEWAYS TO EXISTING CONCRETE AS DIRECTED.
- 24. LIMIT THE TIME ANY ADA RAMP IS CLOSED TO 14 CALENDAR DAYS.

EROSION CONTROL NOTES

- 1. ALL EROSION AND SEDIMENT CONTROL MEASURES ARE TO BE PLACED PRIOR TO ANY DISTURBANCE CAUSED BY GRADING AND SHALL CONFORM TO THE REQUIREMENTS OF STATE AND FEDERAL REGULATIONS AND TO THE SPECIFIC REQUIREMENTS CONTAINED IN THE SPECIFICATIONS.
- 2. EXISTING INLETS AND CATCH BASINS THAT MAY RECEIVE RUNOFF FROM THE PROJECT AREA ARE TO BE PROTECTED PRIOR TO CONSTRUCTION. ALL INLETS AND CATCH BASINS ARE TO BE PROTECTED IN ACCORDANCE WITH ODOT/APWA STANDARDS FOR EROSION AND SEDIMENT CONTROL.
- 3. IN THE EVENT OF ANY EROSION CONTROL MEASURE FAILURE, IMMEDIATE ACTION SHALL BE TAKEN TO REPAIR, REPLACE, OR CONSTRUCT ADDITIONAL MEASURES AS REQUIRED TO ENSURE ADEQUATE EROSION CONTROL PROTECTION.
- 4. ALL EROSION CONTROL MEASURES SHALL BE INSPECTED REGULARLY, PARTICULARLY DURING AND AFTER STORM EVENTS, TO ENSURE ADEQUATE PERFORMANCE. MAINTENANCE AND INSPECTION LOGS SHALL REMAIN ON SITE AND SHALL BE AVAILABLE TO THE CITY OF ROSEBURG UPON REQUEST.
- 5. ALL PESTICIDES, PETROLEUM PRODUCTS, CHEMICALS OR OTHER POTENTIAL POLLUTANTS SHALL BE ADMINISTERED RESPONSIBLY WITH DISPOSAL AND SPILLS HANDLED IN ACCORDANCE WITH ALL LOCAL, STATE AND FEDERAL REOUIREMENTS.

PAVING NOTES

- 1. TRIM VEGETATION AS NEEDED PRIOR TO PAVING TO ENSURE ALL VEGETATION IS CLEAR OF PAVING OPERATIONS.
- 2. ALL EDGES REMAINING AFTER PAVEMENT REMOVAL SHALL BE VERTICAL TO ACCEPT THE SUCCEEDING FULL DEPTH ASPHALT LIFT.
- 3. ALL JOINTS BETWEEN NEW ASPHALTIC CONCRETE AND EXISTING OR NEW ASPHALTIC CONCRETE AND CONCRETE SHALL BE TACKED AND SAND SEALED.
- 4. PROVIDE MINOR ADJUSTMENTS IN GRADE OF NEW A.C. AS REQUIRED TO FACILITATE DRAINAGE INTO STORM DRAINAGE FACILITIES. NO PONDING SHALL OCCUR BETWEEN CATCH BASINS FOLLOWING CONSTRUCTION.
- 5. THE MAXIMUM EXPOSURE AT DRIVEWAYS SHALL BE 3/4-INCH.
- 6. WHERE PAVEMENT IS TO BE REPLACED TO MATCH EXISTING GRADE ADJACENT TO EXISTING CURB, CONTRACTOR SHALL MARK EXISTING CURB FLOW LINE WITH PAINT PRIOR TO A.C. SURFACING REMOVAL.
- 7. COORDINATE WITH CITY STAFF FOR IN-GROUND VALVE, MANHOLE OR VAULT ADJUSTMENT OF FRANCHISE UTILITY ASSETS.

TRAFFIC CONTROL NOTES

- 1. TRAFFIC CONTROL/DETOUR PLANS SHALL BE PREPARED BY THE CONTRACTOR. THE DRAFT CONCEPT TRAFFIC CONTROL PLAN MUST BE APPROVED BY THE CITY PRIOR TO THE PRE-CONSTRUCTION CONFERENCE. THIS PLAN DOES NOT RELIEVE THE CONTRACTOR FROM SUBMITTING DETAILED TRAFFIC CONTROL PLANS AS REQUIRED DURING CONSTRUCTION.
- 2. THE CONTRACTOR SHALL PROVIDE TEMPORARY PROTECTION AND DIRECTION OF TRAFFIC IN ACCORDANCE WITH THE MANUAL OF UNIFORM TRAFFIC CONTROL DEVICES, ODOT STANDARD DRAWINGS, ODOT STANDARD SPECIFICATIONS, AND CONTRACT SPECIAL PROVISIONS.
- 3. USE TEMPORARY PAVEMENT MARKERS, BARRIERS, BARRICADES, AND SIGNS AS REQUIRED TO SAFELY DETOUR PEDESTRIAN AND VEHICULAR TRAFFIC AROUND CONSTRUCTION. LABEL TYPE AND LOCATION FOR ALL ITEMS ON TRAFFIC CONTROL PLANS.
- 4. APPROPRIATE METHODS OF PEDESTRIAN AND VEHICULAR TRAFFIC CONTROL, INCLUDING FLAGGERS, SHALL BE EMPLOYED BY THE CONTRACTOR TO THE EXTENT DEEMED NECESSARY BY THE TRAFFIC CONTROL SUPERVISOR AND AS APPROVED BY THE CITY AND THE ENGINEER TO PROTECT WORKERS OR THIRD PARTIES AND SAFELY ACCOMMODATE TRAFFIC THROUGH THE WORK ZONE.
- 5. THE CONTRACTOR SHALL COORDINATE ACCESS TO DRIVEWAYS WITH PROPERTY OWNERS. ACCESS TO ROADWAY APPROACHES WITHIN THE PROJECT LIMITS SHALL BE MAINTAINED AT ALL TIMES. TRAFFIC PLATES SHALL BE USED, AND SECURED IN A MANNER ACCEPTABLE TO THE CITY, ACROSS ALL TRENCHES BLOCKING DRIVEWAYS TO PROVIDE ACCESS AT ALL TIMES. AT NO TIME SHALL CONTRACTORS DETAIN OR DELAY EMERGENCY VEHICLES.
- 6. THE CONTRACTOR SHALL COORDINATE ACCESS FOR SERVICES INCLUDING, BUT NOT LIMITED TO, MAIL DELIVERY, TRASH PICKUP, SCHOOL TRANSPORTATION, AND ANY OTHER SPECIAL TRANSPORTATION SERVICES THAT EXIST WITHIN THE PROJECT AREA.
- 7. EXISTING SIGNS THAT CONFLICT WITH CONSTRUCTION SIGNING SHALL BE COVERED OR REMOVED DURING CONSTRUCTION AND REPLACED AFTER CONSTRUCTION.
- 8. PROVIDE ACP WEDGES FOR LONGITUDINAL AND TRANSVERSE JOINTS ACCORDING TO 00620.40(d), 00744.44 AND 00744.45.
- 9. THE CONTRACTOR SHALL PROVIDE SAFE, STABLE, AND ACCESSIBLE ACCESS TO ALL DRIVEWAY AND PEDESTRIAN PATHS CONNECTING TO FRONT DOORS AT ALL TIMES. TEMPORARY INTERRUPTIONS IN ACCESS SHALL BE COORDINATED BY THE CONTRACTOR WITH THE PROPERTY OWNER OR OCCUPANT AS REQUIRED.
- 10. CONTRACTOR SHALL FURNISH PORTABLE CHANGEABLE MESSAGE SIGN AT WORK ZONES ON ARTERIAL ROADS IN ACCORDANCE WITH THE SPECIFICATIONS.
- 11. COLD PLANE PAVEMENT REMOVAL SHALL BE COMPLETED ON THE SAME SHIFT AS THE PERMANENT ASPHALT PAVEMENT WEARING COURSE.

SITE RESTORATION NOTES

- 1. RESTORE ALL DISTURBED SURFACES TO PRE-CONSTRUCTION CONDITION OR BETTER.
- 2. CONTRACTOR TO RECONFIGURE EXISTING IRRIGATION SYSTEMS AS NEEDED. COORDINATE WITH ADJACENT PROPERTY OWNERS.
- 3. BARK MULCH SHALL BE 4" THICK MINIMUM.
- 4. CONTRACTOR SHALL PLACE 4" OF TOPSOIL PRIOR TO SEEDING AND/OR SOD INSTALLATION.
- 5. CRUSHED AND/OR DECORATIVE ROCK SHALL BE 4" THICK MINIMUM.
- 6. SALVAGE EXISTING LANDSCAPE BOULDERS AND PLACE AS DIRECTED BY ENGINEER.



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| ects | | | | | ONE INCH (REF) | | CWE PROJECT NO. |
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900 SE DOUGLAS AVE. ROSEBURG, OR 97470

CITY PROJECT #: 22PW01 PH 1

CITY PROJECT MANAGER

RICK CASTLE

GENERAL NOTES


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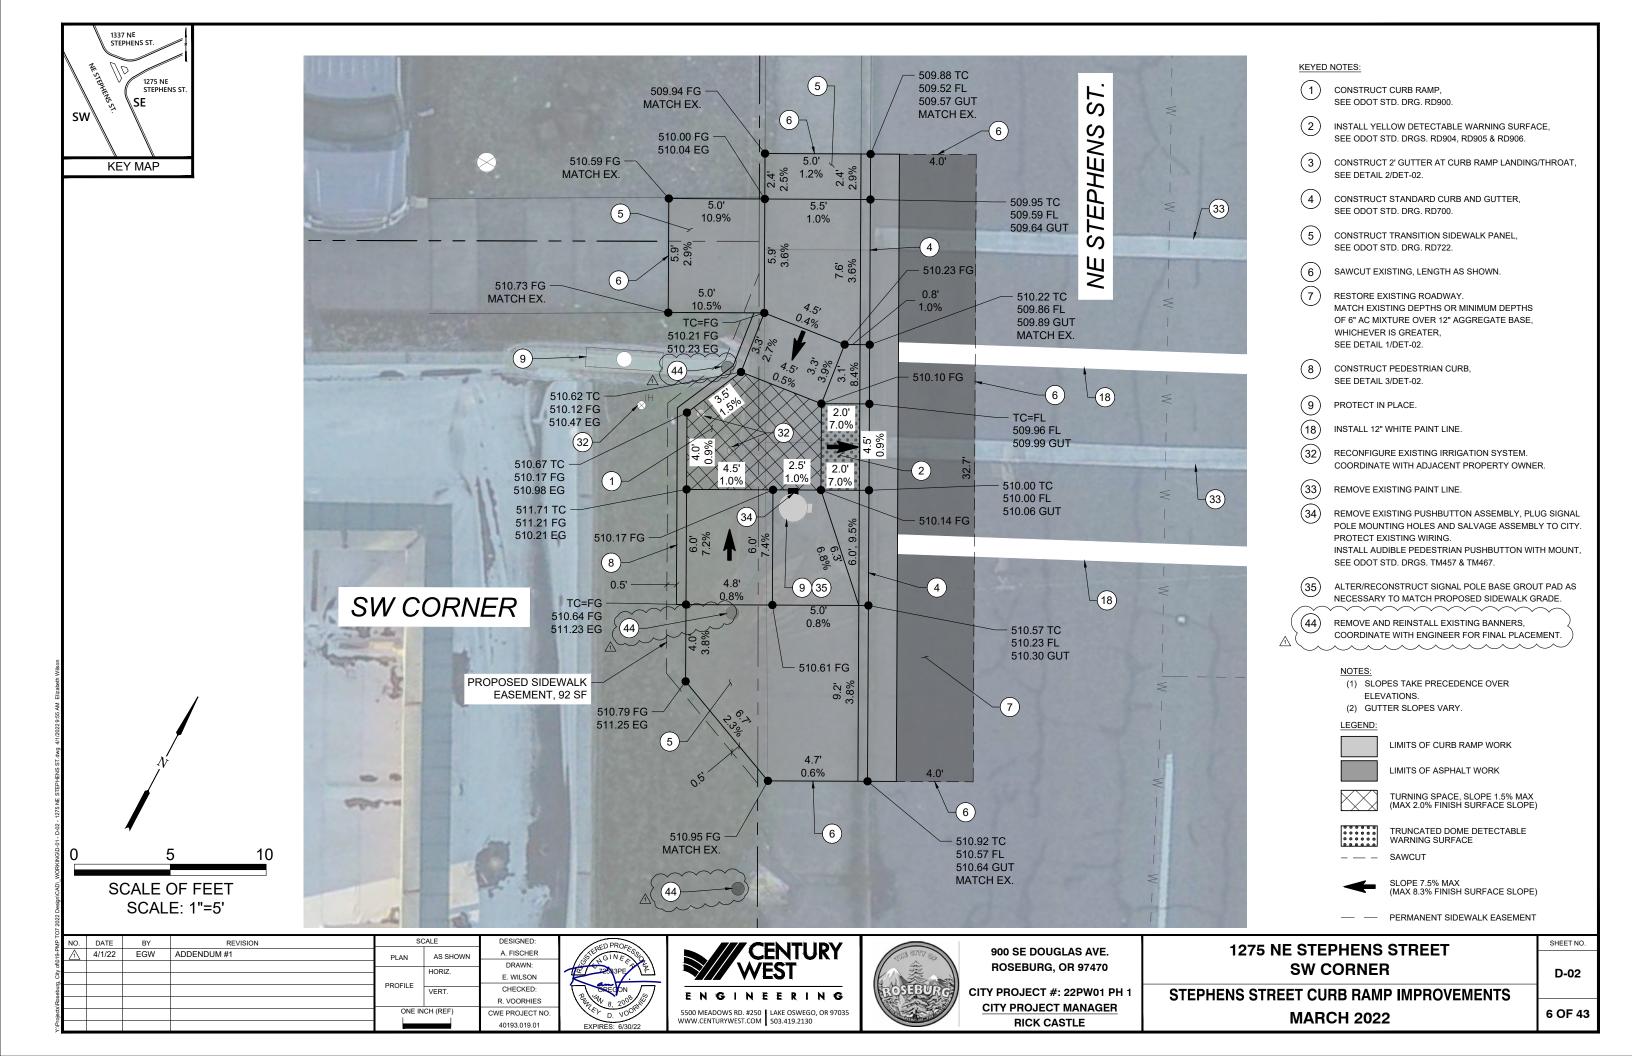
STEPHENS STREET CURB RAMP IMPROVEMENTS


MARCH 2022

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SHEET NO.





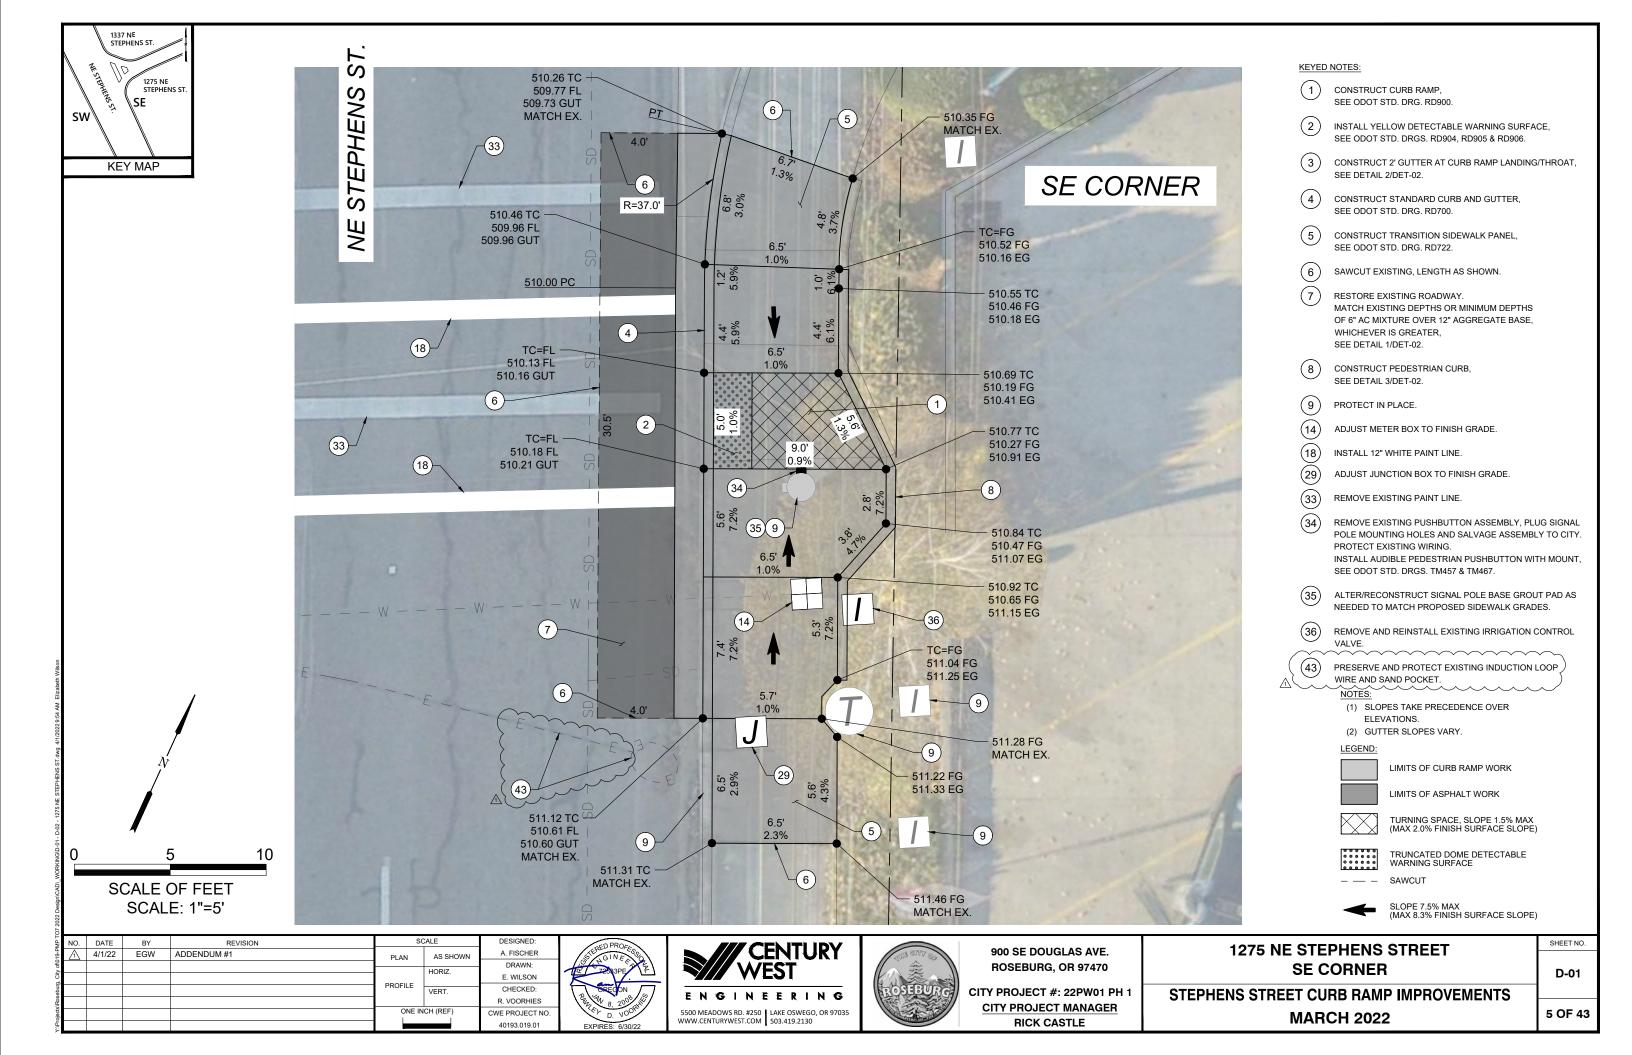

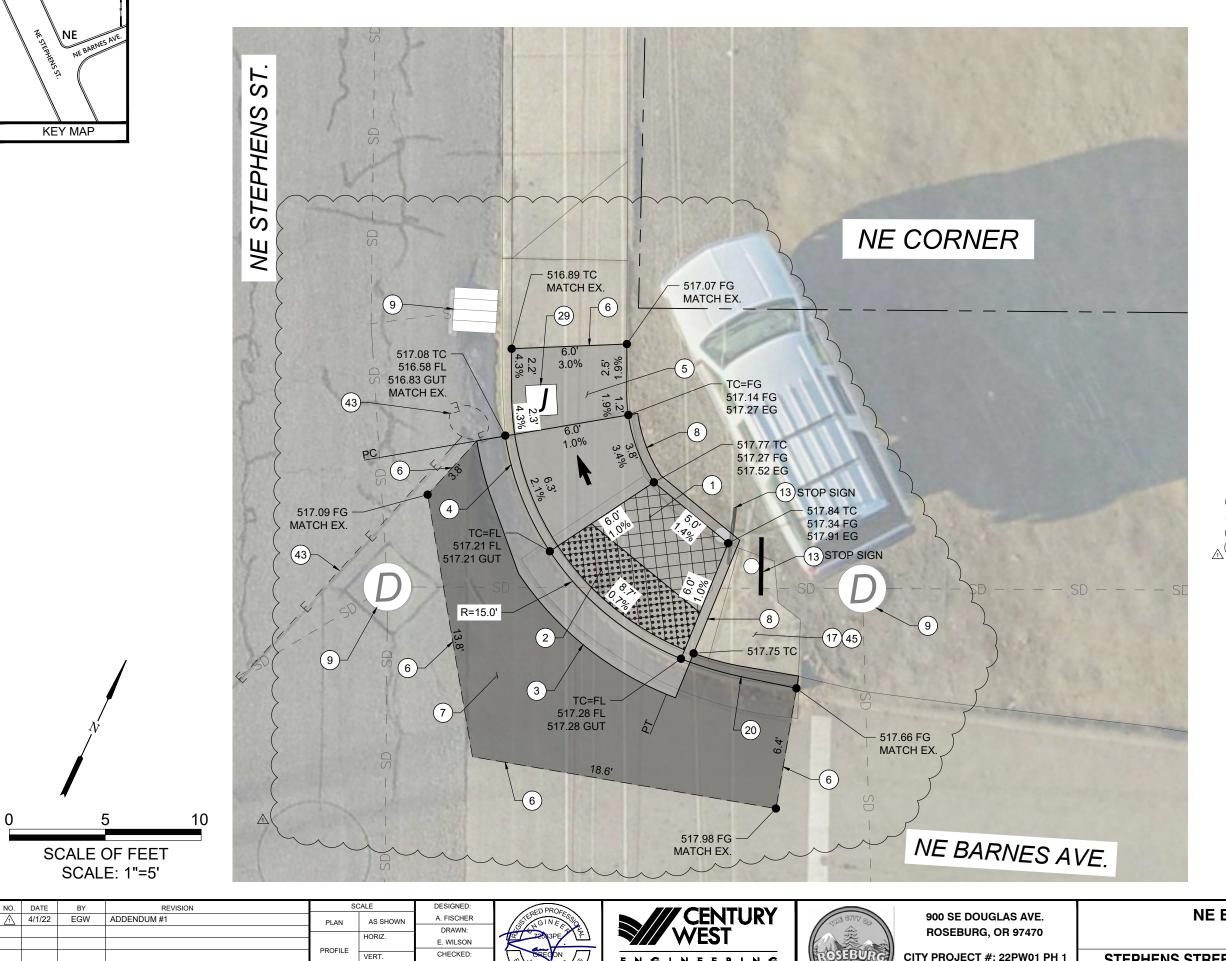- CONSTRUCT CURB RAMP, SEE ODOT STD. DRG. RD900.
- INSTALL YELLOW DETECTABLE WARNING SURFACE, SEE ODOT STD. DRGS. RD904, RD905 & RD906.
- CONSTRUCT 2' GUTTER AT CURB RAMP LANDING/THROAT, SEE DETAIL 2/DET-02.
- CONSTRUCT STANDARD CURB AND GUTTER, SEE ODOT STD. DRG. RD700.
- CONSTRUCT TRANSITION SIDEWALK PANEL, SEE ODOT STD. DRG. RD722.
- SAWCUT EXISTING, LENGTH AS SHOWN.
- (7)RESTORE EXISTING ROADWAY. MATCH EXISTING DEPTHS OR MINIMUM DEPTHS OF 6" AC MIXTURE OVER 12" AGGREGATE BASE, WHICHEVER IS GREATER, SEE DETAIL 1/DET-02.
- CONSTRUCT PEDESTRIAN CURB, SEE DETAIL 3/DET-02.
- PROTECT IN PLACE.
- REMOVE AND RELOCATE EXISTING SIGN.
- (17) REMOVE EXISTING CONCRETE.
- (20) CONSTRUCT ASPHALT BERM. MATCH CROSS-SECTION OF EXISTING BERM.
- ADJUST JUNCTION BOX TO FINISH GRADE.
- (43) PRESERVE AND PROTECT EXISTING INDUCTION LOOP WIRE AND SAND POCKET.
- INSTALL CRUSHED ROCK AS NEEDED, 4" THICK MIN.

- (1) SLOPES TAKE PRECEDENCE OVER ELEVATIONS.
- (2) GUTTER SLOPES VARY.

LEGEND:

LIMITS OF CURB RAMP WORK



LIMITS OF ASPHALT WORK



TURNING SPACE, SLOPE 1.5% MAX (MAX 2.0% FINISH SURFACE SLOPE)



TRUNCATED DOME DETECTABLE WARNING SURFACE





SLOPE 7.5% MAX (MAX 8.3% FINISH SURFACE SLOPE)

R. VOORHIES ONE INCH (REF CWE PROJECT NO.








CITY PROJECT #: 22PW01 PH 1 **CITY PROJECT MANAGER RICK CASTLE**

NE BARNES AVENUE NE CORNER

STEPHENS STREET CURB RAMP IMPROVEMENTS **MARCH 2022**

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SHEET NO.

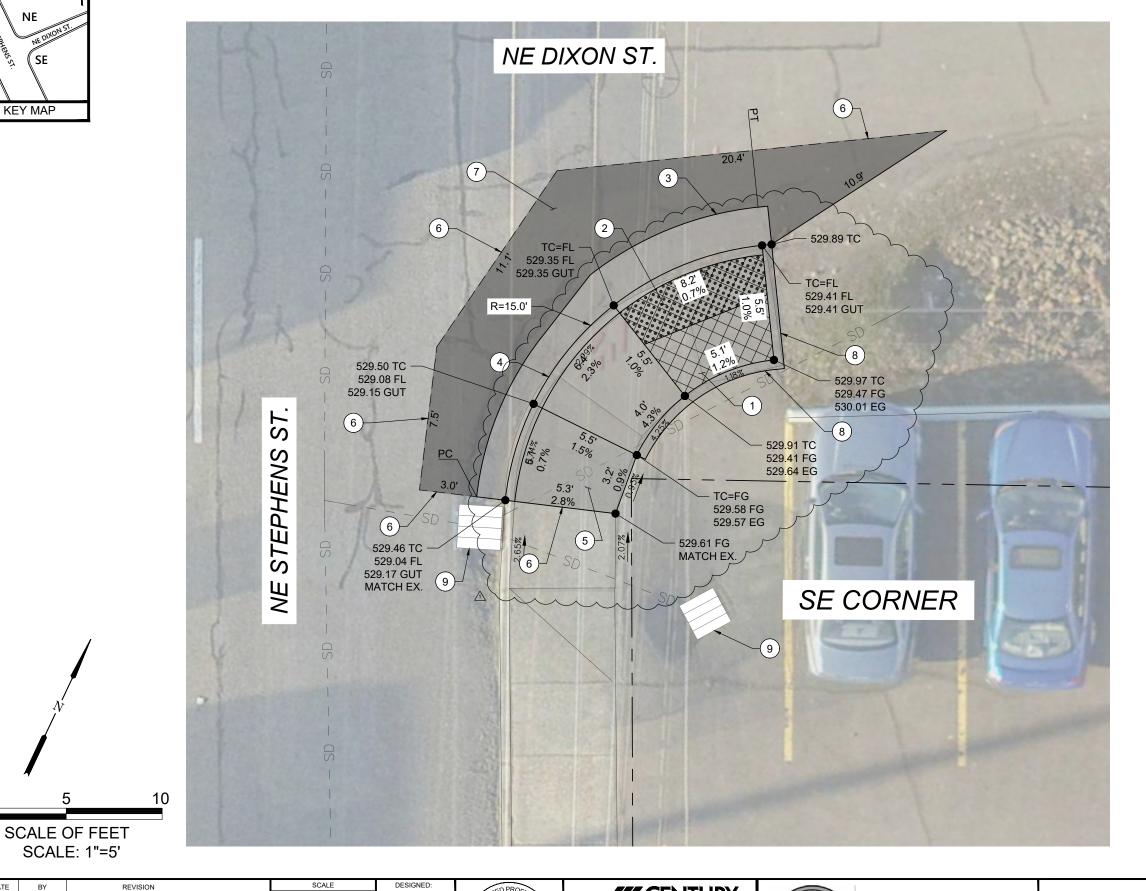

- (1) CONSTRUCT CURB RAMP, SEE ODOT STD. DRG. RD900.
- 2 INSTALL YELLOW DETECTABLE WARNING SURFACE, SEE ODOT STD. DRGS. RD904, RD905 & RD906.
- (3) CONSTRUCT 2' GUTTER AT CURB RAMP LANDING/THROAT, SEE DETAIL 2/DET-02.
- (4) CONSTRUCT STANDARD CURB AND GUTTER, SEE ODOT STD. DRG. RD700.
- (5) CONSTRUCT TRANSITION SIDEWALK PANEL, SEE ODOT STD. DRG. RD722.
- (6) SAWCUT EXISTING, LENGTH AS SHOWN.
- 7 RESTORE EXISTING ROADWAY.
 MATCH EXISTING DEPTHS OR MINIMUM DEPTHS
 OF 6" AC MIXTURE OVER 12" AGGREGATE BASE,
 WHICHEVER IS GREATER,
 SEE DETAIL 1/DET-02.
- 8 CONSTRUCT PEDESTRIAN CURB, SEE DETAIL 3/DET-02.
- 9 PROTECT IN PLACE.

NOTE

- (1) SLOPES TAKE PRECEDENCE OVER ELEVATIONS.
- (2) GUTTER SLOPES VARY.

LEGEND:

LIMITS OF CURB RAMP WORK

LIMITS OF ASPHALT WORK



TURNING SPACE, SLOPE 1.5% MAX (MAX 2.0% FINISH SURFACE SLOPE)



TRUNCATED DOME DETECTABLE WARNING SURFACE

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SLOP (MAX

SLOPE 7.5% MAX (MAX 8.3% FINISH SURFACE SLOPE)

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RICK CASTLE

NE DIXON STREET SE CORNER


STEPHENS STREET CURB RAMP IMPROVEMENTS

MARCH 2022

D-05

SHEET NO.



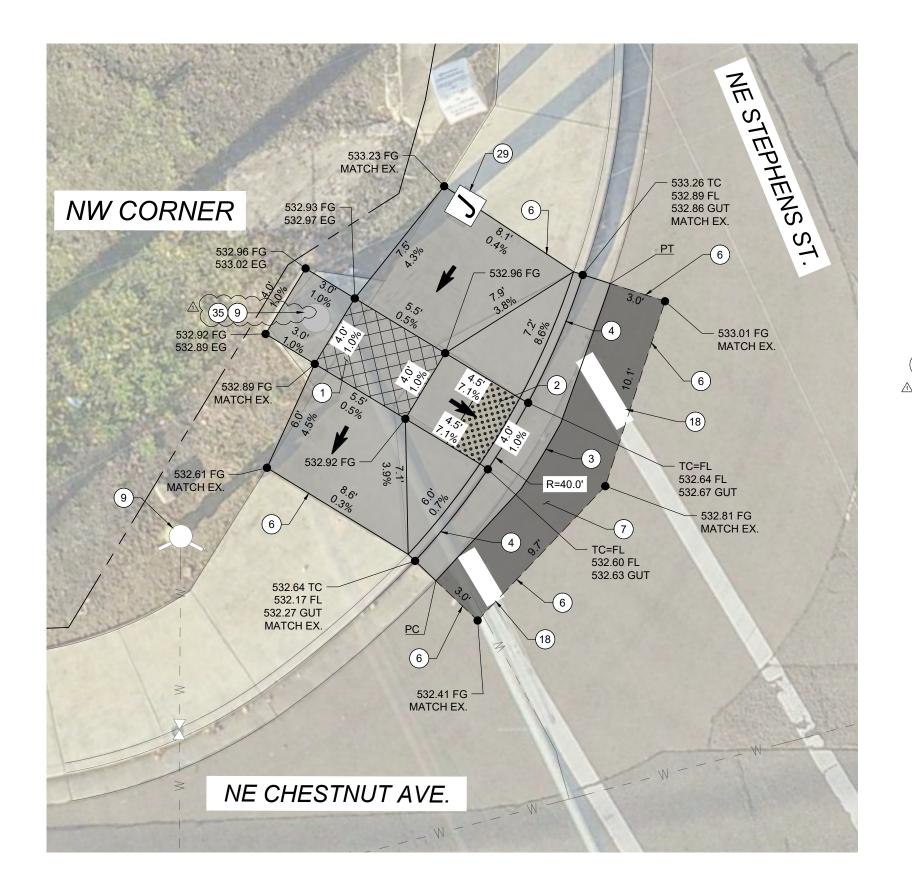

- CONSTRUCT CURB RAMP, SEE ODOT STD. DRG. RD900.
- INSTALL YELLOW DETECTABLE WARNING SURFACE, SEE ODOT STD. DRGS. RD904, RD905 & RD906.
- CONSTRUCT 2' GUTTER AT CURB RAMP LANDING/THROAT, SEE DETAIL 2/DET-02.
- CONSTRUCT STANDARD CURB AND GUTTER, SEE ODOT STD. DRG. RD700.
- SAWCUT EXISTING, LENGTH AS SHOWN.
- RESTORE EXISTING ROADWAY. MATCH EXISTING DEPTHS OR MINIMUM DEPTHS OF 6" AC MIXTURE OVER 12" AGGREGATE BASE, WHICHEVER IS GREATER, SEE DETAIL 1/DET-02.
- PROTECT IN PLACE.
- (18) INSTALL 12" WHITE PAINT LINE.
- (29) ADJUST JUNCTION BOX TO FINISH GRADE.
- ALTER/RECONSTRUCT SIGNAL POLE BASE GROUT PAD AS NECESSARY TO MATCH PROPOSED SIDEWALK GRADE.

- (1) SLOPES TAKE PRECEDENCE OVER ELEVATIONS.
- (2) GUTTER SLOPES VARY.

LEGEND:

LIMITS OF CURB RAMP WORK

LIMITS OF ASPHALT WORK



TURNING SPACE, SLOPE 1.5% MAX (MAX 2.0% FINISH SURFACE SLOPE)



TRUNCATED DOME DETECTABLE WARNING SURFACE





SLOPE 7.5% MAX (MAX 8.3% FINISH SURFACE SLOPE)

| NO. | DATE | BY | REVISION | S | CALE | DESIGNED: |
|-----|--------|-----|-------------|----------------|----------|-----------------|
| Λ | 4/1/22 | EGW | ADDENDUM #1 | PLAN | AS SHOWN | A. FISCHER |
| | | | | | | DRAWN: |
| | | | | | HORIZ. | E. WILSON |
| | | | | PROFILE | VERT. | CHECKED: |
| | | | | | | R. VOORHIES |
| | | | | ONE INCH (REF) | | CWE PROJECT NO. |
| | | | | | | 40193.019.01 |

10

SCALE OF FEET SCALE: 1"=5'







900 SE DOUGLAS AVE. **ROSEBURG, OR 97470**

CITY PROJECT #: 22PW01 PH 1 CITY PROJECT MANAGER **RICK CASTLE**


NE CHESTNUT AVENUE NW CORNER

STEPHENS STREET CURB RAMP IMPROVEMENTS **MARCH 2022**

10 OF 43

SHEET NO.

D-06

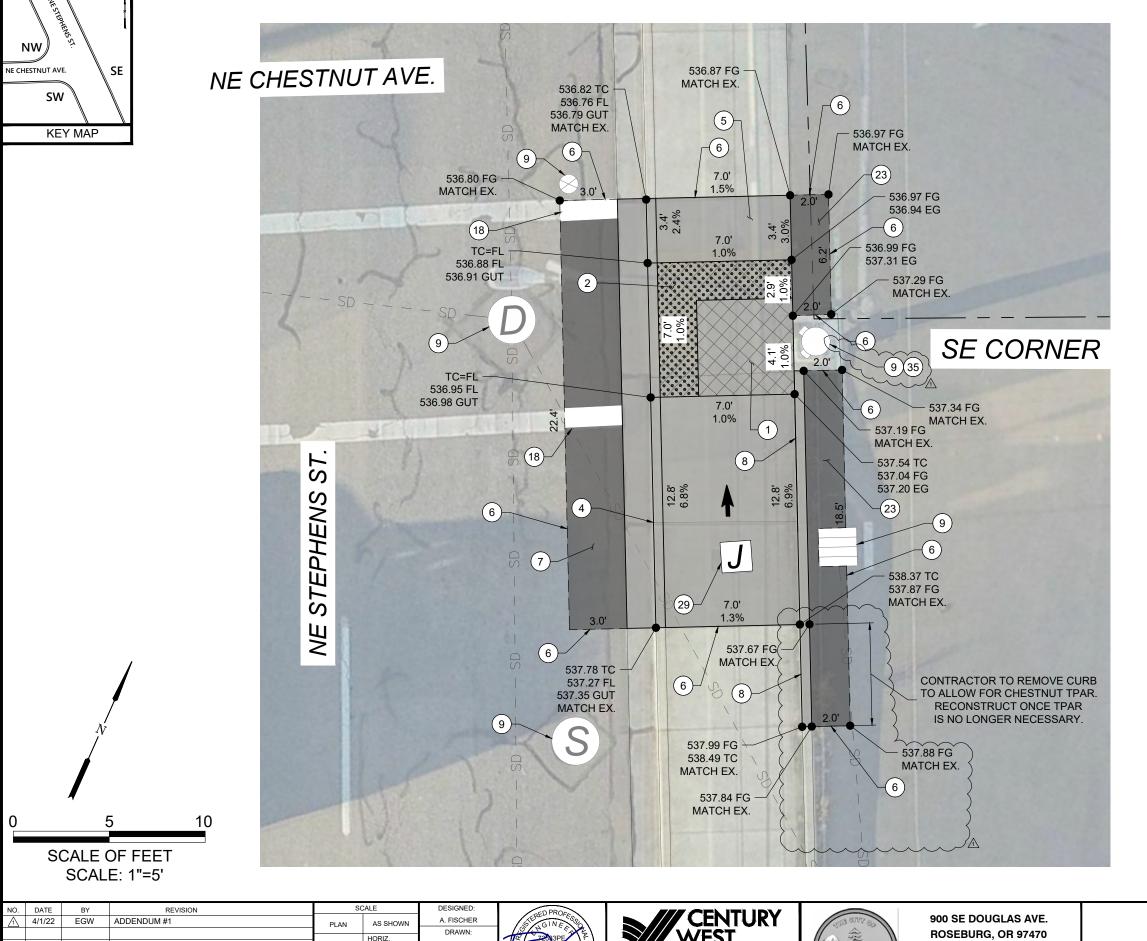

- CONSTRUCT CURB RAMP, SEE ODOT STD. DRG. RD900.
- INSTALL YELLOW DETECTABLE WARNING SURFACE, SEE ODOT STD. DRGS. RD904, RD905 & RD906.
- CONSTRUCT STANDARD CURB AND GUTTER, SEE ODOT STD. DRG. RD700.
- (6) SAWCUT EXISTING, LENGTH AS SHOWN.
 - RESTORE EXISTING ROADWAY. MATCH EXISTING DEPTHS OR MINIMUM DEPTHS OF 6" AC MIXTURE OVER 12" AGGREGATE BASE, WHICHEVER IS GREATER, SEE DETAIL 1/DET-02.
- CONSTRUCT PEDESTRIAN CURB, SEE DETAIL 3/DET-02.
- (9) PROTECT IN PLACE.
- (18) INSTALL 12" WHITE PAINT LINE.
- (23) RESTORE EXISTING ASPHALT PARKING LOT. MATCH EXISTING DEPTHS OR MINIMUM DEPTHS OF 3" AC MIXTURE OVER 6" AGGREGATE BASE, WHICHEVER IS GREATER.
- ADJUST JUNCTION BOX TO FINISH GRADE.
- ALTER/RECONSTRUCT SIGNAL POLE BASE GROUT PAD AS NECESSARY TO MATCH PROPOSED SIDEWALK GRADE.

- (1) SLOPES TAKE PRECEDENCE OVER ELEVATIONS.
- (2) GUTTER SLOPES VARY.

LEGEND:

LIMITS OF CURB RAMP WORK



LIMITS OF ASPHALT WORK



TURNING SPACE, SLOPE 1.5% MAX (MAX 2.0% FINISH SURFACE SLOPE)



TRUNCATED DOME DETECTABLE WARNING SURFACE





SLOPE 7.5% MAX (MAX 8.3% FINISH SURFACE SLOPE)

| NO. | DATE | BY | REVISION | SCALE | | ALE | DESIGNED: | |
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| Λ | 4/1/22 | EGW | ADDENDUM #1 | PLAN | | AS SHOWN | A. FISCHER | ı |
| | | | | | | | DRAWN: | ı |
| | | | | | | HORIZ. | | ٠ |
| | | | | | | | E. WILSON | 1 |
| | | | | PROFIL | -E | VERT. | CHECKED: | ı |
| | | | | | | | R. VOORHIES | ı |
| | | | | ONE INCH (REF) | | CH (REF) | CWE PROJECT NO. | ı |
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CITY PROJECT #: 22PW01 PH 1 CITY PROJECT MANAGER **RICK CASTLE**


NE CHESTNUT AVENUE SE CORNER


D-07

STEPHENS STREET CURB RAMP IMPROVEMENTS **MARCH 2022**

11 OF 43

SHEET NO.

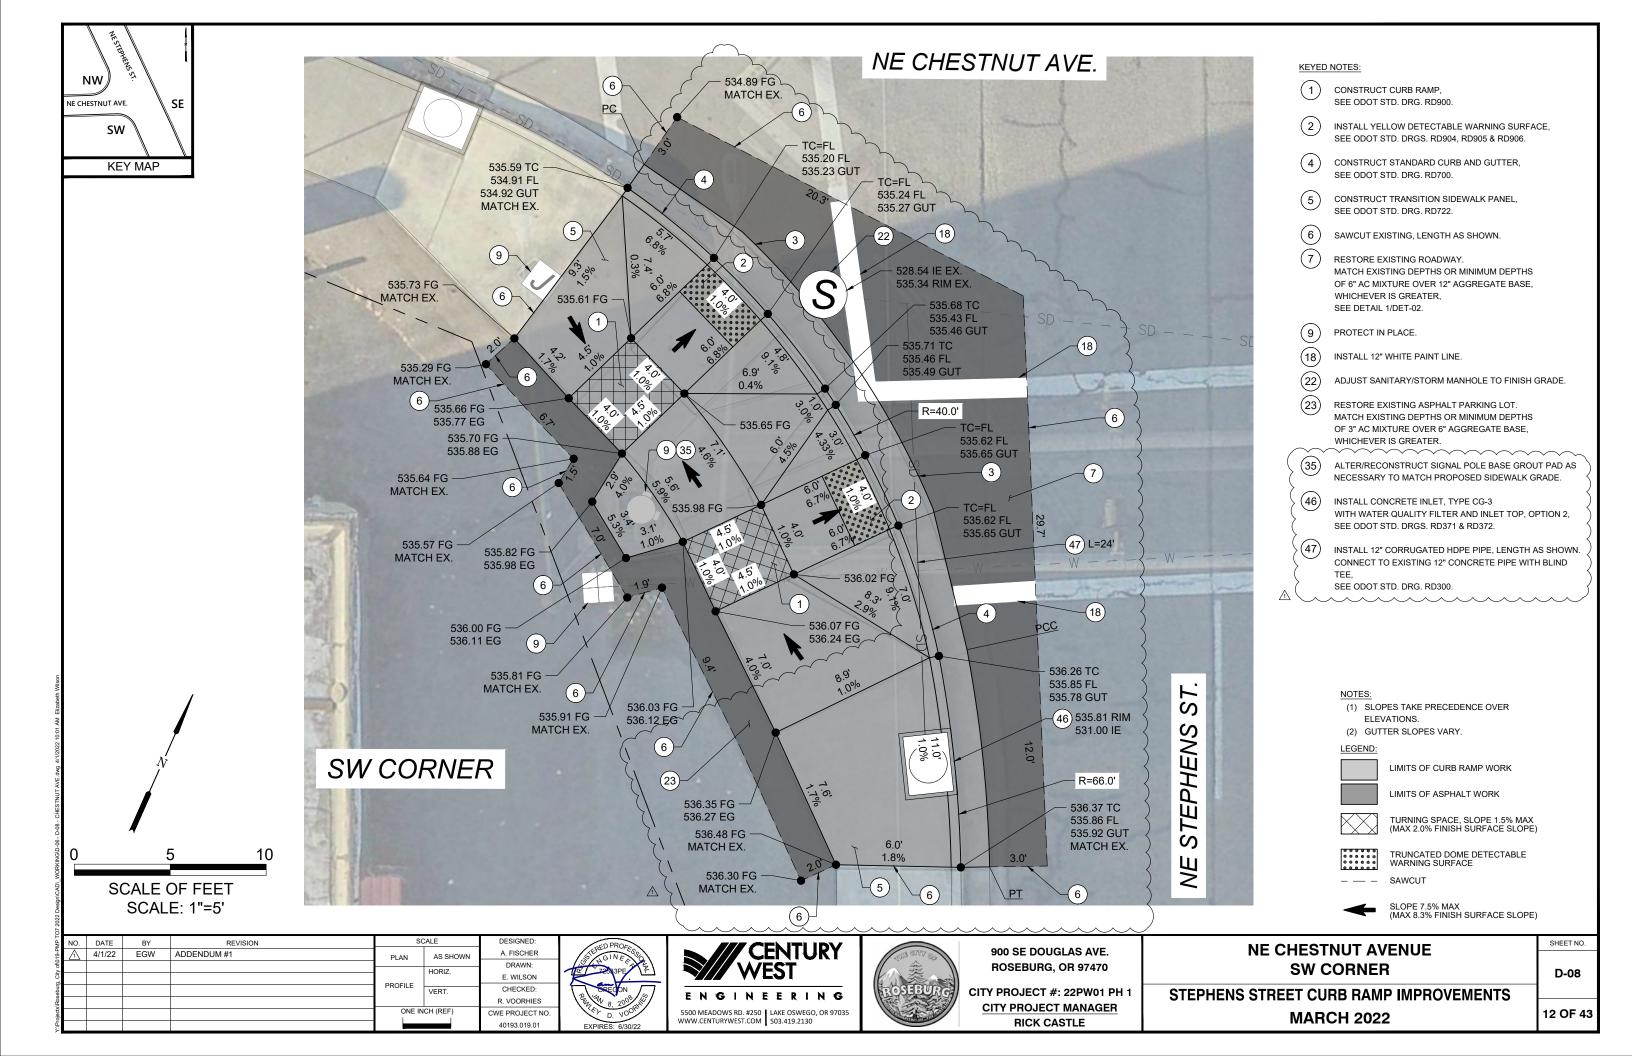

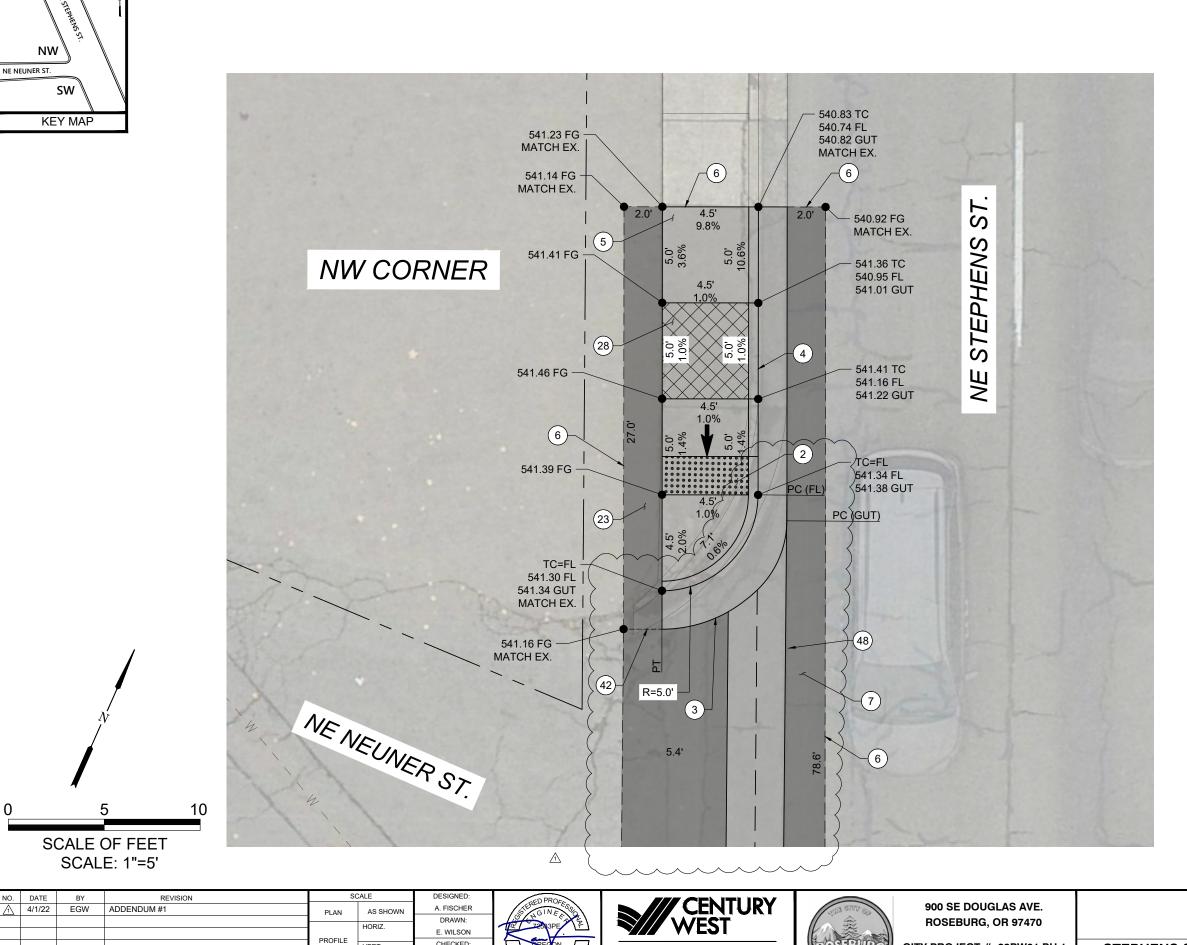

- INSTALL YELLOW DETECTABLE WARNING SURFACE, SEE ODOT STD. DRGS. RD904, RD905 & RD906.
- CONSTRUCT 2' GUTTER AT CURB RAMP LANDING/THROAT, SEE DETAIL 2/DET-02.
- CONSTRUCT STANDARD CURB AND GUTTER, SEE ODOT STD. DRG. RD700.
- CONSTRUCT TRANSITION SIDEWALK PANEL, SEE ODOT STD. DRG. RD722.
- (6) SAWCUT EXISTING, LENGTH AS SHOWN.
- RESTORE EXISTING ROADWAY. MATCH EXISTING DEPTHS OR MINIMUM DEPTHS OF 6" AC MIXTURE OVER 12" AGGREGATE BASE, WHICHEVER IS GREATER, SEE DETAIL 1/DET-02.
- RESTORE EXISTING ASPHALT PARKING LOT. MATCH EXISTING DEPTHS OR MINIMUM DEPTHS OF 3" AC MIXTURE OVER 6" AGGREGATE BASE, WHICHEVER IS GREATER.
- CONSTRUCT 6" THICK CURB RAMP, SEE ODOT STD. DRG. RD900.
- ROADWAY/PARKING LOT INTERFACE.
- (48) CONSTRUCT CONCRETE VALLEY GUTTER, 36" MODIFIED WIDTH, SEE ODOT STD. DRG. RD700.

- (1) SLOPES TAKE PRECEDENCE OVER ELEVATIONS.
- (2) GUTTER SLOPES VARY.

LEGEND:

LIMITS OF CURB RAMP WORK



LIMITS OF ASPHALT WORK



TURNING SPACE, SLOPE 1.5% MAX (MAX 2.0% FINISH SURFACE SLOPE)



TRUNCATED DOME DETECTABLE WARNING SURFACE





SLOPE 7.5% MAX (MAX 8.3% FINISH SURFACE SLOPE)

NO. DATE VERT R. VOORHIES ONE INCH (REF) CWE PROJECT NO.







CITY PROJECT #: 22PW01 PH 1 CITY PROJECT MANAGER **RICK CASTLE**


NE NEUNER STREET NW CORNER

STEPHENS STREET CURB RAMP IMPROVEMENTS **MARCH 2022**

13 OF 43

SHEET NO.

D-09

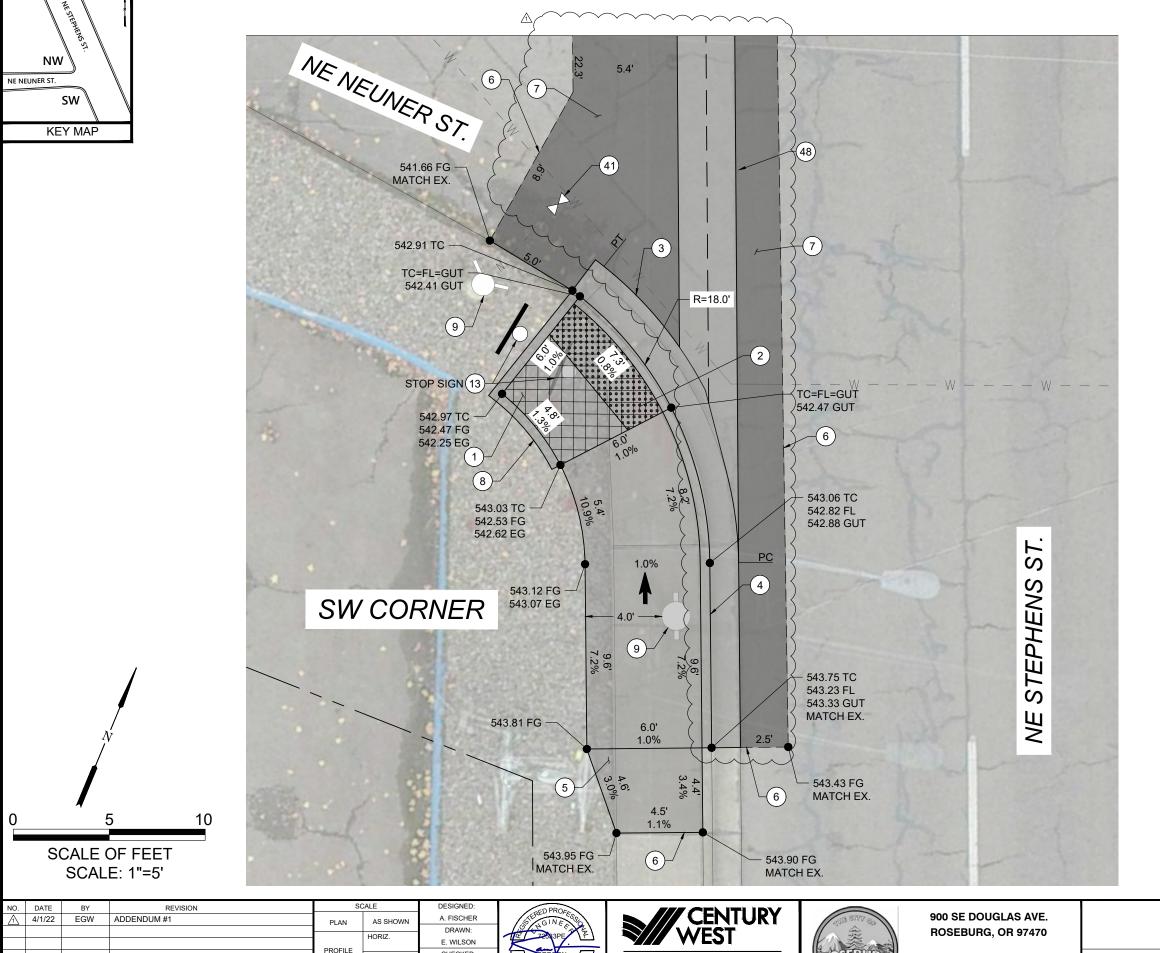

- CONSTRUCT CURB RAMP, SEE ODOT STD. DRG. RD900.
- INSTALL YELLOW DETECTABLE WARNING SURFACE, SEE ODOT STD. DRGS. RD904, RD905 & RD906.
- CONSTRUCT 2' GUTTER AT CURB RAMP LANDING/THROAT, SEE DETAIL 2/DET-02.
- CONSTRUCT STANDARD CURB AND GUTTER, SEE ODOT STD. DRG. RD700.
- CONSTRUCT TRANSITION SIDEWALK PANEL, SEE ODOT STD. DRG. RD722.
- (6) SAWCUT EXISTING, LENGTH AS SHOWN.
- RESTORE EXISTING ROADWAY. MATCH EXISTING DEPTHS OR MINIMUM DEPTHS OF 6" AC MIXTURE OVER 12" AGGREGATE BASE, WHICHEVER IS GREATER, SEE DETAIL 1/DET-02.
- CONSTRUCT PEDESTRIAN CURB, SEE DETAIL 3/DET-02.
- PROTECT IN PLACE.
- REMOVE AND RELOCATE EXISTING SIGN.
- ADJUST WATER VALVE BOX TO FINISH GRADE.
- CONSTRUCT CONCRETE VALLEY GUTTER, 36" MODIFIED WIDTH SEE ODOT STD. DRG. RD700.

- (1) SLOPES TAKE PRECEDENCE OVER ELEVATIONS.
- (2) GUTTER SLOPES VARY.

LEGEND:

LIMITS OF CURB RAMP WORK

LIMITS OF ASPHALT WORK



TURNING SPACE, SLOPE 1.5% MAX (MAX 2.0% FINISH SURFACE SLOPE)



TRUNCATED DOME DETECTABLE WARNING SURFACE

SLOPE 7.5% MAX (MAX 8.3% FINISH SURFACE SLOPE)

| NO. | DATE | BY | REVISION | | SC | ALE | DESIGNED: | Г |
|-----------|--------|-----|-------------|------|----------------|-----------------------|-----------------|---|
| Λ | 4/1/22 | EGW | ADDENDUM #1 | PLA | N | AS SHOWN HORIZ. VERT. | A. FISCHER | ı |
| | | | | | | | DRAWN: | ı |
| | | | | | | | E. WILSON | 1 |
| | | | | PROF | ILE | | CHECKED: | ı |
| | | | | | | | R. VOORHIES | ı |
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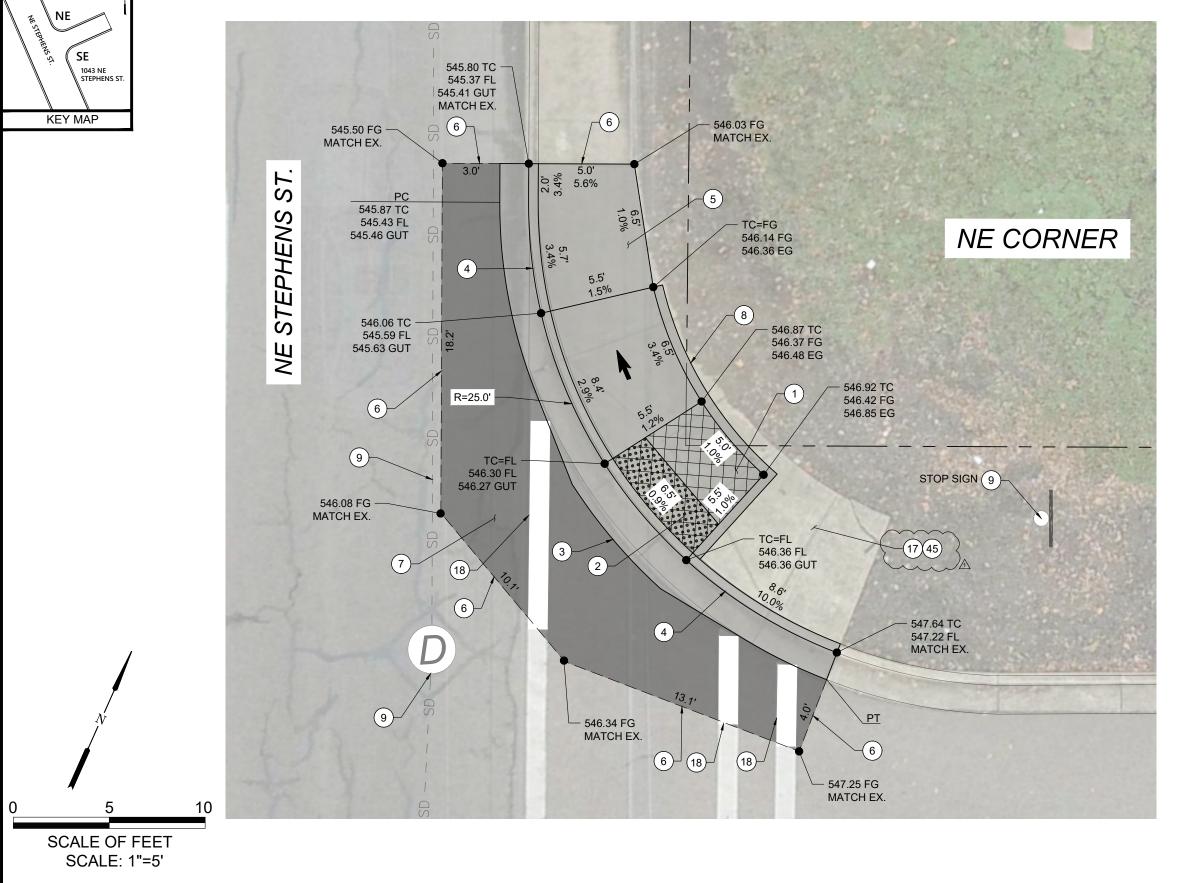
CITY PROJECT #: 22PW01 PH 1 CITY PROJECT MANAGER **RICK CASTLE**

NE NEUNER STREET SW CORNER

STEPHENS STREET CURB RAMP IMPROVEMENTS **MARCH 2022**

D-10

SHEET NO.



- (1) CONSTRUCT CURB RAMP, SEE ODOT STD. DRG. RD900.
- 2 INSTALL YELLOW DETECTABLE WARNING SURFACE, SEE ODOT STD. DRGS. RD904, RD905 & RD906.
- (3) CONSTRUCT 2' GUTTER AT CURB RAMP LANDING/THROAT, SEE DETAIL 2/DET-02.
- (4) CONSTRUCT STANDARD CURB AND GUTTER, SEE ODOT STD. DRG. RD700.
- (5) CONSTRUCT TRANSITION SIDEWALK PANEL, SEE ODOT STD. DRG. RD722.
- (6) SAWCUT EXISTING, LENGTH AS SHOWN.
- RESTORE EXISTING ROADWAY.
 MATCH EXISTING DEPTHS OR MINIMUM DEPTHS
 OF 6" AC MIXTURE OVER 12" AGGREGATE BASE,
 WHICHEVER IS GREATER,
 SEE DETAIL 1/DET-02.
- (8) CONSTRUCT PEDESTRIAN CURB, SEE DETAIL 3/DET-02.
- (9) PROTECT IN PLACE.
- 17) REMOVE EXISTING CONCRETE.
- (18) INSTALL 12" WHITE PAINT LINE.
- (45) INSTALL CRUSHED GRAVEL AS NEEDED.

NOTE

- (1) SLOPES TAKE PRECEDENCE OVER ELEVATIONS.
- (2) GUTTER SLOPES VARY.

LEGEND:

LIMITS OF CURB RAMP WORK

LIMITS OF ASPHALT WORK



TURNING SPACE, SLOPE 1.5% MAX (MAX 2.0% FINISH SURFACE SLOPE)



TRUNCATED DOME DETECTABLE WARNING SURFACE

___ _ SA\

SLOPE 7.5% MAX (MAX 8.3% FINISH SURFACE SLOPE)

NO. DATE BY REVISION

A. FISCHER

PLAN AS SHOWN

DRAWN:

HORIZ.

PROFILE

WILSON

VERT.

CHECKED:

R. VOORHIES

ONE INCH (REF)

CWE PROJECT NO.







900 SE DOUGLAS AVE. ROSEBURG, OR 97470

CITY PROJECT #: 22PW01 PH 1

CITY PROJECT MANAGER


RICK CASTLE

1043 NE STEPHENS STREET NE CORNER

STEPHENS STREET CURB RAMP IMPROVEMENTS
MARCH 2022

D-11

SHEET NO.

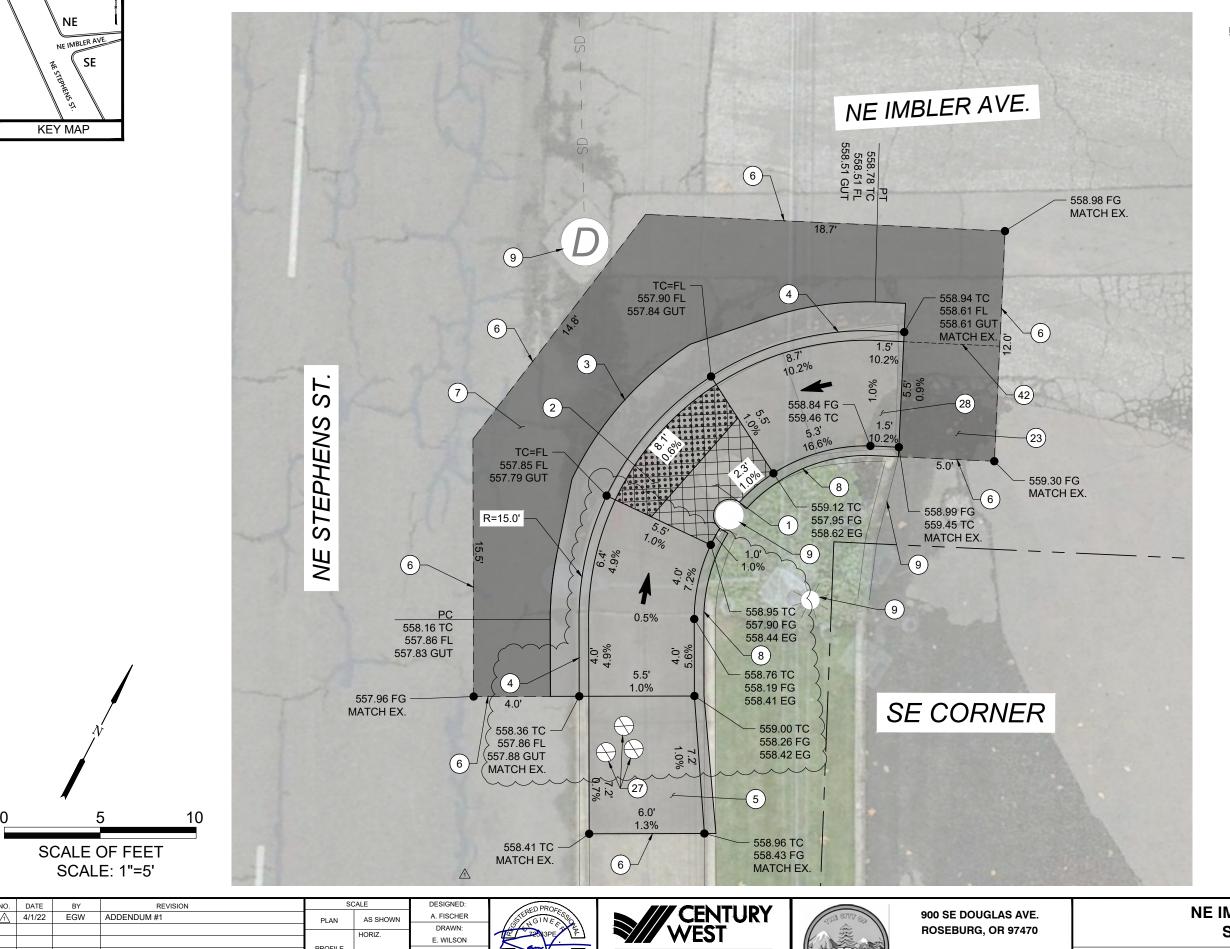

- CONSTRUCT CURB RAMP, SEE ODOT STD. DRG. RD900.
- INSTALL YELLOW DETECTABLE WARNING SURFACE, SEE ODOT STD. DRGS. RD904, RD905 & RD906.
- CONSTRUCT 2' GUTTER AT CURB RAMP LANDING/THROAT, SEE DETAIL 2/DET-02.
- CONSTRUCT STANDARD CURB AND GUTTER, SEE ODOT STD. DRG. RD700.
- SAWCUT EXISTING, LENGTH AS SHOWN.
- RESTORE EXISTING ROADWAY. MATCH EXISTING DEPTHS OR MINIMUM DEPTHS OF 6" AC MIXTURE OVER 12" AGGREGATE BASE, WHICHEVER IS GREATER, SEE DETAIL 1/DET-02.
- CONSTRUCT PEDESTRIAN CURB, SEE DETAIL 3/DET-02.
- PROTECT IN PLACE.
- RESTORE EXISTING ASPHALT PARKING LOT. MATCH EXISTING DEPTHS OR MINIMUM DEPTHS OF 3" AC MIXTURE OVER 6" AGGREGATE BASE, WHICHEVER IS GREATER.
- ADJUST GAS VALVE TO FINISH GRADE.
- (28) CONSTRUCT 6" THICK CURB RAMP, SEE ODOT STD. DRG. RD900.
- ROADWAY/PARKING LOT INTERFACE.

- (1) SLOPES TAKE PRECEDENCE OVER ELEVATIONS.
- (2) GUTTER SLOPES VARY.

LEGEND:

LIMITS OF CURB RAMP WORK



LIMITS OF ASPHALT WORK



TURNING SPACE, SLOPE 1.5% MAX (MAX 2.0% FINISH SURFACE SLOPE)



TRUNCATED DOME DETECTABLE WARNING SURFACE





SLOPE 7.5% MAX (MAX 8.3% FINISH SURFACE SLOPE)

NO. DATE 1/1/22 EGW PROFILE VERT R. VOORHIES ONE INCH (REF CWE PROJECT NO.








CITY PROJECT #: 22PW01 PH 1 **CITY PROJECT MANAGER RICK CASTLE**

NE IMBLER AVENUE SE CORNER

STEPHENS STREET CURB RAMP IMPROVEMENTS **MARCH 2022**

SHEET NO. D-14

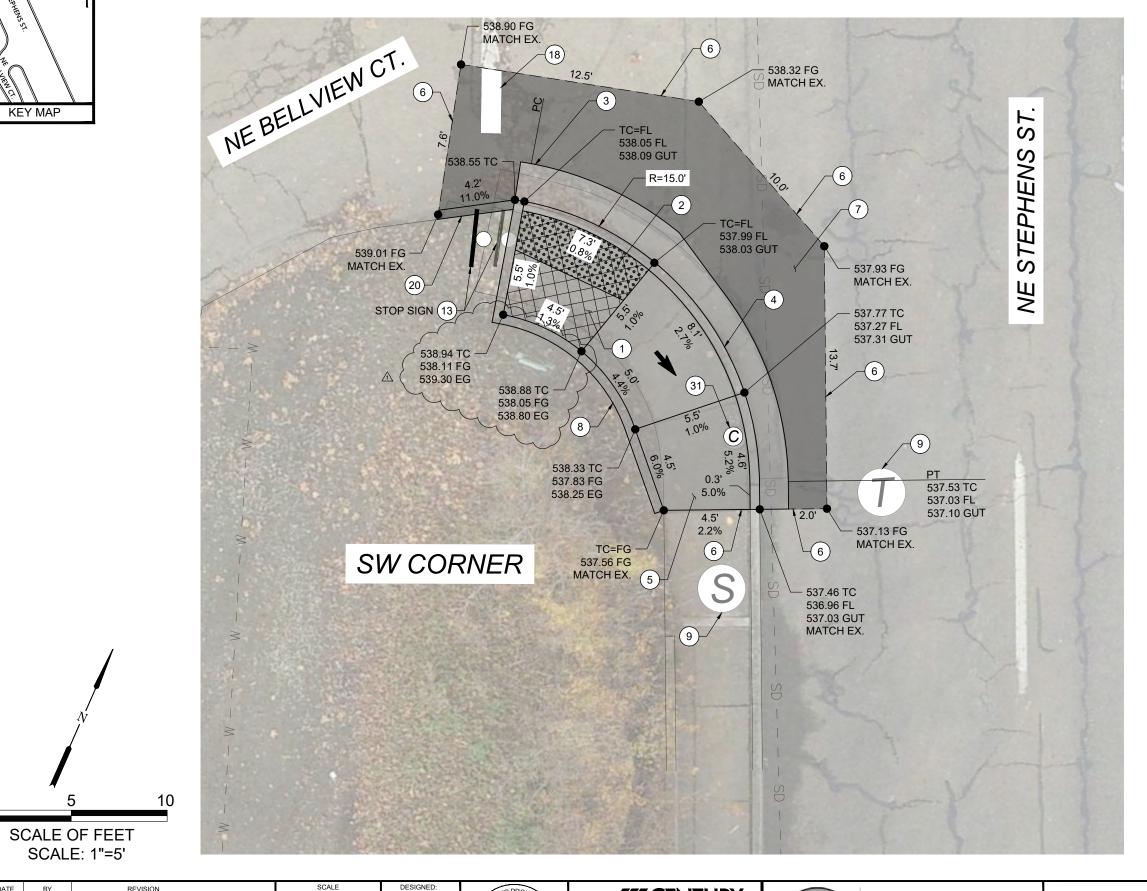

- CONSTRUCT CURB RAMP, SEE ODOT STD. DRG. RD900.
- INSTALL YELLOW DETECTABLE WARNING SURFACE, SEE ODOT STD. DRGS. RD904, RD905 & RD906.
- CONSTRUCT 2' GUTTER AT CURB RAMP LANDING/THROAT, SEE DETAIL 2/DET-02.
- CONSTRUCT STANDARD CURB AND GUTTER, SEE ODOT STD. DRG. RD700.
- CONSTRUCT TRANSITION SIDEWALK PANEL, SEE ODOT STD. DRG. RD722.
- (6) SAWCUT EXISTING, LENGTH AS SHOWN.
- (7)RESTORE EXISTING ROADWAY. MATCH EXISTING DEPTHS OR MINIMUM DEPTHS OF 6" AC MIXTURE OVER 12" AGGREGATE BASE, WHICHEVER IS GREATER, SEE DETAIL 1/DET-02.
- CONSTRUCT PEDESTRIAN CURB, SEE DETAIL 3/DET-02.
- (9) PROTECT IN PLACE.
- (13) REMOVE AND RELOCATE EXISTING SIGN.
- (18) INSTALL 12" WHITE PAINT LINE.
- (20) CONSTRUCT ASPHALT BERM. MATCH CROSS-SECTION OF EXISTING BERM.
 - ADJUST SANITARY SEWER CLEANOUT TO FINISH GRADE.

- (1) SLOPES TAKE PRECEDENCE OVER ELEVATIONS.
- (2) GUTTER SLOPES VARY.

LEGEND:

LIMITS OF CURB RAMP WORK

LIMITS OF ASPHALT WORK



TURNING SPACE, SLOPE 1.5% MAX (MAX 2.0% FINISH SURFACE SLOPE)



TRUNCATED DOME DETECTABLE WARNING SURFACE

SLOPE 7.5% MAX (MAX 8.3% FINISH SURFACE SLOPE)

| NO. | DATE | BY | REVISION | SCALE | | DESIGNED: |
|-----|--------|-----|-------------|----------------|----------|-----------------|
| 1 | 4/1/22 | EGW | ADDENDUM #1 | PLAN | AS SHOWN | A. FISCHER |
| | | | | | | DRAWN: |
| | | | | | HORIZ. | E. WILSON |
| 5 | | | | PROFILE | | E. WILSON |
| | | | | PROFILE | VERT. | CHECKED: |
| | | | | | | R. VOORHIES |
| | | | | ONE INCH (REF) | | CWE PROJECT NO. |
| | | | | | | 40193.019.01 |








900 SE DOUGLAS AVE. **ROSEBURG, OR 97470**

CITY PROJECT #: 22PW01 PH 1 CITY PROJECT MANAGER **RICK CASTLE**

NE BELLVIEW COURT SW CORNER

STEPHENS STREET CURB RAMP IMPROVEMENTS **MARCH 2022**

SHEET NO. D-16

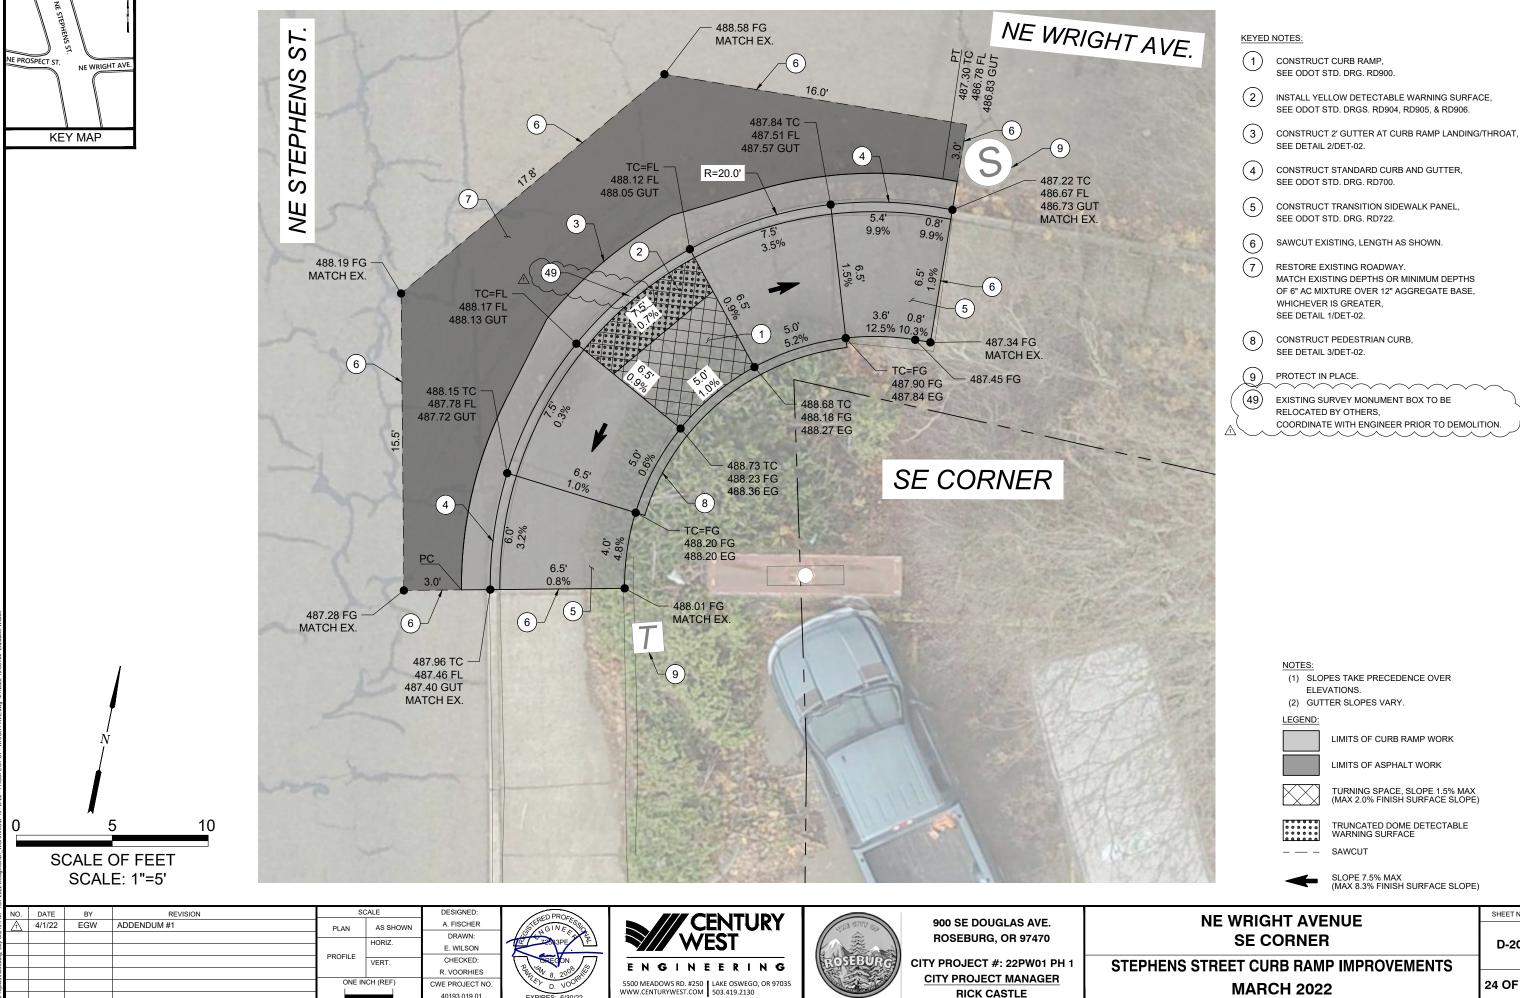



RICK CASTLE


24 OF 43

SHEET NO.

D-20

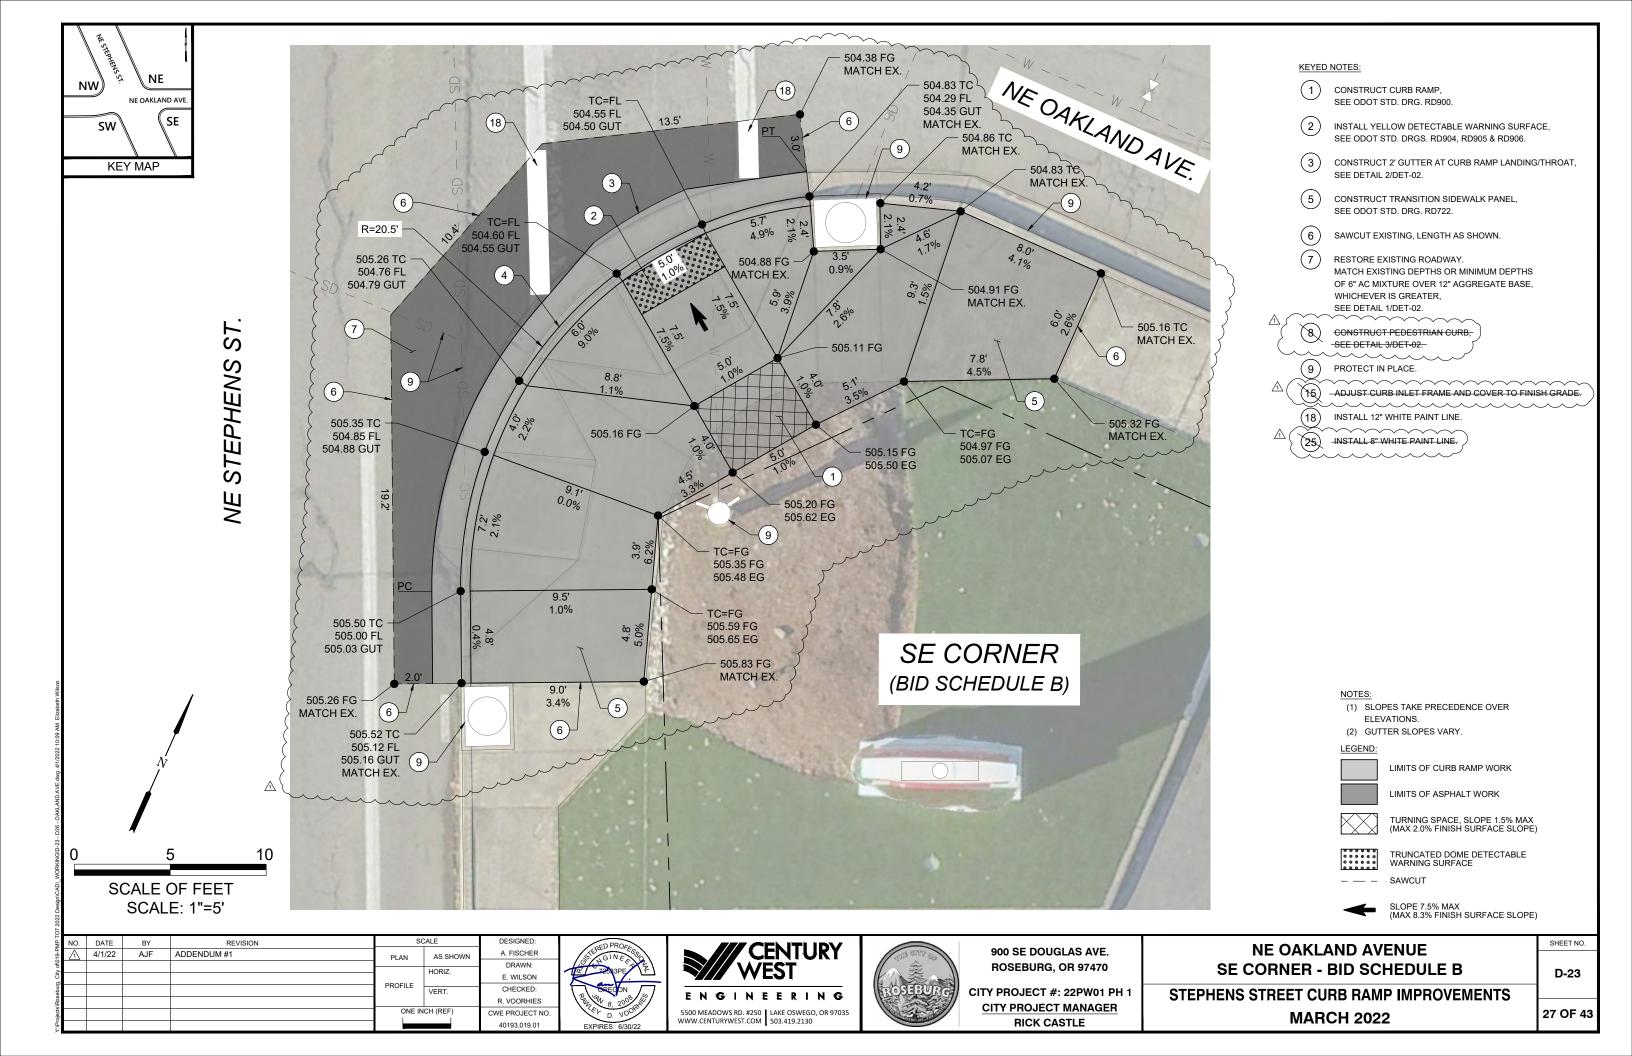

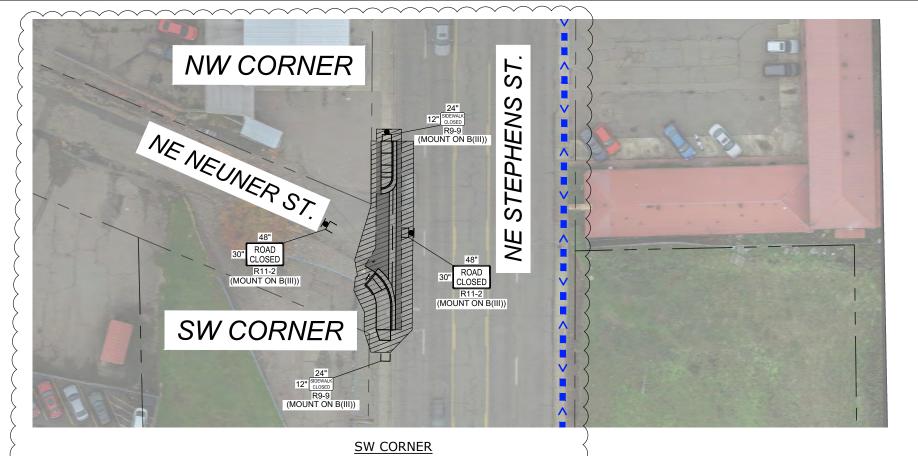

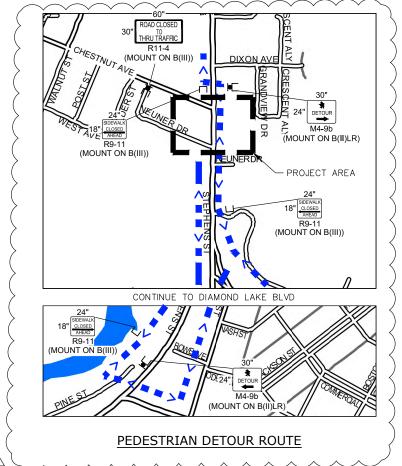

NOTE:

NE NEUNER STREET MAY BE CLOSED AS SHOWN FOR DURATION OF RAMP CLOSURES FOR CONSTRUCTION. CLOSURE SHALL BE A MAXIMUM OF 14 DAYS AND SHALL BE IN ACCORDANCE WITH SECTION 00220.40(e) OF THE SPECIAL PROVISION.

0 0 40 80

SCALE OF FEET
SCALE: 1"=40'

| ₹ | NO. | DATE | BY BY | REVISION | SCALE | | DESIGNED: | |
|---------|-----|--------|-------|-------------|----------------|-----------|-----------------|---|
| 19-PI | Λ | 4/1/22 | EGW | ADDENDUM #1 | PLAN | AS SHOWN | A. FISCHER | ı |
| of O | | | | | | | DRAWN: | ı |
| City | | | | | HORIZ. | E. WILSON | 1 | |
| II. | | | | | PROFILE | | | ı |
| sebı | | | | | | VERT. | CHECKED: | ı |
| Š | | | | | | | R. VOORHIES | |
| jects | | | | | ONE INCH (REF) | | CWE PROJECT NO. | ı |
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900 SE DOUGLAS AVE.
ROSEBURG, OR 97470


CITY PROJECT #: 22PW01 PH 1
CITY PROJECT MANAGER
RICK CASTLE

| TRAFFIC CONTROL PLAN - NEUNER STREET |
|--------------------------------------|
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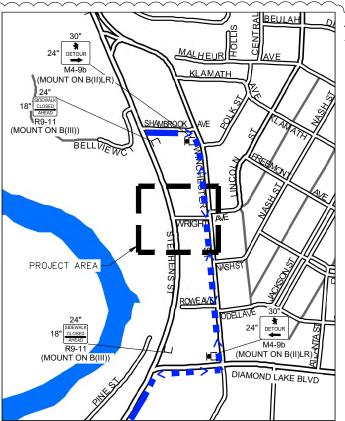
STEPHENS STREET CURB RAMP IMPROVEMENTS
MARCH 2022

TC-06

SHEET NO.

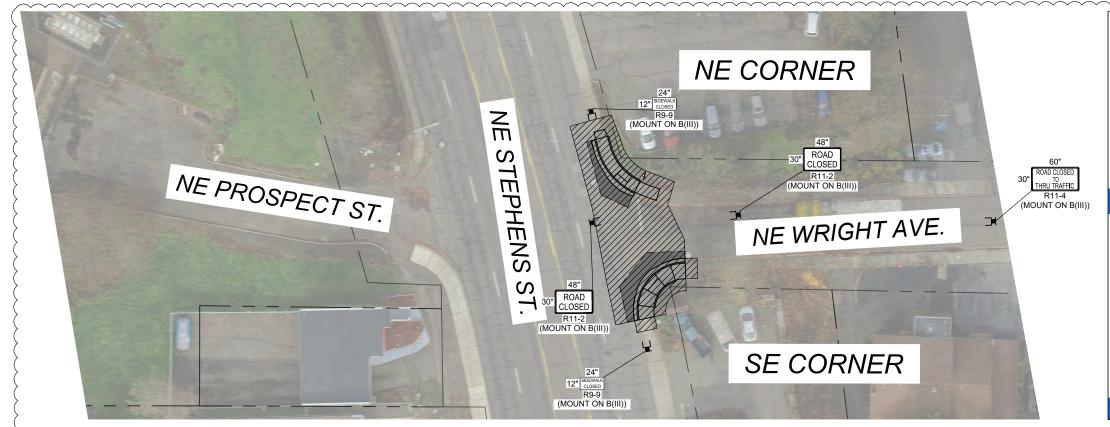


NE CORNER



PEDESTRIAN DETOUR ROUTE

NOTE:

NE WRIGHT AVENUE MAY BE CLOSED AS SHOWN DURING ACTIVE CONSTRUCTION SHIFTS. ROADWAY SHALL BE REOPENED TO 2-LANE, 2-WAY TRAFFIC DURING OFF-SHIFT HOURS.

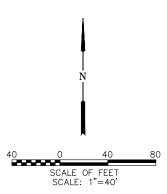

| ÷I | NO. | DATE | BY | REVISION | SCALE | | DESIGNED: |
|--------------------------------------|-----|--------|-----|-------------|----------------|----------|-----------------|
| :\Projects\Roseburg, City of\019-PMP | 1 | 4/1/22 | EGW | ADDENDUM #1 | PLAN | AS SHOWN | A. FISCHER |
| 8 | | | | | | | DRAWN: |
| ⋛ | | | | | | HORIZ. | E. WILSON |
| ь Б | | | | | PROFILE | | E. WILSON |
| e pri | | | | | PROFILE | VERT. | CHECKED: |
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| jects | | | | | ONE INCH (REF) | | CWE PROJECT NO. |
| :\Pro | | | | | | | 40193.019.01 |







900 SE DOUGLAS AVE. ROSEBURG, OR 97470

CITY PROJECT #: 22PW01 PH 1
CITY PROJECT MANAGER
RICK CASTLE

| TRAFFIC CONTROL PLAN - WRIGHT AVENUE |
|---|
| STEPHENS STREET CURB RAMP IMPROVEMENTS |
| MARCH 2022 |

TC-11

